

CONSTRUCTION DOCUMENTS

EXPANSION AND RENOVATION Warsaw Public Library

130 North Main Street
Warsaw, New York

FOR

Town of Warsaw

83 Center Street
Warsaw, NY 14569



bero
ARCHITECTURE

32 Winthrop Street, Rochester, NY 14607
(585) 262-2035 | www.beroarchitecture.com

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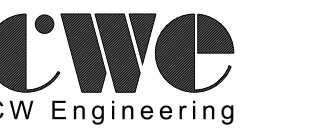
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STRUCTURAL ENGINEER:



1653 East Main Street
Rochester, NY 14609

MEP / FP ENGINEER:



315 Rockingham Street
Rochester, NY 14620

PROJECT TEAM:				
PROJECT	OWNER	ARCHITECT	STRUCTURAL ENGINEER	MECHANICAL ENGINEER
130 North Main Street, Warsaw, NY 14569 (585) 786-5650 www.warsawpubliclibrary.org	83 Center Street, Warsaw, NY 14569 (585) 786-2800 www.townofwarsawny.org	32 Winthrop Street, Rochester, NY 14607 (585) 262-2035 www.beroarchitecture.com	1653 E Main Street, Rochester, NY 14609 (585) 482-8130 www.jensenbrv.com	128 Hogen Road, Fairport, NY 14450 (585) 223-2462

PROJECT LOCATION:	INDEX OF DRAWINGS:
	<ul style="list-style-type: none"> T-10 Tile Sheet CS-10 Code Study A-01 Site and Staging Plan C-1 Site Plan for Water Service Replacement C-2 Detail Sheet S-001 General Notes S-101 Framing Plan S-500 Structural Details D-10 Main & Lower Level Demolition Plan A-10 Lower Level Floor Plan & Reflected Ceiling Plan A-11 Main Level Floor Plan & Reflected Ceiling Plan A-40 Lower Level Interior Elevations A-41 Main Level Interior Elevations A-50 Enlarged Plans & Details A-60 Schedules & Details P-10 Plumbing F-10 Fire Protection Sprinkler M-01 Removals M-11 Lower Level M-12 Main Level E-01 Removals E-11 Lower Level E-12 Main Level

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Town of Warsaw
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Warsaw, NY 14569

PROJECT INFORMATION:

Expansion and Renovation
Warsaw Public Library
130 North Main Street, Warsaw, New York

PROJECT NUMBER: 22121

ISSUE DATE: February 25, 2025

DRAWN BY: LMY

SHEET TITLE:


Title Sheet

SHEET NUMBER:


T-10

ABBREVIATIONS	MATERIALS KEY	SYMBOLS
<p>abv Above</p> <p>aff Above Finish Floor</p> <p>addl Additional</p> <p>adj Adjust / Adjacent</p> <p>a/c Air Conditioning</p> <p>alt Alternate</p> <p>al Aluminum</p> <p>approx Approximate</p> <p>bsmt Basement</p> <p>brg Bearing</p> <p>bm Bench Mark</p> <p>blwn Between</p> <p>blkg Blocking</p> <p>bd Board</p> <p>bw Both Ways</p> <p>bot Bottom</p> <p>brdg Bridging</p> <p>bdg Building</p> <p>cab Cabinet</p> <p>cpt Carpet</p> <p>cont Casement</p> <p>cb Catch Basin</p> <p>clg Ceiling</p> <p>ctr Center</p> <p>c/c Center to Center</p> <p>cl Ceramic Tile</p> <p>co Clean Out</p> <p>cls Closet</p> <p>col Column</p> <p>conc Concrete</p> <p>cmu Concrete Masonry Unit</p> <p>csj Construction Joint</p> <p>cont Continuous</p> <p>cj Control Joint</p> <p>cu Copper</p> <p>cmp Corrugated Metal Pipe</p> <p>crs Courses</p> <p>det Detail</p> <p>dia Diameter</p> <p>dim Dimension</p> <p>dw Dishwasher</p> <p>dbl Double</p> <p>dh Double Hung (Window)</p> <p>dn Down</p> <p>ds Downspout</p> <p>dwg Drawing</p> <p>df Drinking Fountain</p> <p>ea Each</p> <p>elec Electrical</p> <p>elev Elevation</p> <p>eq Equal</p> <p>equip Equipment</p> <p>exh Exhaust</p> <p>exg Existing</p> <p>expi Expansion Joint</p> <p>ext Exterior</p> <p>fof Face Of Finish</p> <p>fom Face Of Masonry</p> <p>fos Face Of Sluds</p> <p>fin Finish(ed)</p> <p>fc Finish Coat</p> <p>fr Floor</p> <p>fd Floor Drain</p> <p>ft Foot or Feet</p> <p>ftg Footing</p> <p>fund Foundation</p> <p>frz Freezer</p> <p>furn Furnace</p> <p>galv Galvanized</p> <p>ga Gauge</p> <p>gl Glass or Glazing</p> <p>gfi Ground Fault Interrupter</p> <p>gpdw Gypsum Drywall</p> <p>hcp Handicap</p> <p>hdw Hardware</p> <p>hdr Header</p> <p>hgt Height</p> <p>hr Heater</p> <p>hvac Heating / Ventilation / Air Conditioning</p> <p>hm Hollow Metal</p> <p>horiz Horizontal</p> <p>hb Hose Bib</p> <p>in Inch</p> <p>id Inside Diameter</p> <p>insul Insulation</p> <p>int Interior</p> <p>inv Invert</p> <p>isgl Isolation Joint</p> <p>jt Joint</p> <p>jst Joist</p> <p>lev Levatory</p> <p>lf Linear Foot</p> <p>lv Laminated Veneer Lumber</p> <p>mfr Manufacturer</p> <p>mo Masonry Opening</p> <p>mat Material</p> <p>max Maximum</p> <p>mch Mechanical</p> <p>mil Metal</p> <p>min Minimum</p> <p>misc Miscellaneous</p> <p>nom Nominal</p> <p>n/a Not Applicable</p> <p>nic Not In Contract</p> <p>nts Not To Scale</p> <p>no. # Number</p> <p>oc On Center</p> <p>opng Opening</p> <p>opp Opposite</p> <p>oz Ounce</p> <p>od Outside Diameter</p> <p>ovhd Overhead</p> <p>pr Pair</p> <p>pnl Panel</p> <p>pnt Paint(ed)</p> <p>d Penny (nails)</p> <p>perf Perforated</p> <p>plst Plaster</p> <p>plam Plastic Laminated</p> <p>pl Plate</p> <p>ply Plywood</p> <p>pvc Polyvinyl Chloride</p> <p>psf Pounds per Square Foot</p> <p>pspi Pounds per Square Inch</p> <p>pt Pressure Treated</p> <p>prov Provide</p> <p>qty Quantity</p> <p>qt Quarry Tile</p> <p>rad Radius</p> <p>refr Refrigerator</p> <p>reinf Reinforce(d)/Reinforcing</p> <p>rcp Reinforced Concrete Pipe</p> <p>rvt Reinforced Vinyl Tile</p> <p>reqd Required</p> <p>ra Return Air</p> <p>rev Revision/Revised</p> <p>rd Roof Drain</p> <p>rm Room</p> <p>ro Rough Opening</p> <p>rbr Rubber</p> <p>san Sanitary</p> <p>shsh Sheathing</p> <p>shr Shower</p> <p>sim Similar</p> <p>spec Specification</p> <p>sf Square Foot</p> <p>std Standard</p> <p>stin Stain(ed)</p> <p>ss Stainless Steel</p> <p>stl Steel</p> <p>str Structural</p> <p>susp Suspended</p> <p>tmpd Tempered</p> <p>thk Thickness</p> <p>t&g Tongue and Groove</p> <p>tof Top Of Foundation</p> <p>topl Top Of Plate</p> <p>los Top Of Steel</p> <p>low Top Of Wall</p> <p>trans Transparent</p> <p>typ Typical</p> <p>uon Unless Otherwise Noted</p> <p>vr Vapor Retarder</p> <p>vf Verify In Field</p> <p>vert Vertical</p> <p>wc Water Closet</p> <p>wp Waterproof</p> <p>wl Weight</p> <p>wfw Welded Wire Fabric</p> <p>w/ With</p> <p>w/o Without</p> <p>wd Wood</p>	<p>Earth</p> <p>Porous Fill</p> <p>Concrete</p> <p>Welded Wire Fabric</p> <p>Brick/Clay Unit Masonry</p> <p>Concrete Unit Masonry</p> <p>Steel (small scale dwg)</p> <p>Steel (large scale dwg)</p> <p>Wood (rough)</p> <p>Wood blocking</p> <p>Plywood</p> <p>Wood (finish)</p> <p>Ball Insulation</p> <p>Rigid Insulation</p> <p>New frame wall</p>	<p>Demolition Note</p> <p>General Work Note</p> <p>Revision</p> <p>Restroom</p> <p>Room Identifier</p> <p>Door Number</p> <p>Window Type</p> <p>Wall Type</p> <p>Spot Elevation</p> <p>Elevation</p> <p>Property Line</p> <p>Gridline</p> <p>Contour Lines</p> <p>Building Elevation</p> <p>Section</p> <p>Interior Elevation</p> <p>Detail Callout</p>


ARCHITECT'S CERTIFICATION STATEMENT	
<p>"The Architect certifies that this project has been designed by me, or under my supervision, in accordance with the NYS Uniform Code and New York State Supplement, latest version, the International Energy Conservation Code with the New York State Supplement (latest version), and applicable federal, state and local laws, codes, and regulations, and to the best of my knowledge and belief, these documents are in conformance therewith."</p>	
Registered Architect	NYS Reg. No. _____ Date _____

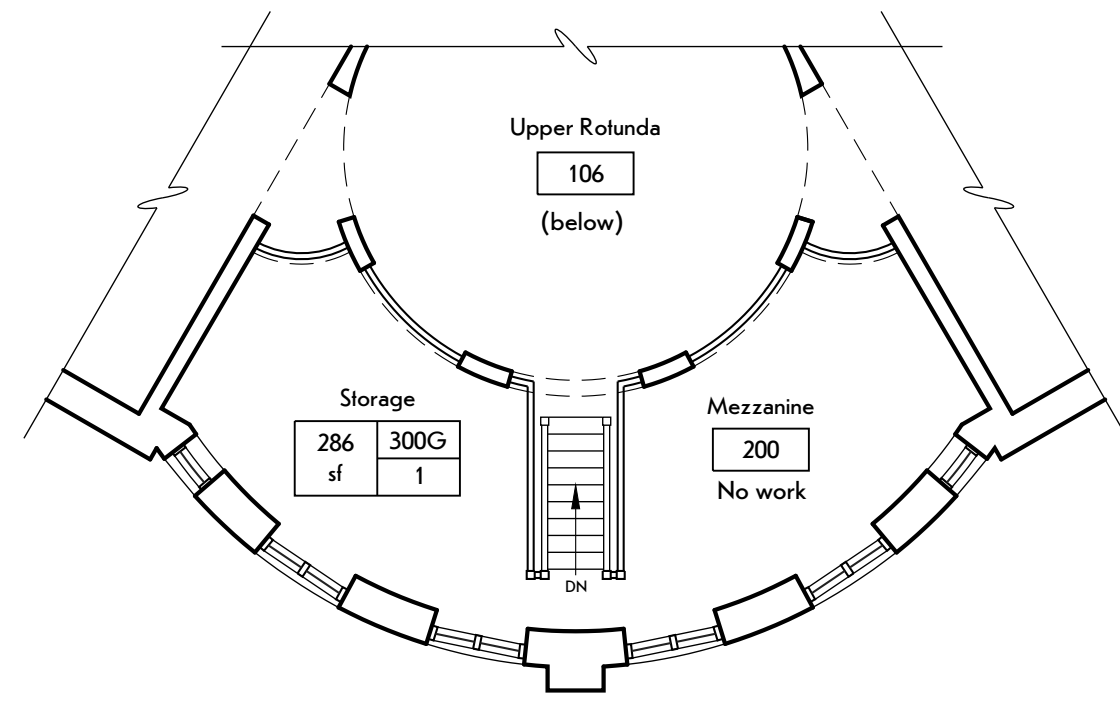


project N
4 Mezzanine
 SCALE: 1/8" = 1'-0"

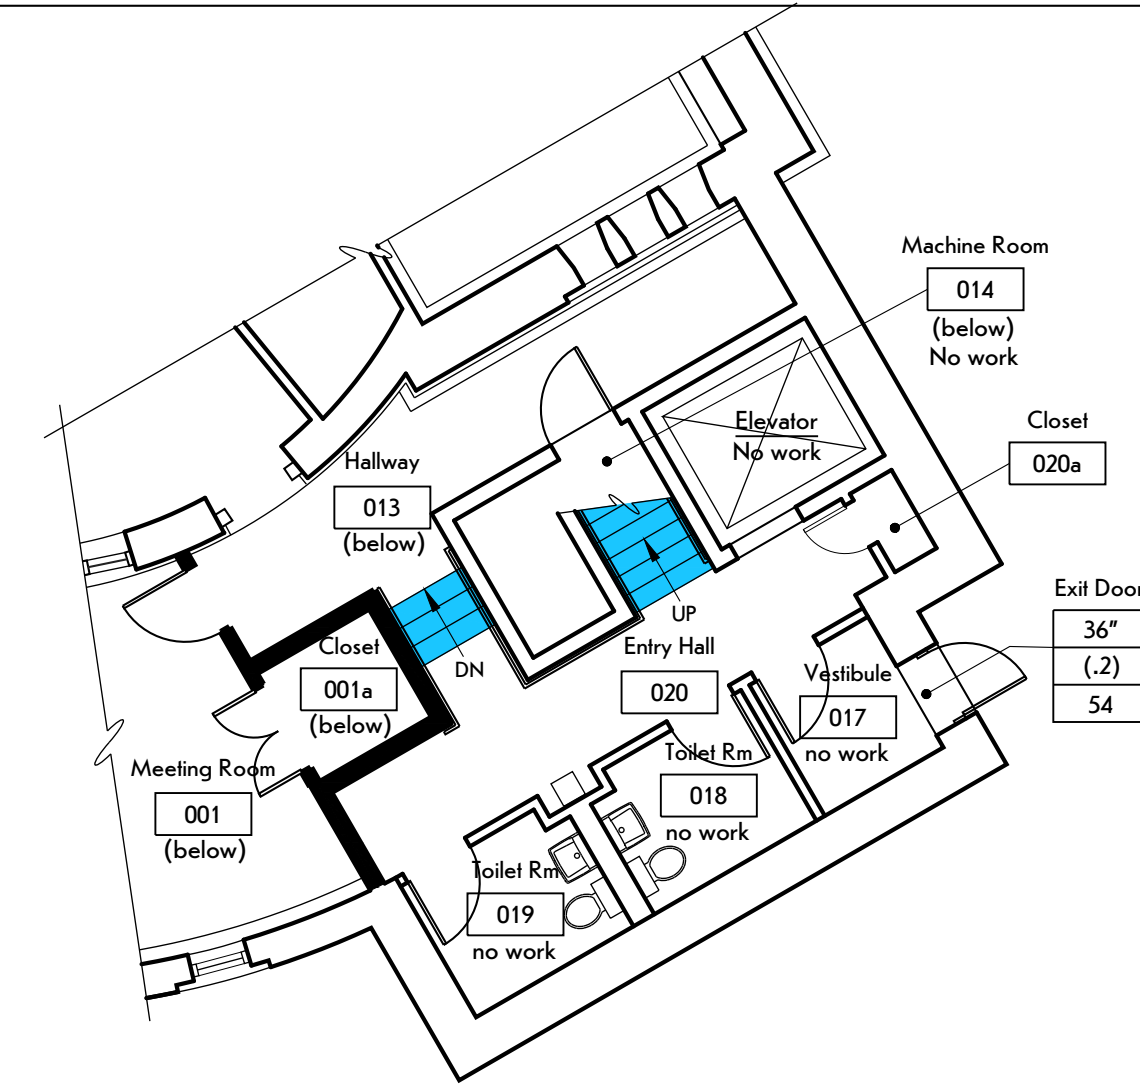

project N
3 Intermediate, Grade Level Floor Plan
 SCALE: 1/8" = 1'-0"

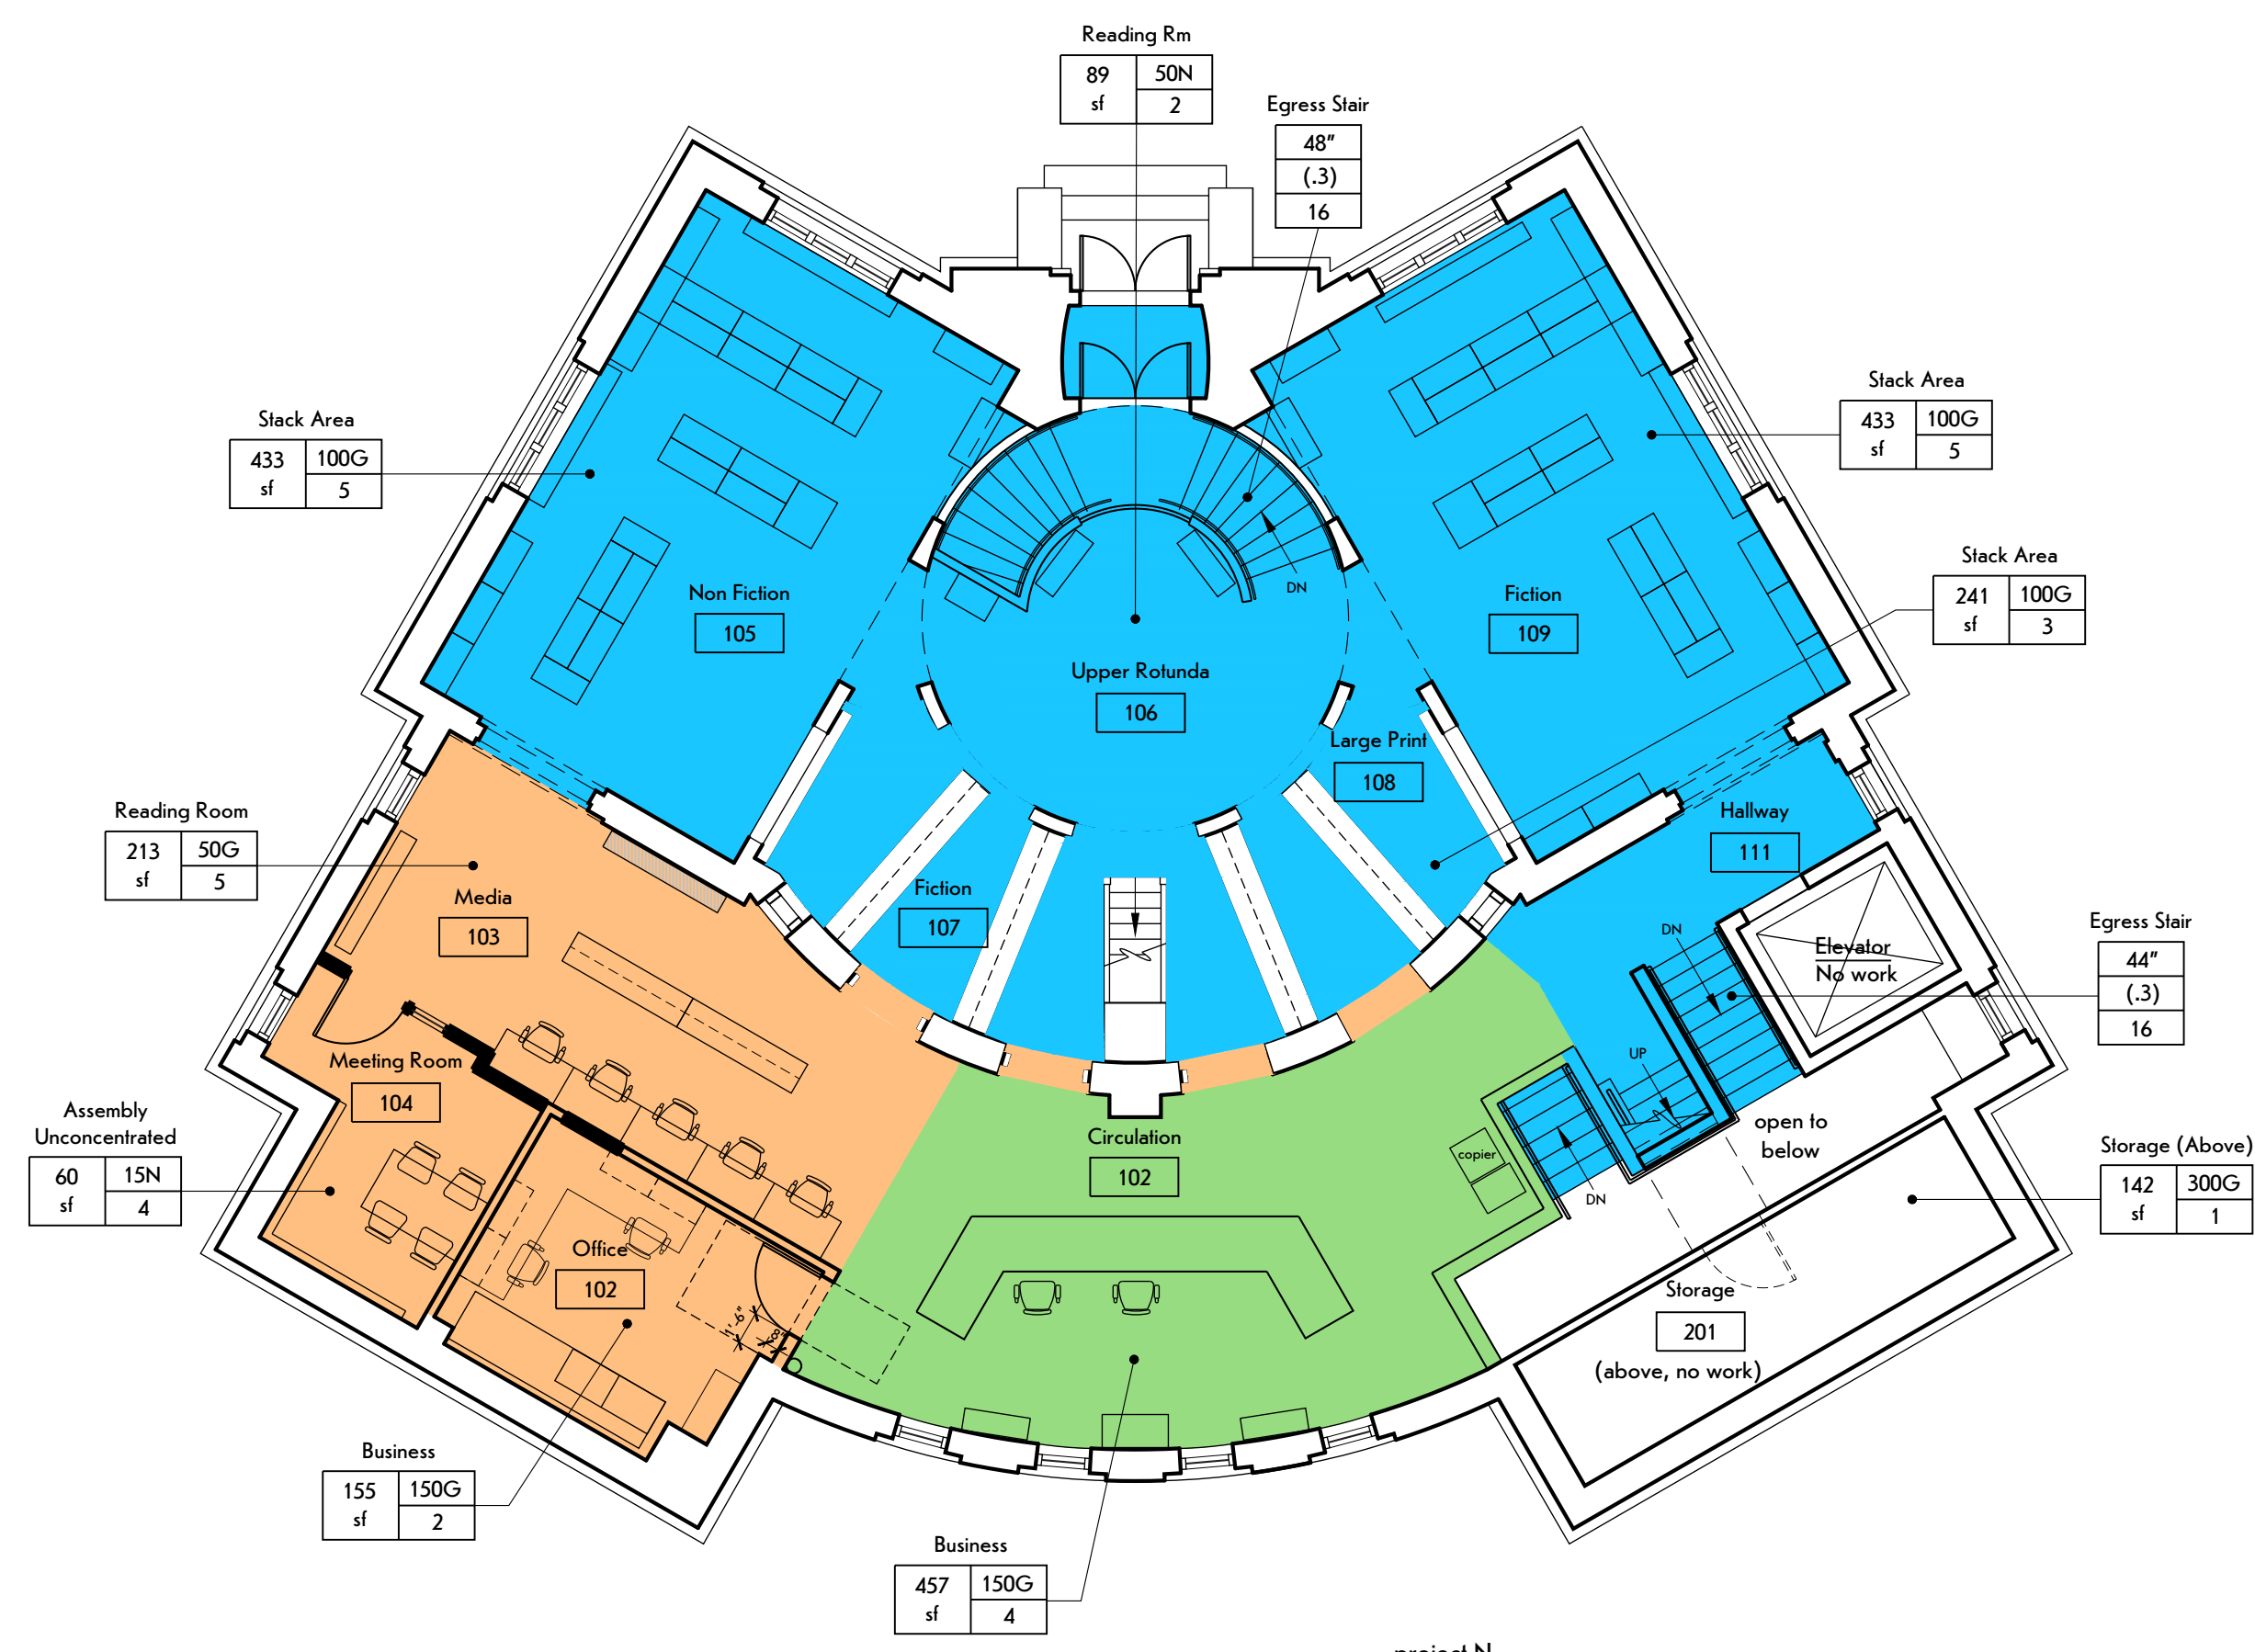

project N
2 Main Level Floor Plan
 SCALE: 1/8" = 1'-0"

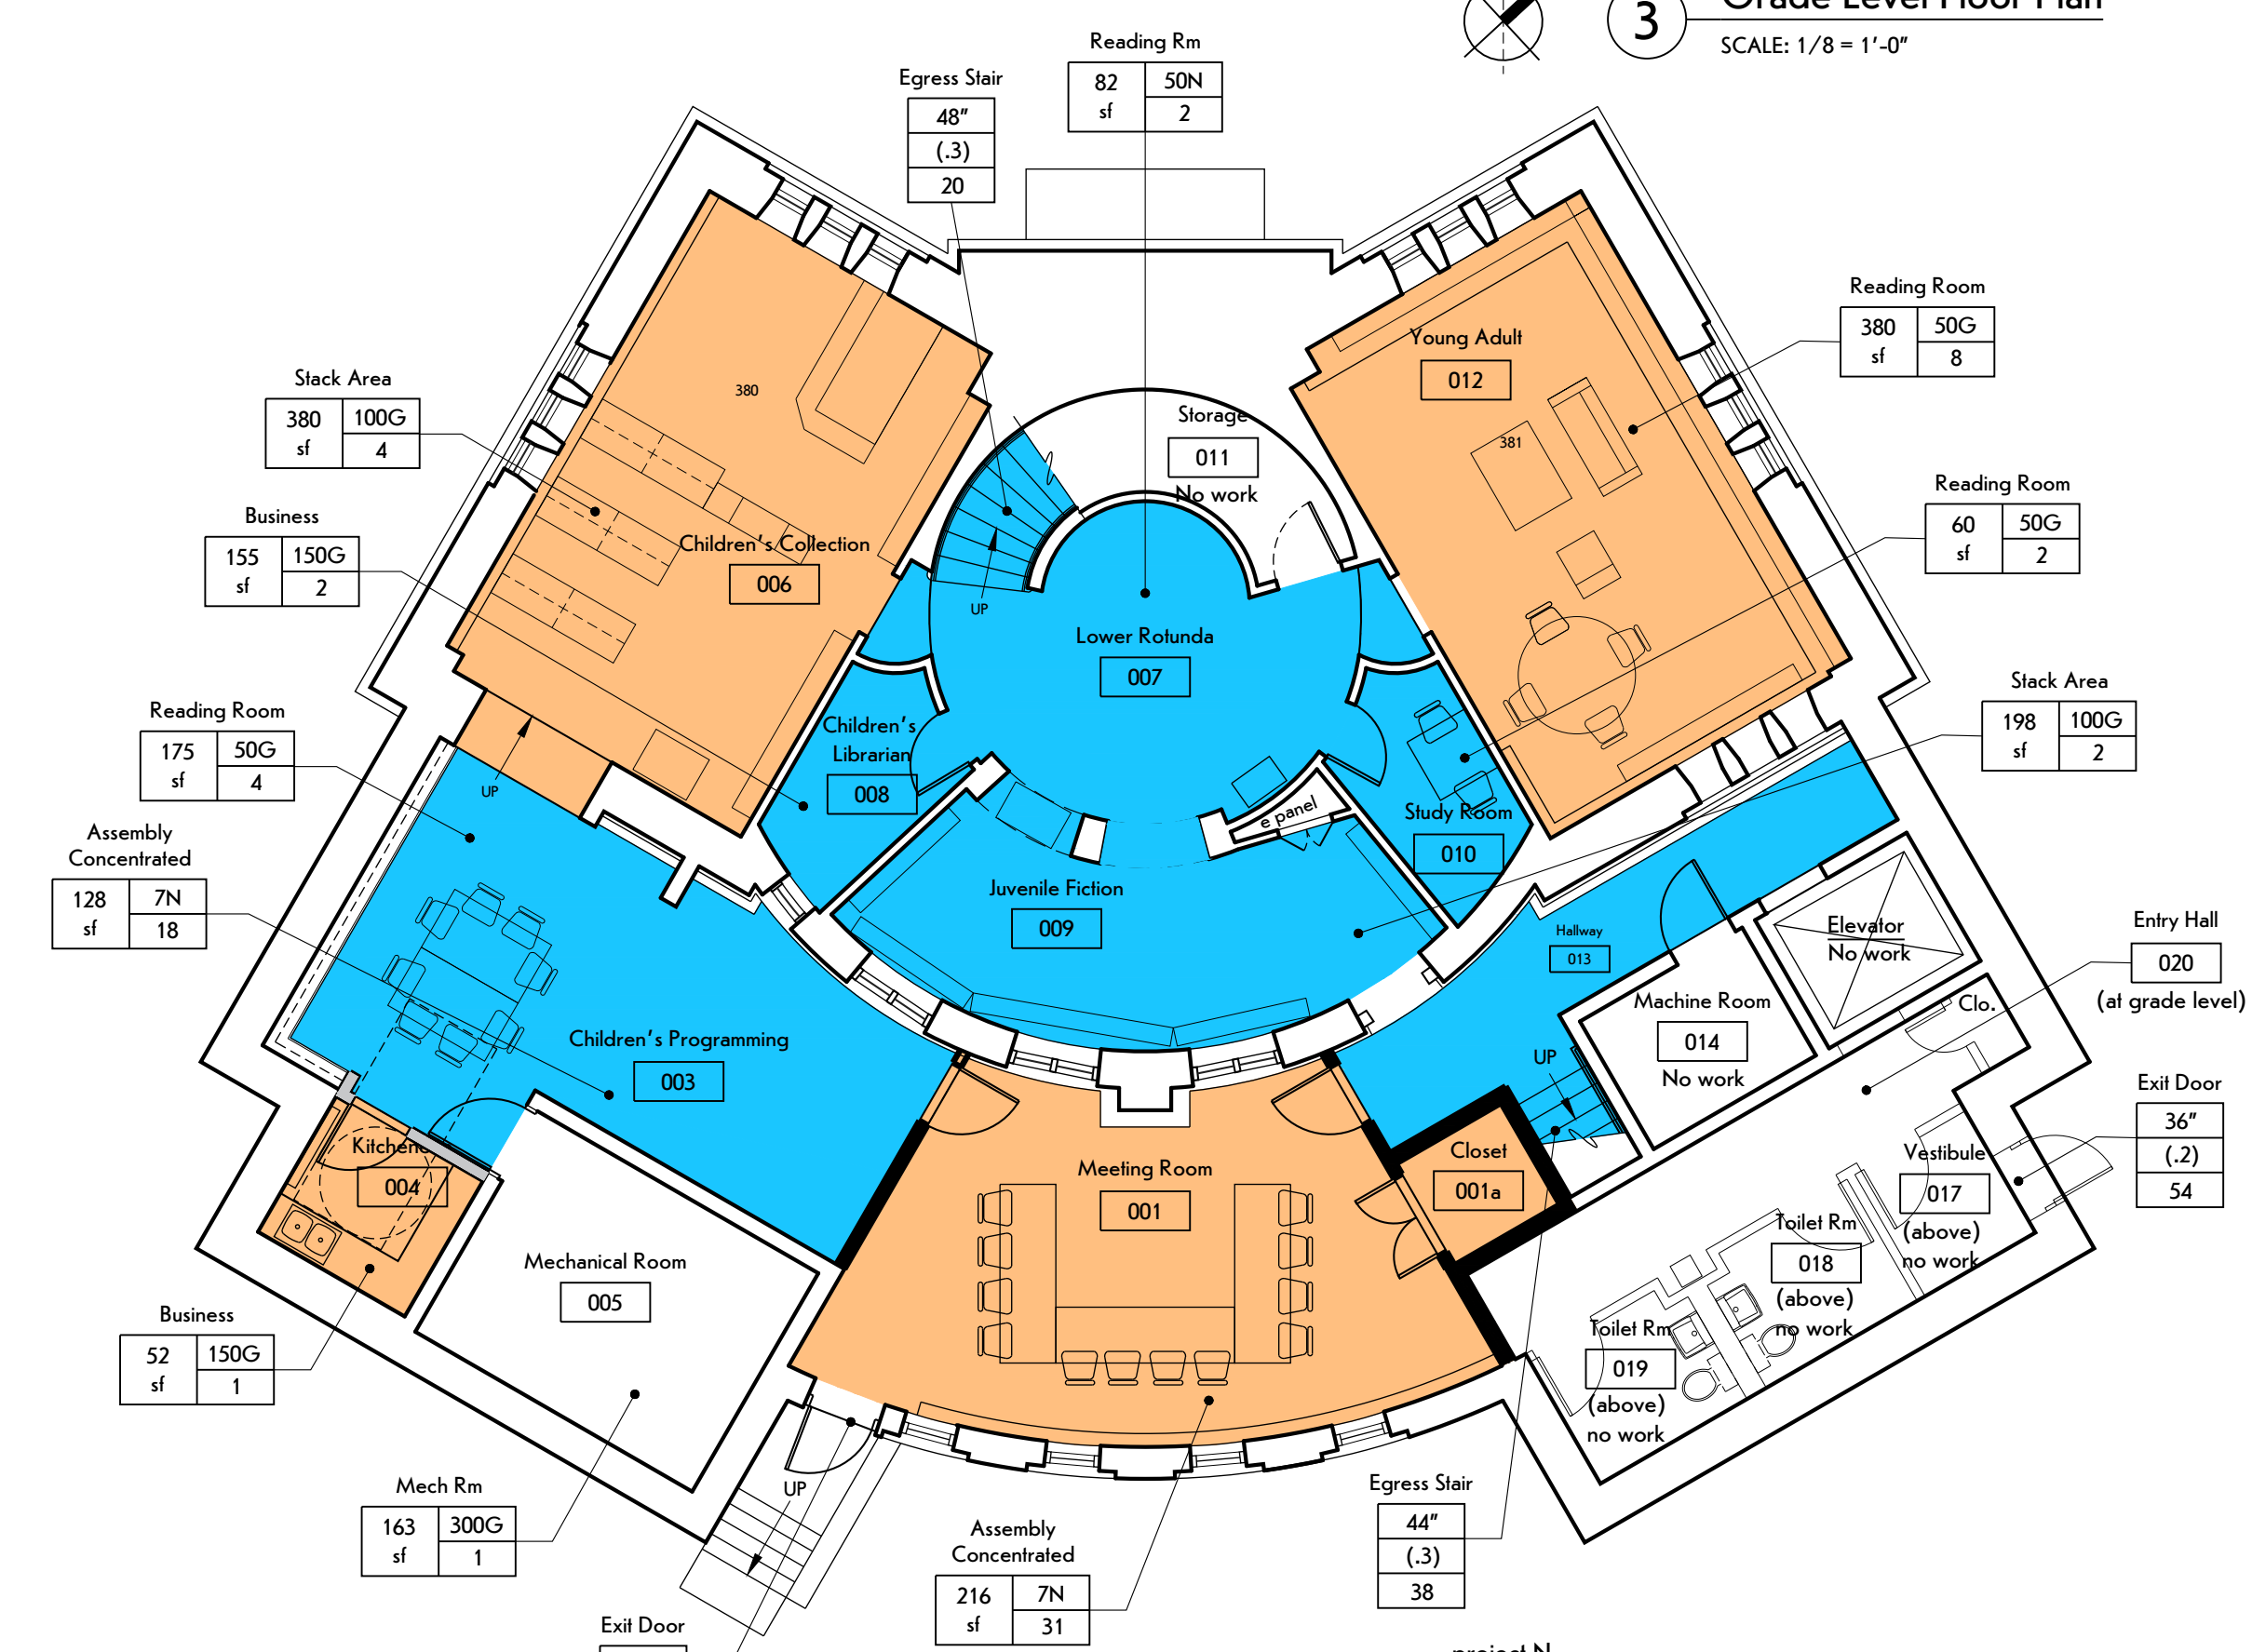

project N
1 Lower Level Floor Plan
 SCALE: 1/8" = 1'-0"

BUILDING INFORMATION

BUILDING DATA:

Building: Warsaw Public Library
 130 North Main Street
 Warsaw, NY 14569

Description: 1906, 1-story + lower level + mezzanine;
 Type II-B
 Ca. 1988-89 addition, 1-story + lower level;
 Type II-B construction

Proposed: Insertion of second story within the clerestory of the 1988-89 addition.

Exg Building Area: (net)

Lower Level -	2,684 sf
Intermediate Level* -	297 sf
First Floor -	2,254 sf
Mezzanine** -	480 sf
TOTAL	5,708 sf

Addition Area: (net)

Lower Level -	2,661 sf
Intermediate Level* -	297 sf
First Floor -	2,771 sf
Mezzanine** -	480 sf
TOTAL	6,209 sf

*Includes entry level, vestibule, hallway, toilet rooms, and closet.
 **Includes Mezzanine 200 and Storage 201

PROJECT DESCRIPTION:

Work Area Compliance Method Key:

Alteration - Level 1 (Blue)

Alteration - Level 2 (Orange)

Addition (Green)

Alteration - Level 2

Lower Level -	1,251 sf
First Floor -	634 sf
TOTAL (net)	1,885 sf

Addition

First Floor -	498 sf
TOTAL (net)	498 sf

Work Area:

TOTAL (net)	2,383 sf
--------------------	-----------------

(42% of Building Total)

PROJECT DESCRIPTION:

Work generally consists of the following:

Alteration - Level 1

- Lower Level
- Replacement of existing finishes and fixtures.

Main Level

- Replacement of existing finishes and fixtures.

Alteration - Level 2

- Lower Level
- Add partition walls to enclose space Meeting Room 001.
- Kitchenette 004; Reconfiguration of space.
- Children's Collection 006 & Young Adult 012.
- Removal and replacement of existing floor to level with adjacent spaces.

Main Level

- Enclose existing space to create Media Room 103 and Meeting Room 104.

Addition

- Main Level
- Insert second floor framing within the existing building envelope.

APPLICABLE CONSTRUCTION CODES:

2020 Existing Building Code of New York State
 2020 Building Code of New York State
 2020 Fire Protection Code of New York State
 2020 Electrical Code of New York State
 2020 Mechanical Code of New York State
 2020 Plumbing Code of New York State

2016 New York State Uniform Code Supplement Accessible and Usable Buildings and Facilities ICC A117.1-2009 Edition

New construction will comply with requirements of the current Codes listed.

Definition: "That portion or portions of a building consisting of all reconfigured spaces as indicated on the construction documents. Work area excludes other portions of the building where incidental work entailed by the intended work must be performed and portions of the building where work not initially intended by the owner is specifically required by this code."

CODE STUDY REVIEW

CODE PLAN LEGEND

Stair Capacity Symbol

Egress Stair	48"	Stair Clear Width
(.3)	Load Factor, NS	
160	Exit Capacity Occupants (calculated)	

Door Capacity Symbol

Exit Door	79"	Exit Clear Width
(.2)	Load Factor, NS	
395	Exit Capacity Occupants (calculated)	

CODE DATA SUMMARY:

Building was constructed and subsequent alterations made in compliance with codes in existence at that time.

Use Group: A - Assembly, Group A-3
 Exg 1906, building Type III-B
 Exg 1988-89 Addition Type II-B

Fire Safety: Fire Alarm System (per NFPA 72).
 Code Compliant Emergency and Exit Lighting.
 Carbon monoxide detection.
 Extension of Automatic Sprinkler System at the addition Work Area.

[B] Table 504.4 Allowable # of stories above grade plane:
 Exg building + Addition A-3 NS Type II-B Two (Proposed addition = infill of existing second story)

[B] Table 506.2 Allowable area factor in square feet:
 Exg building + Addition A-3 NS Type II-B 9,500sf

Occupant Load: (calculated)

Location	Occupants
Lower Level	75
First Floor	30
Mezzanine/Storage	2
TOTAL	107

[F] Section 903.2.1.3 Group A-3
 An automatic sprinkler system shall be provided throughout stories containing Group A-3 occupancies and throughout all stories from the Group A-3 occupancy to and including the levels of exit discharge serving that occupancy where one of the following conditions exists:

- The fire area exceeds 12,000 square feet (1115 m²).
- The fire area has an occupant load of 300 or more.
- The fire area is located on a floor other than a level of exit discharge serving such occupancies.

(The Addition and Main Level will be covered by the automatic sprinkler system)

[B] Table 1006.3.2 Egress Occ Load:

Occupant Load per story	Min req'd # of exits
1-500	2

[B] Table 1017.2 Exit Access Travel Distance:

Permitted:	A	NS	200'
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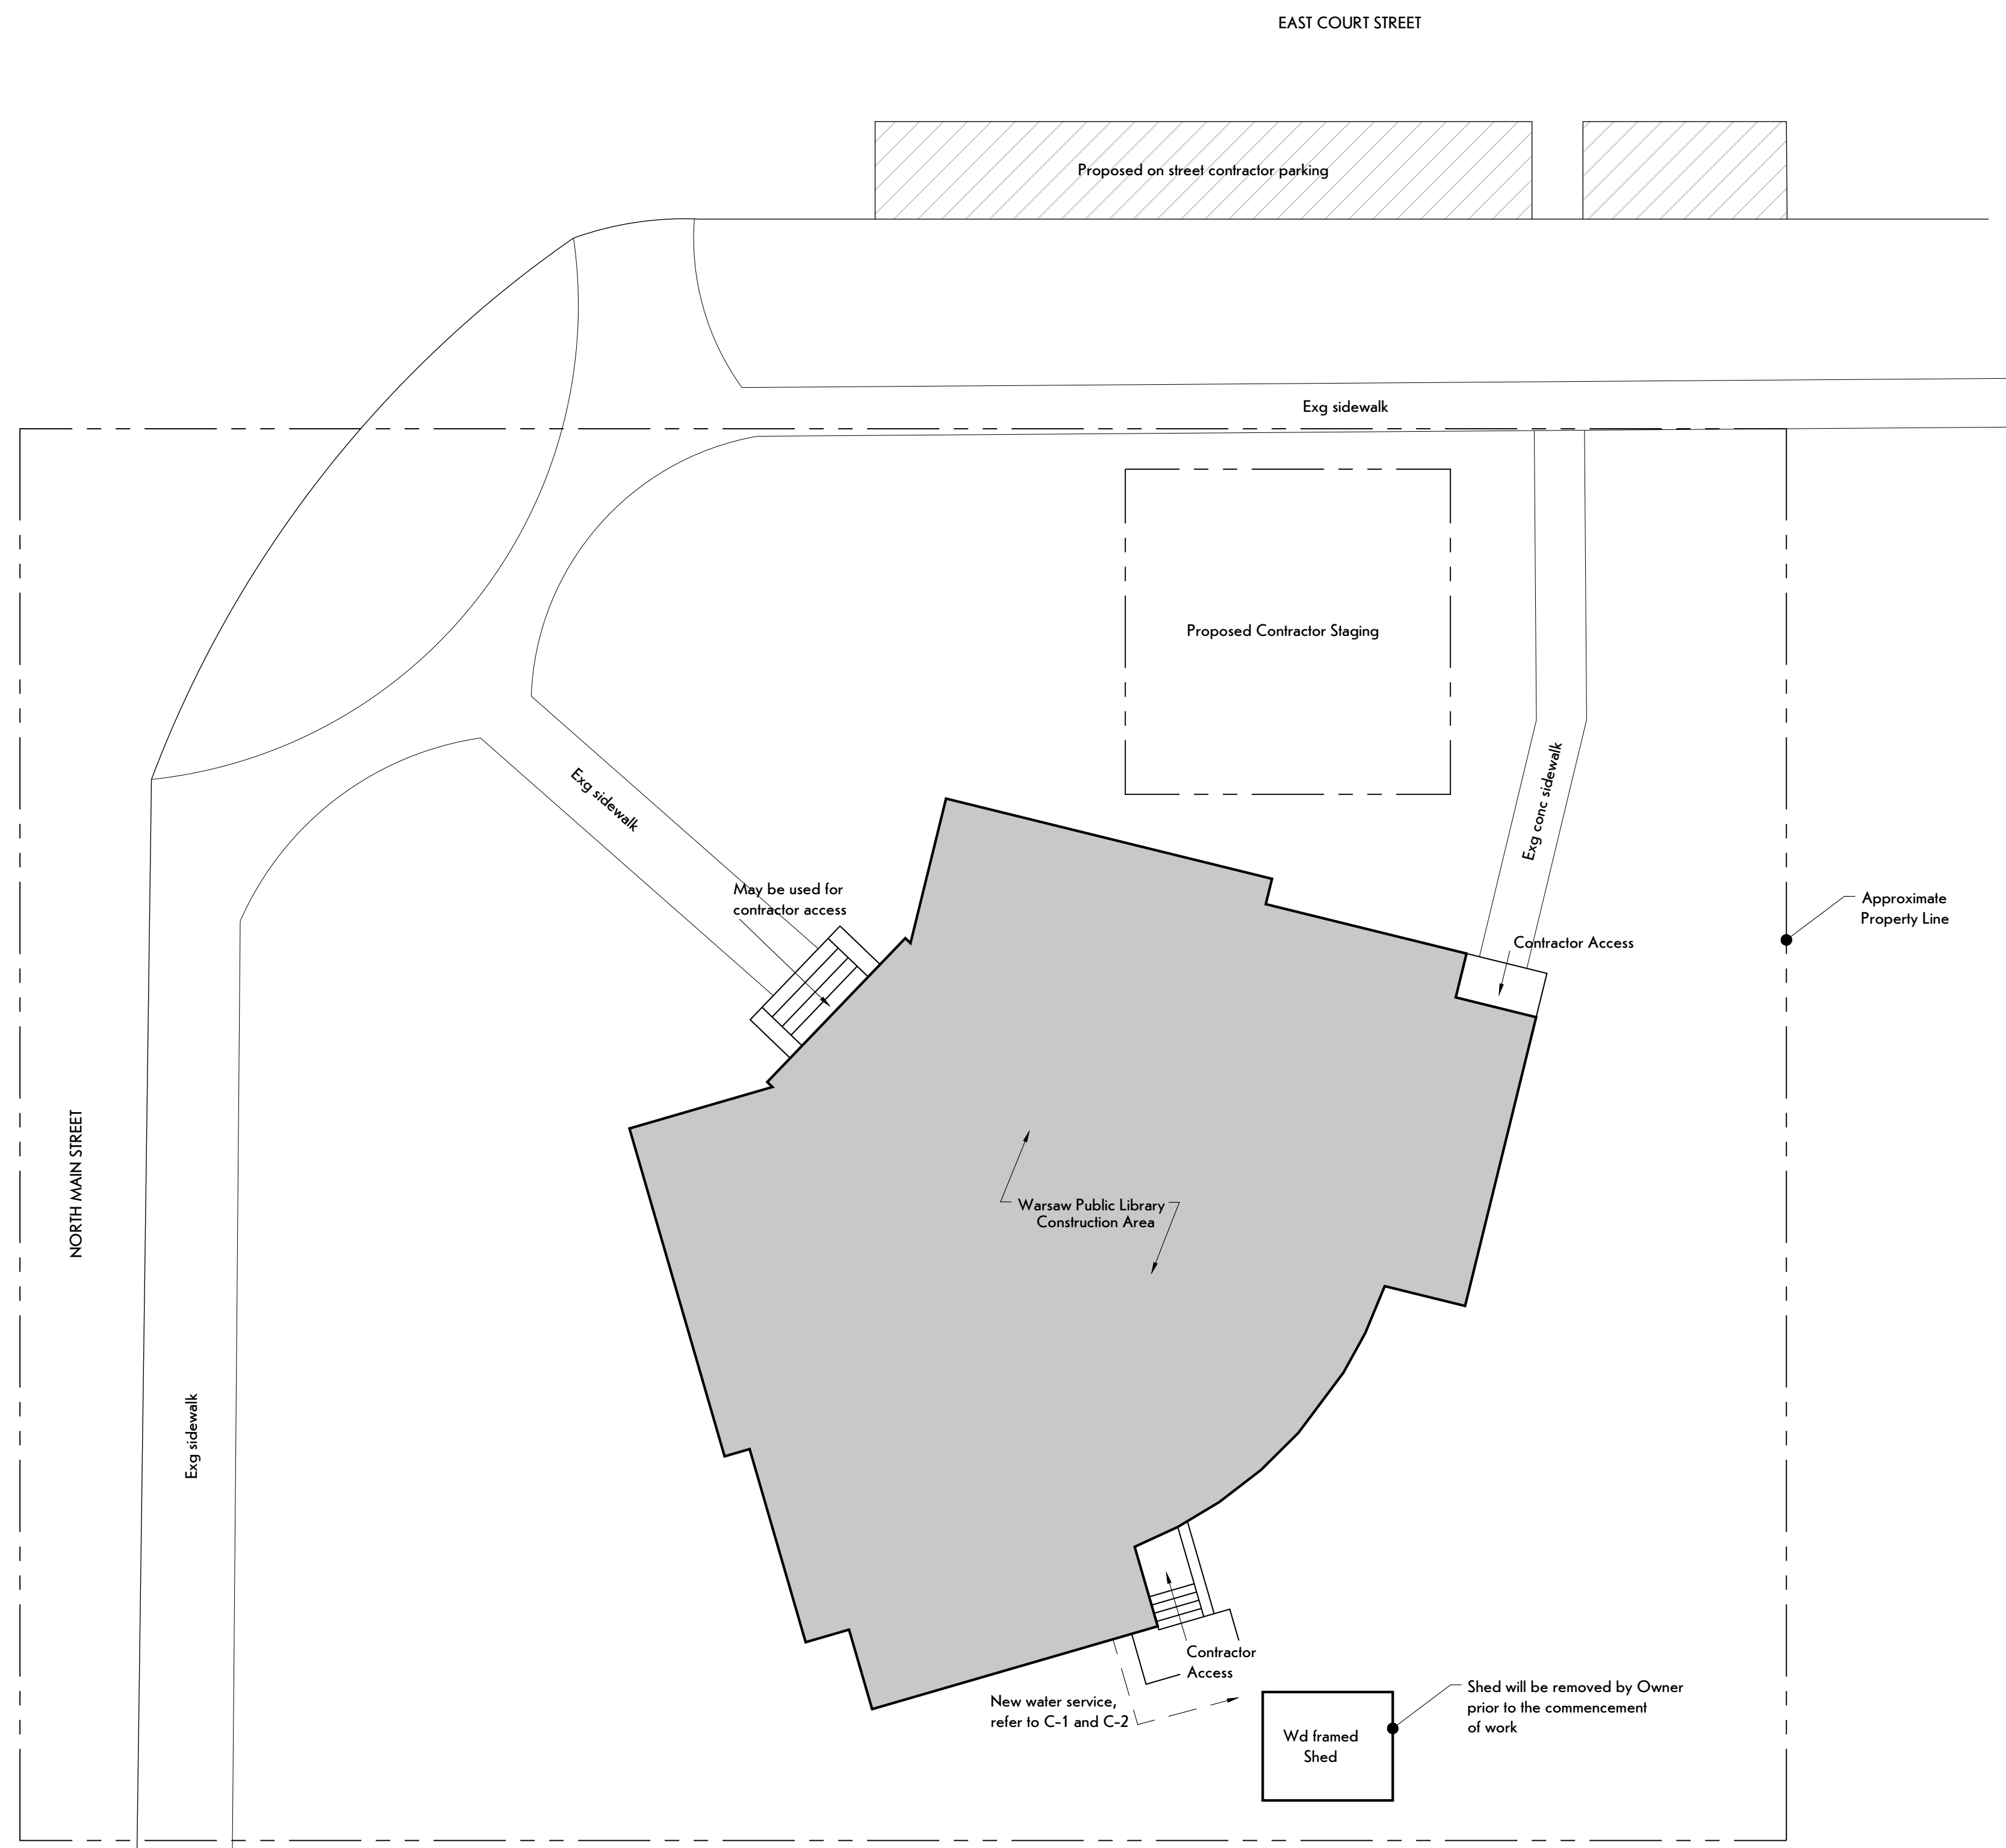
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ISSUE DATE: February 25, 2025

DRAWN BY: LMY

SHEET TITLE:
Code Study


SHEET NUMBER:
CS-10



General Site Plan Notes:

1. Refer to drawings C-1 and C-2 for detailed site and water service information.
2. Protect persons, motor vehicles, surrounding surfaces of building, building site, plants, and surrounding buildings from harm resulting from alteration work.
3. Location of staging, storage, unloading, and contractor parking areas shall be reviewed, coordinated, and approved by Owner prior to commencement of work.
4. Protect site improvements from damage. Restore damaged work to condition existing before start of site clearing. Protect trees and shrubs from damage and maintain vegetation.
5. Restore site to existing conditions at completion of project. Restore damaged improvements, if necessary, as acceptable to Owner.
6. Determine location of existing utility services trenching. Comply with local utility service requirements. Contractor is responsible for verifying location of utilities at job site. Maintain existing utilities in service and protect them against damage during selective demolition operations.

1 Site Plan
SCALE: 3/32" = 1'-0"

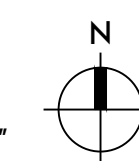

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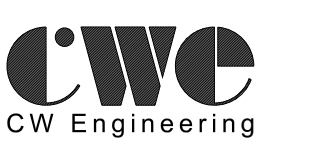
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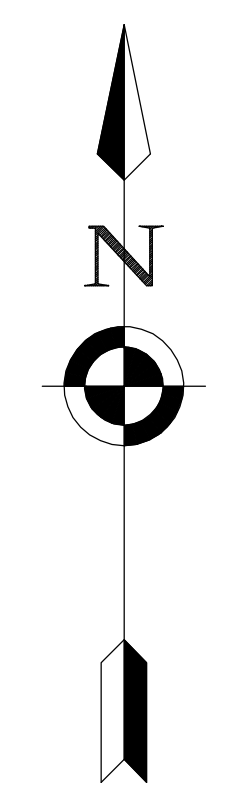
DRAWN BY: LMY

SHEET TITLE:

Site & Staging Plan

SHEET NUMBER:



A-01



EAST COURT STREET

LEGEND OF LINETYPES SHOWN

- EXISTING PROPERTY LINE
- EXISTING EASEMENT LINE
- OE OVERHEAD ELECTRIC
- UE UNDERGROUND ELECTRIC
- G GAS MAIN/SERVICE
- S SANITARY SEWER MAIN OR LATERAL
- ST STORM SEWER
- W WATERMAIN/WATER SERVICE
- EXISTING FENCE LINE
- HYDRANT
- TREE
- UTILITY POLE

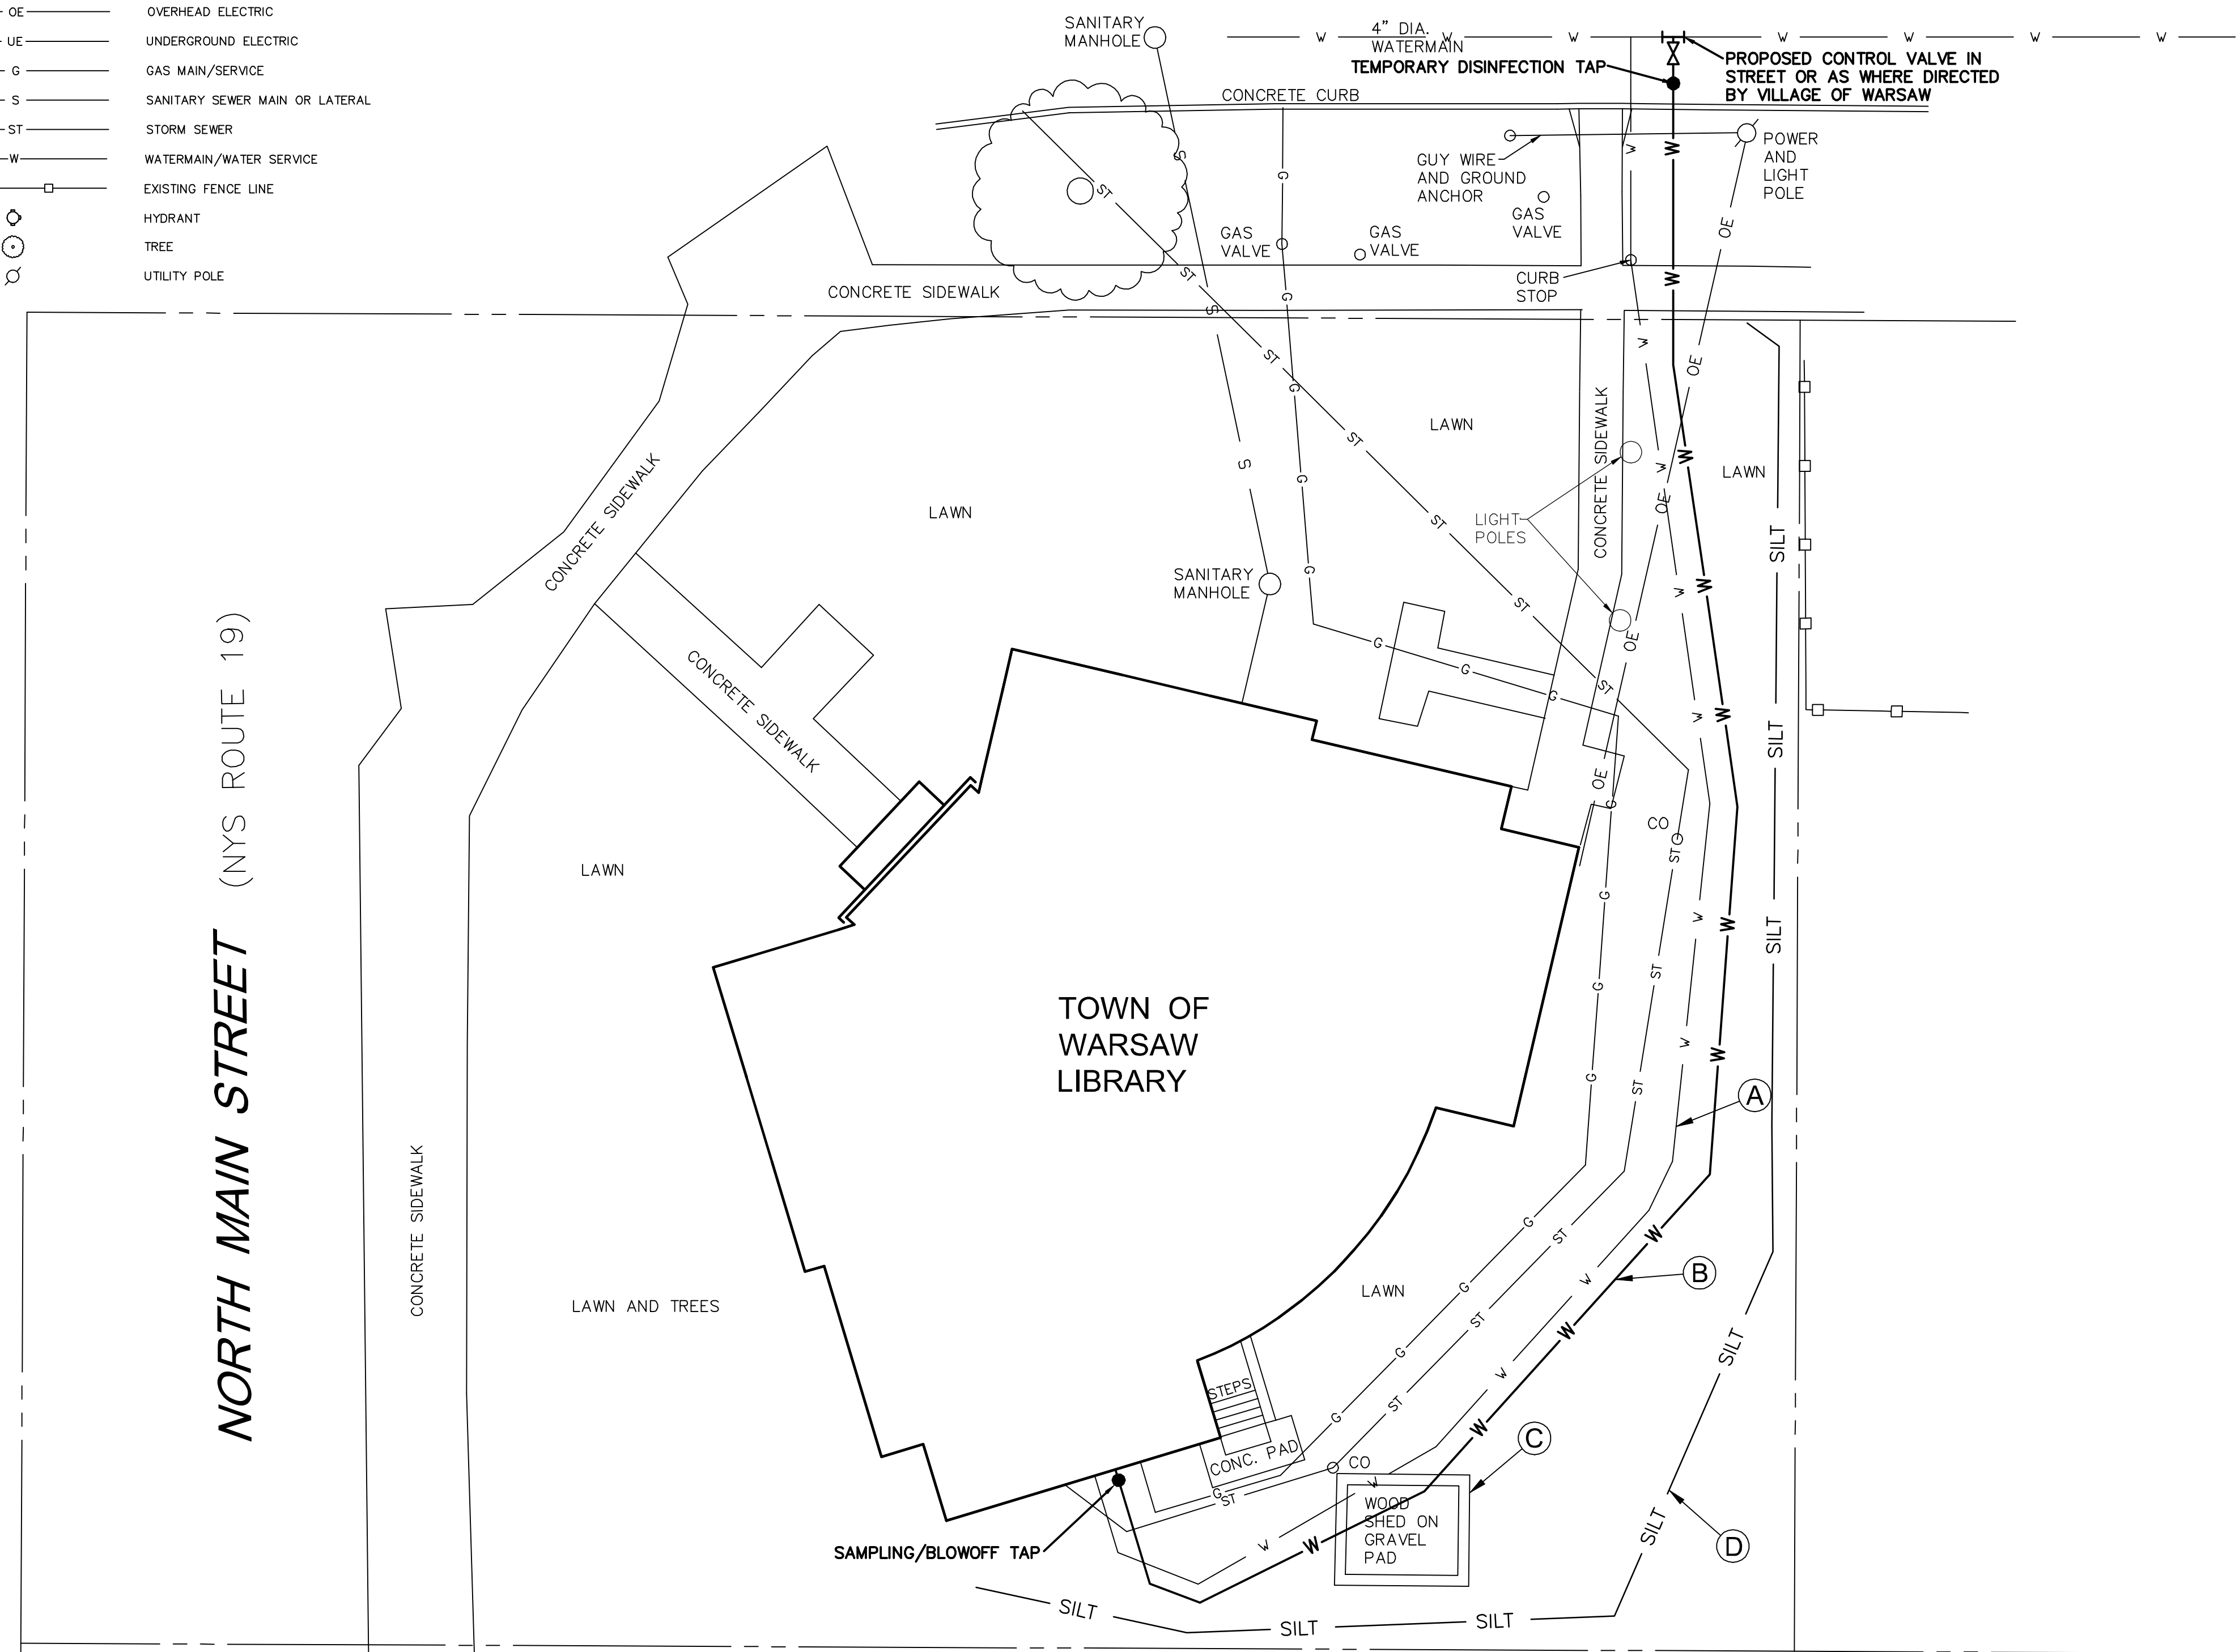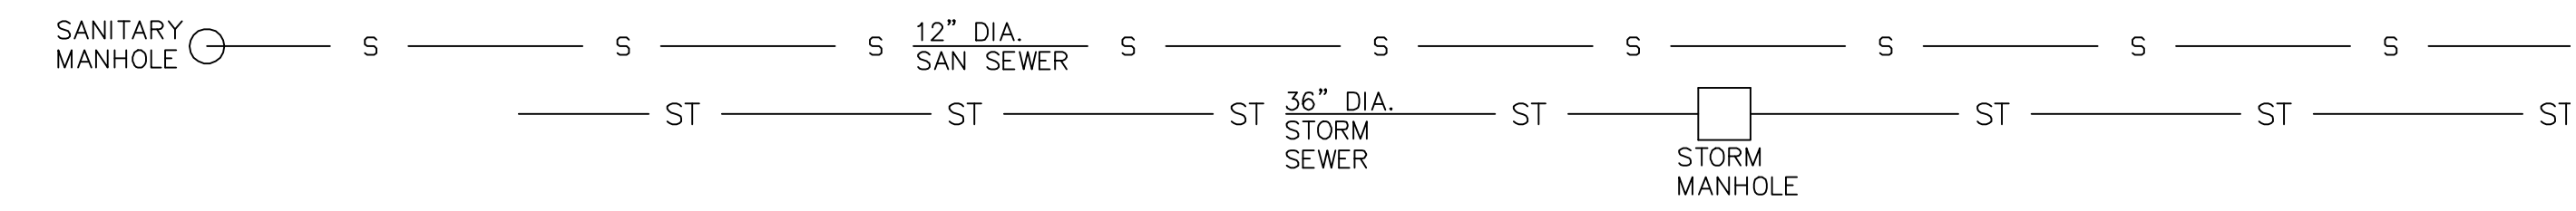

SITE DATA/ GENERAL NOTES

1. PROPERTY LINES SHOWN ARE TAKEN FROM SEAR-BROWN DRAWING PREPARED FOR THE 1988 LIBRARY ADDITION AND DO NOT SHOW ROW TAKINGS FROM NYS DOT FOR MAIN STREET.
2. ALL DISTANCES AND ELEVATIONS ARE MEASURED IN DECIMAL FEET.
3. ORIENTATION OF DRAWING IS STATE PLAN CENTRAL 1983 WITH MAP BEARINGS SHOWN.
4. UTILITIES ARE SHOWN BASED ON SURFACE FEATURES FIELD SURVEYED IN ADDITION TO RECORD INFORMATION OBTAINED FROM THE REFERENCED SEAR BROWN DRAWING AND WATER SYSTEM RECORD INFORMATION PROVIDED BY THE WATER SUPPLIER.


LEGEND OF EXISTING FEATURES AND PROPOSED WORK ITEMS

- (A) EXISTING 2" WATER SERVICE TO BUILDING. NOTE THAT EXACT ROUTE OF THE EXISTING 2" SERVICE FROM THE CURB STOP IS ESTIMATED FROM RECORD DRAWINGS AND SURFACE OBSERVATIONS. CONTRACTOR TO VERIFY EXACT UTILITY LOCATIONS IN FIELD (WIF) AS REQUIRED. NOTE THAT THIS EXISTING WATER SERVICE IS TO BE ABANDONED UPON ACTIVATION OF THE PROPOSED 4" SERVICE AFTER SUCCESSFUL COMPLETION OF PRESSURE TESTING AND DISINFECTION. THIS WORK IS TO BE PERFORMED BY THE CONTRACTOR PER THE VILLAGE OF WARSAW'S WATER SPECIFICATIONS.
- (B) PROPOSED 180 (±) LF OF 4" DIA. DIP WATER SERVICE TO BUILDING FROM 4X4 TEE CONNECTION AT MAIN. THE CONTRACTOR SHALL RESTORE THE EXCAVATION AREA, ROAD BASE, ROAD TOP, CONCRETE CURB, SIDEWALK AND TREELAWN AREA ALL PER VILLAGE OF WARSAW'S SPECIFICATIONS.
- THE CONTRACTOR IS TO COORDINATE ALL THIS WORK INCLUDING THE TEMPORARY SHUTDOWN OF THE 4" WATERMAIN WITH THE VILLAGE OF WARSAW'S WATER DEPARTMENT.
- (C) EXISTING SHED, GRAVEL, AND SURPLUS SOIL FROM TRENCHING OF WATER SERVICE SHALL BE REMOVED AND TRANSPORTED BY THE CONTRACTOR TO A SITE LICENSED TO ACCEPT SUCH WASTES.
- (D) TEMPORARY SILT FENCE BARRIER, TOPSOIL AND SEED DISTURBED LAWN AREAS AFTER ACHIEVING FINAL GRADES.

NORTH MAIN STREET (NYS ROUTE 19)

TOWN OF WARSAW LIBRARY

EXISTING BRICK BUILDING EXTENDS ENTIRE LENGTH OF PROPERTY LINE AND IS APPROXIMATELY 1 FOOT SOUTH OF PROPERTY LINE.

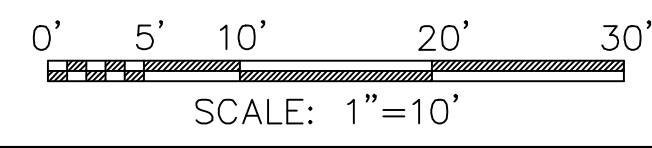

REVISIONS		
DATE	BY	DESCRIPTION
3/12/25	SH	VILLAGE WATER DEPT INPUT

SITE PLAN FOR WATER SERVICE REPLACEMENT

TOWN OF WARSAW LIBRARY - 130 NORTH MAIN STREET
 VILLAGE OF WARSAW, WYOMING COUNTY, NEW YORK STATE

PROFESSIONAL ENGINEERING GROUP

7171 VICTOR - PITTSFORD ROAD
 VICTOR, NEW YORK 14564
 TEL: (585) 924-1860 EMAIL: PROENGINEER1@PRODIGY.NET

CLIENTS:
 BERO ARCHITECTS
 32 WINTHROP STREET
 ROCHESTER, NY 14607

TAX ACCOUNT NO. 85.8-1-20



DATE: MARCH 2025 ENGINEER: S.A.H. DRAWN BY: S.A.H. SCALE: 1" = 10' SHEET NO.: C-1 DRAWING NO.: 250.308SP1

GENERAL & UTILITY NOTES

- SAFE AND CONTINUOUS TRAFFIC AND INGRESS AND EGRESS FOR ADJACENT OWNER DRIVEWAYS, SERVICE AND PUBLIC ROADS SHALL BE MAINTAINED THROUGH THE PERIOD OF CONSTRUCTION.
- ALL CONSTRUCTION RELATED TO THIS PROJECT SHALL BE IN CONFORMANCE WITH ALL APPLICABLE LOCAL, STATE, AND FEDERAL REQUIREMENTS.
- THE CONTRACTOR SHALL OBTAIN ALL APPROPRIATE PERMITS BEFORE BEGINNING ANY CONSTRUCTION.
- THE CONTRACTOR IS REQUIRED TO NOTIFY CENTRAL STAKEOUT, TELEPHONE NO. 1-800-962-7962 (811) FOR FIELD STAKEOUT OF UNDERGROUND UTILITIES BEFORE COMMENCING CONSTRUCTION.
- THE PROPOSED WATER APPURTENANCES SHALL CONFORM TO THE LOCAL WATER AUTHORITY STANDARDS.
- ALL WATER AND WASTEWATER APPURTENANCES SHALL CONFORM TO NEW YORK STATE HEALTH DEPARTMENT STANDARDS.
- THE CONTRACTOR SHALL PROVIDE FOR EROSION CONTROL BARRIERS DURING CONSTRUCTION AND FOR THE REMOVAL OF THE SAME AFTER GRADING AND SEEDING HAS BEEN ESTABLISHED.
- THE CONTRACTOR SHALL BE REQUIRED TO CLEAN MUD AND DEBRIS FROM PUBLIC ROADS SERVICING THE CONSTRUCTION SITE DURING AND AFTER THE COMPLETION OF THE PROJECT.
- THE CONTRACTOR SHALL NOTIFY AGENCIES PRIOR TO ANY EXCAVATING AND REQUEST SUCH UTILITY TO STAKE OUT WATER, GAS, ELECTRIC, AND/OR BURIED TELEPHONE LINES OR CABLES.
- THE CONTRACTOR SHALL USE DUE CAUTION IN PROTECTING PROPERTY MARKERS AND ALL ELEVATION SURVEY STAKES.
- THE ACCURACY OF EXISTING UTILITIES ARE NOT GUARANTEED. EXISTING UTILITIES SHOWN ON THE PLANS ARE A RESULT OF THE BEST INFORMATION THAT COULD BE OBTAINED FROM FIELD SURVEYS AND RECORD MAPS AND ARE FOR GENERAL INFORMATION ONLY. IT SHALL BE THE CONTRACTOR'S RESPONSIBILITY TO DETERMINE THE LOCATION OF ALL PERTINENT UTILITIES BY FIELD INVESTIGATION. THE CONTRACTOR SHALL ALSO TAKE THE NECESSARY MEASURES TO PRESERVE AND PROTECT EXISTING UTILITIES.
- ALL ELECTRICAL WORK SHALL BE PERFORMED IN CONFORMANCE WITH ALL NEC AND UL ELECTRICAL CODES.
- MINIMUM SEPARATION BETWEEN WATERMAIN AND SEWER MAINS TO BE 18" VERTICALLY MEASURED FROM THE OUTSIDE OF THE PIPES AT THE POINT OF CROSSING. MINIMUM HORIZONTAL SEPARATION BETWEEN WATERMANS AND SEWER MAINS TO BE 10' (FEET) MEASURED FROM THE OUTSIDE OF THE PIPES. IF A CROSSING SHOULD OCCUR ONE FULL LENGTH OF THE SEWER SHALL BE CENTERED UNDER OR OVER THE WATERMAIN SO THAT BOTH THE JOINTS WILL BE AS FAR FROM THE SEWER AS POSSIBLE. WHERE A WATERMAIN CROSSES UNDER A SEWER ADEQUATE STRUCTURAL SUPPORT (COMPACTED SELECT FILL) SHALL BE PROVIDED FOR THE SEWER TO PREVENT SETTLING.
- ALL WATERMANS AND SERVICES SHALL HAVE A MINIMUM OF 5' (FEET) OF COVER FROM THE TOP OF THE MAIN TO THE FINISHED GRADE. THE CONTRACTOR SHALL CHECK ALL CUT STAKES BEFORE TRENCHING TO INSURE THAT ALL INSTALLED WATERMANS WILL HAVE THE REQUIRED COVER.
- THE CONTRACTOR SHALL COMPLY WITH THE NEW YORK STATE INDUSTRIAL CODE, RULE 23, SUBPART 23-4, "EXCAVATION OPERATIONS" AND ALL APPLICABLE O.S.H.A. REQUIREMENTS SO AS TO PROVIDE SAFE EXCAVATION PROCEDURES.
- IT IS THE CONTRACTOR'S RESPONSIBILITY TO TEMPORARILY SUPPORT AND MAINTAIN OTHER UTILITIES AS REQUIRED.
- ALL TRAFFIC MAINTENANCE INCLUDING SIGNS, BARRICADES, LIGHTS AND OTHER TRAFFIC CONTROL DEVICES SHALL BE IN CONFORMANCE WITH THE REQUIREMENTS OF THE NEW YORK STATE MANUAL OF UNIFORM TRAFFIC CONTROL DEVICES.
- PROPOSED SLOPES SHALL NOT EXCEED 1 ON 3 EXCEPT WHERE NOTED.
- THE CONTRACTOR SHALL READ AND BECOME COMPLETELY FAMILIAR WITH THE APPROVED DESIGN PLANS. SHOULD THE CONTRACTOR HAVE ANY QUESTIONS CONCERNING THE PROJECT DESIGN, CONTACT THE DESIGN ENGINEER PRIOR TO COMMENCING CONSTRUCTION.


PERMANENT SEEDING

- REPLACE TOPSOIL TO A MINIMUM DEPTH OF 6 INCHES.
- SEED 20 POUNDS OF PERENNIAL RYEGRASS PER ACRE AND 80 POUNDS PER ACRE OF KENTUCKY BLUEGRASS OR EQUIVALENT.
- FERTILIZE WITH 600 POUNDS PER ACRE OF 10-10-10. LIME TO ACHIEVE A PH OF 6.0. IF HYDROSEEDER IS NOT USED, SEED AND FERTILIZER SHOULD BE LIGHTLY RAKED INTO SOIL.
- MULCH WITH CLEAN (WEED FREE) STRAW.

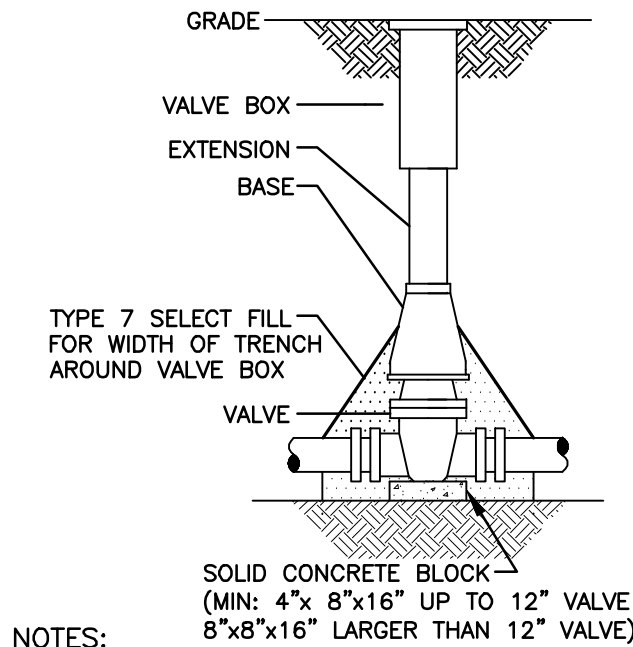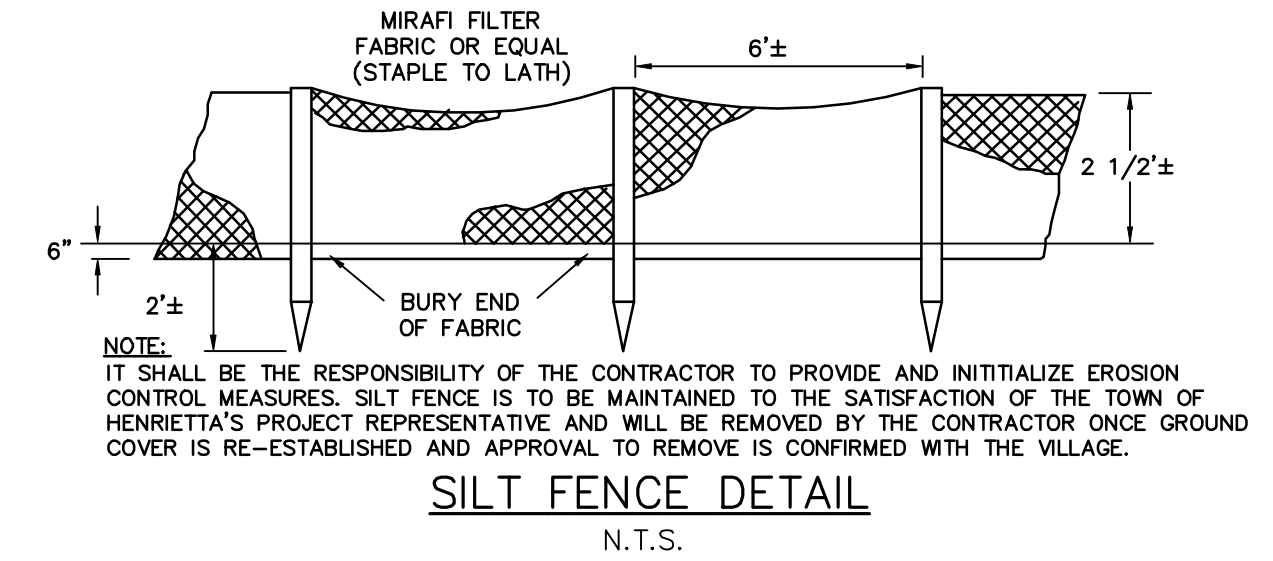

- NOTES:
- VALVE BOX SHALL BE CENTERED ON VALVE AND SET ON COMPACTED BACKFILL.
 - VALVE SHALL NOT SUPPORT VALVE BOX.
 - ALL VALVES SHALL BE OPEN LEFT

VALVE
NOT TO SCALE

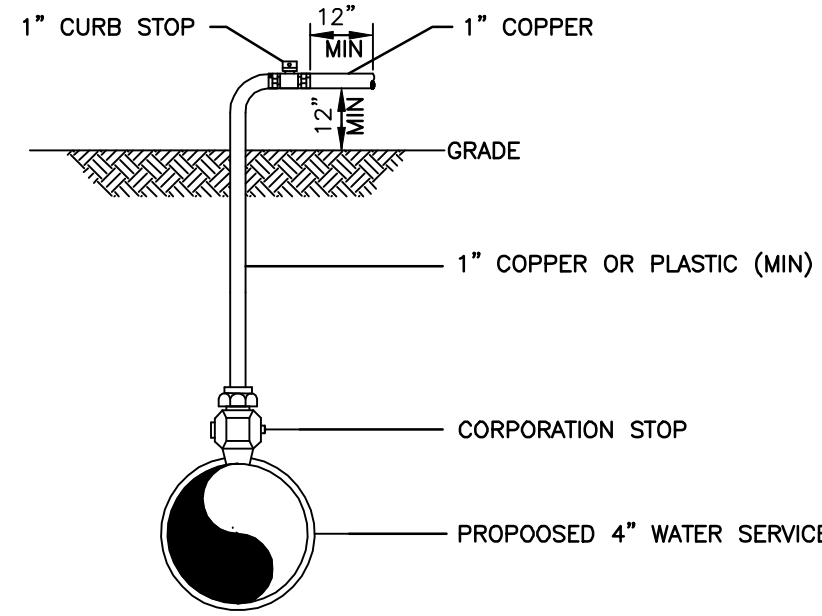

NOTE: IN THE PRESENCE OF A WATER AUTHORITY REPRESENTATIVE REMOVE ALL CORPORATIONS ASSOCIATED WITH TEMPORARY DISINFECTION/SAMPLE TAPS AND REPLACE WITH THREADED BRASS PLUGS.

DISINFECTION/BLOW-OFF/SAMPLING TAP (TEMPORARY)
NOT TO SCALE

WATER SERVICE LINE NOTES

- WATER SERVICE LINES SHALL BE CONSTRUCTED IN ACCORDANCE WITH THE REGULATIONS AND SPECIFICATIONS OF THE LOCAL WATER AUTHORITY.
- WATER SERVICE LINES SHALL HAVE A MINIMUM OF FIVE FEET OF COVER FROM FINISHED GRADE IN LAWN AREAS AND SIX FEET OF COVER FROM FINISHED GRADE IN PAVED AREAS.
- WATER SERVICE LINES SHALL BE SEPARATED AT LEAST TEN FEET, MEASURED FROM THE OUTSIDE OF THE PIPES, FROM SEWER MAINS OR SEPTIC SYSTEMS.
- WATER SERVICE LINES SHALL BE IDENTIFIED AS:


DESCRIPTION	SIZE	MATERIAL (A)	TYPE (B)
MUNICIPAL PORTION=FROM THE WATERMAIN TO AND INCLUDING THE CONTROL VALVE ON THE ROW/PROPERTY/EASEMENT LINE	4" DIA.	D.I.P.	DS
PRIVATE PORTION = FROM THE CONTROL VALVE TO THE METER	4" DIA.	D.I.P.	DS

- (A) ACCEPTABLE MATERIAL FOR PRIVATE PORTION IS CLASS 52 CEMENT MORTAR LINED DUCTILE IRON PIPE.
(B) SERVICE TYPES INCLUDE: DOMESTIC=DS, FIRE =FS, OR COMBINED=CMB


- THE MUNICIPAL PORTION OF THE WATER SERVICE SHALL BE INSTALLED PRIOR TO THE PRIVATE PORTION OF THE SERVICE LINE.
- WATER SERVICE LINES SIZED 4" OR LARGER SHALL BE:

PRESSURE TESTED IN ACCORDANCE WITH THE LATEST SPECIFICATIONS OF THE LOCAL WATER AUTHORITY. THE LOCAL WATER AUTHORITY MUST WITNESS THIS TEST.

DISINFECTED BY USING THE CONTINUOUS FEED METHOD ACCORDING TO THE LATEST AWWA STANDARD SPECIFICATIONS. AFTER FLUSHING AND DISINFECTING THE SERVICE LINE, WATER SAMPLES SHALL BE COLLECTED IN ACCORDANCE WITH THE LOCAL HEALTH DEPARTMENT'S REQUIREMENTS. APPROVAL AND NOTIFICATION BY THE HEALTH DEPARTMENT MUST BE RECEIVED BEFORE THE WATER SERVICE CAN BE ACTIVATED BY THE LOCAL WATER AUTHORITY.

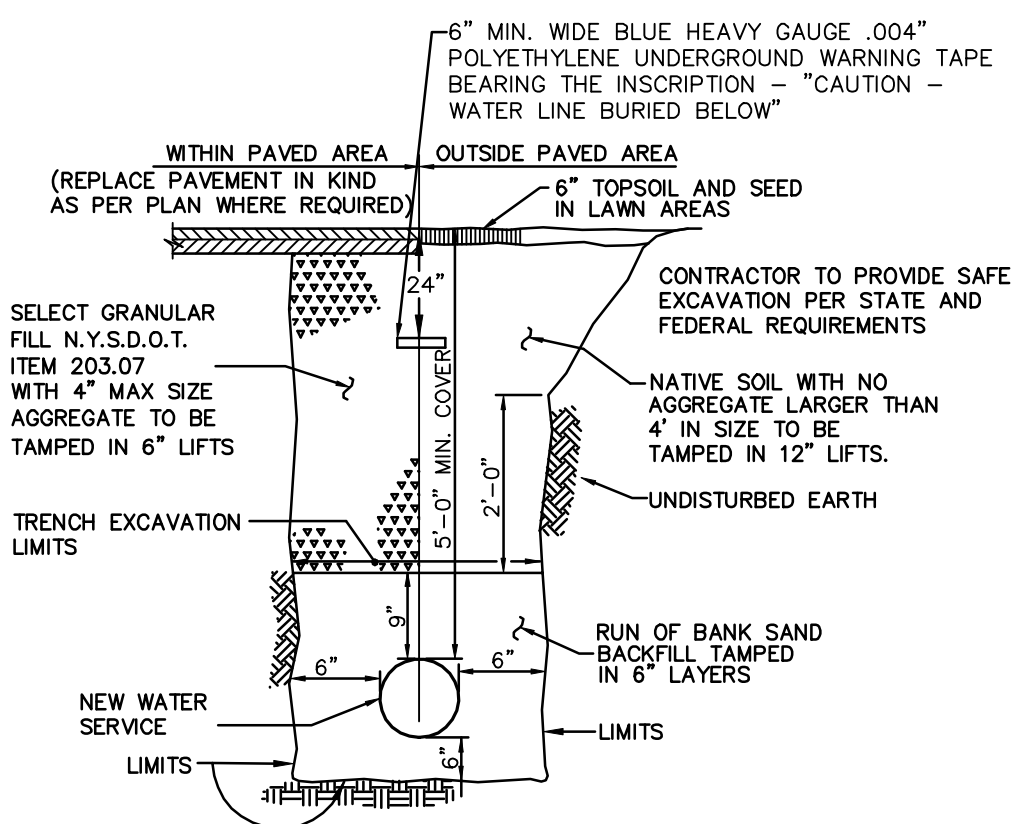

TYPICAL WATER SERVICE TRENCH DETAIL
N.T.S.

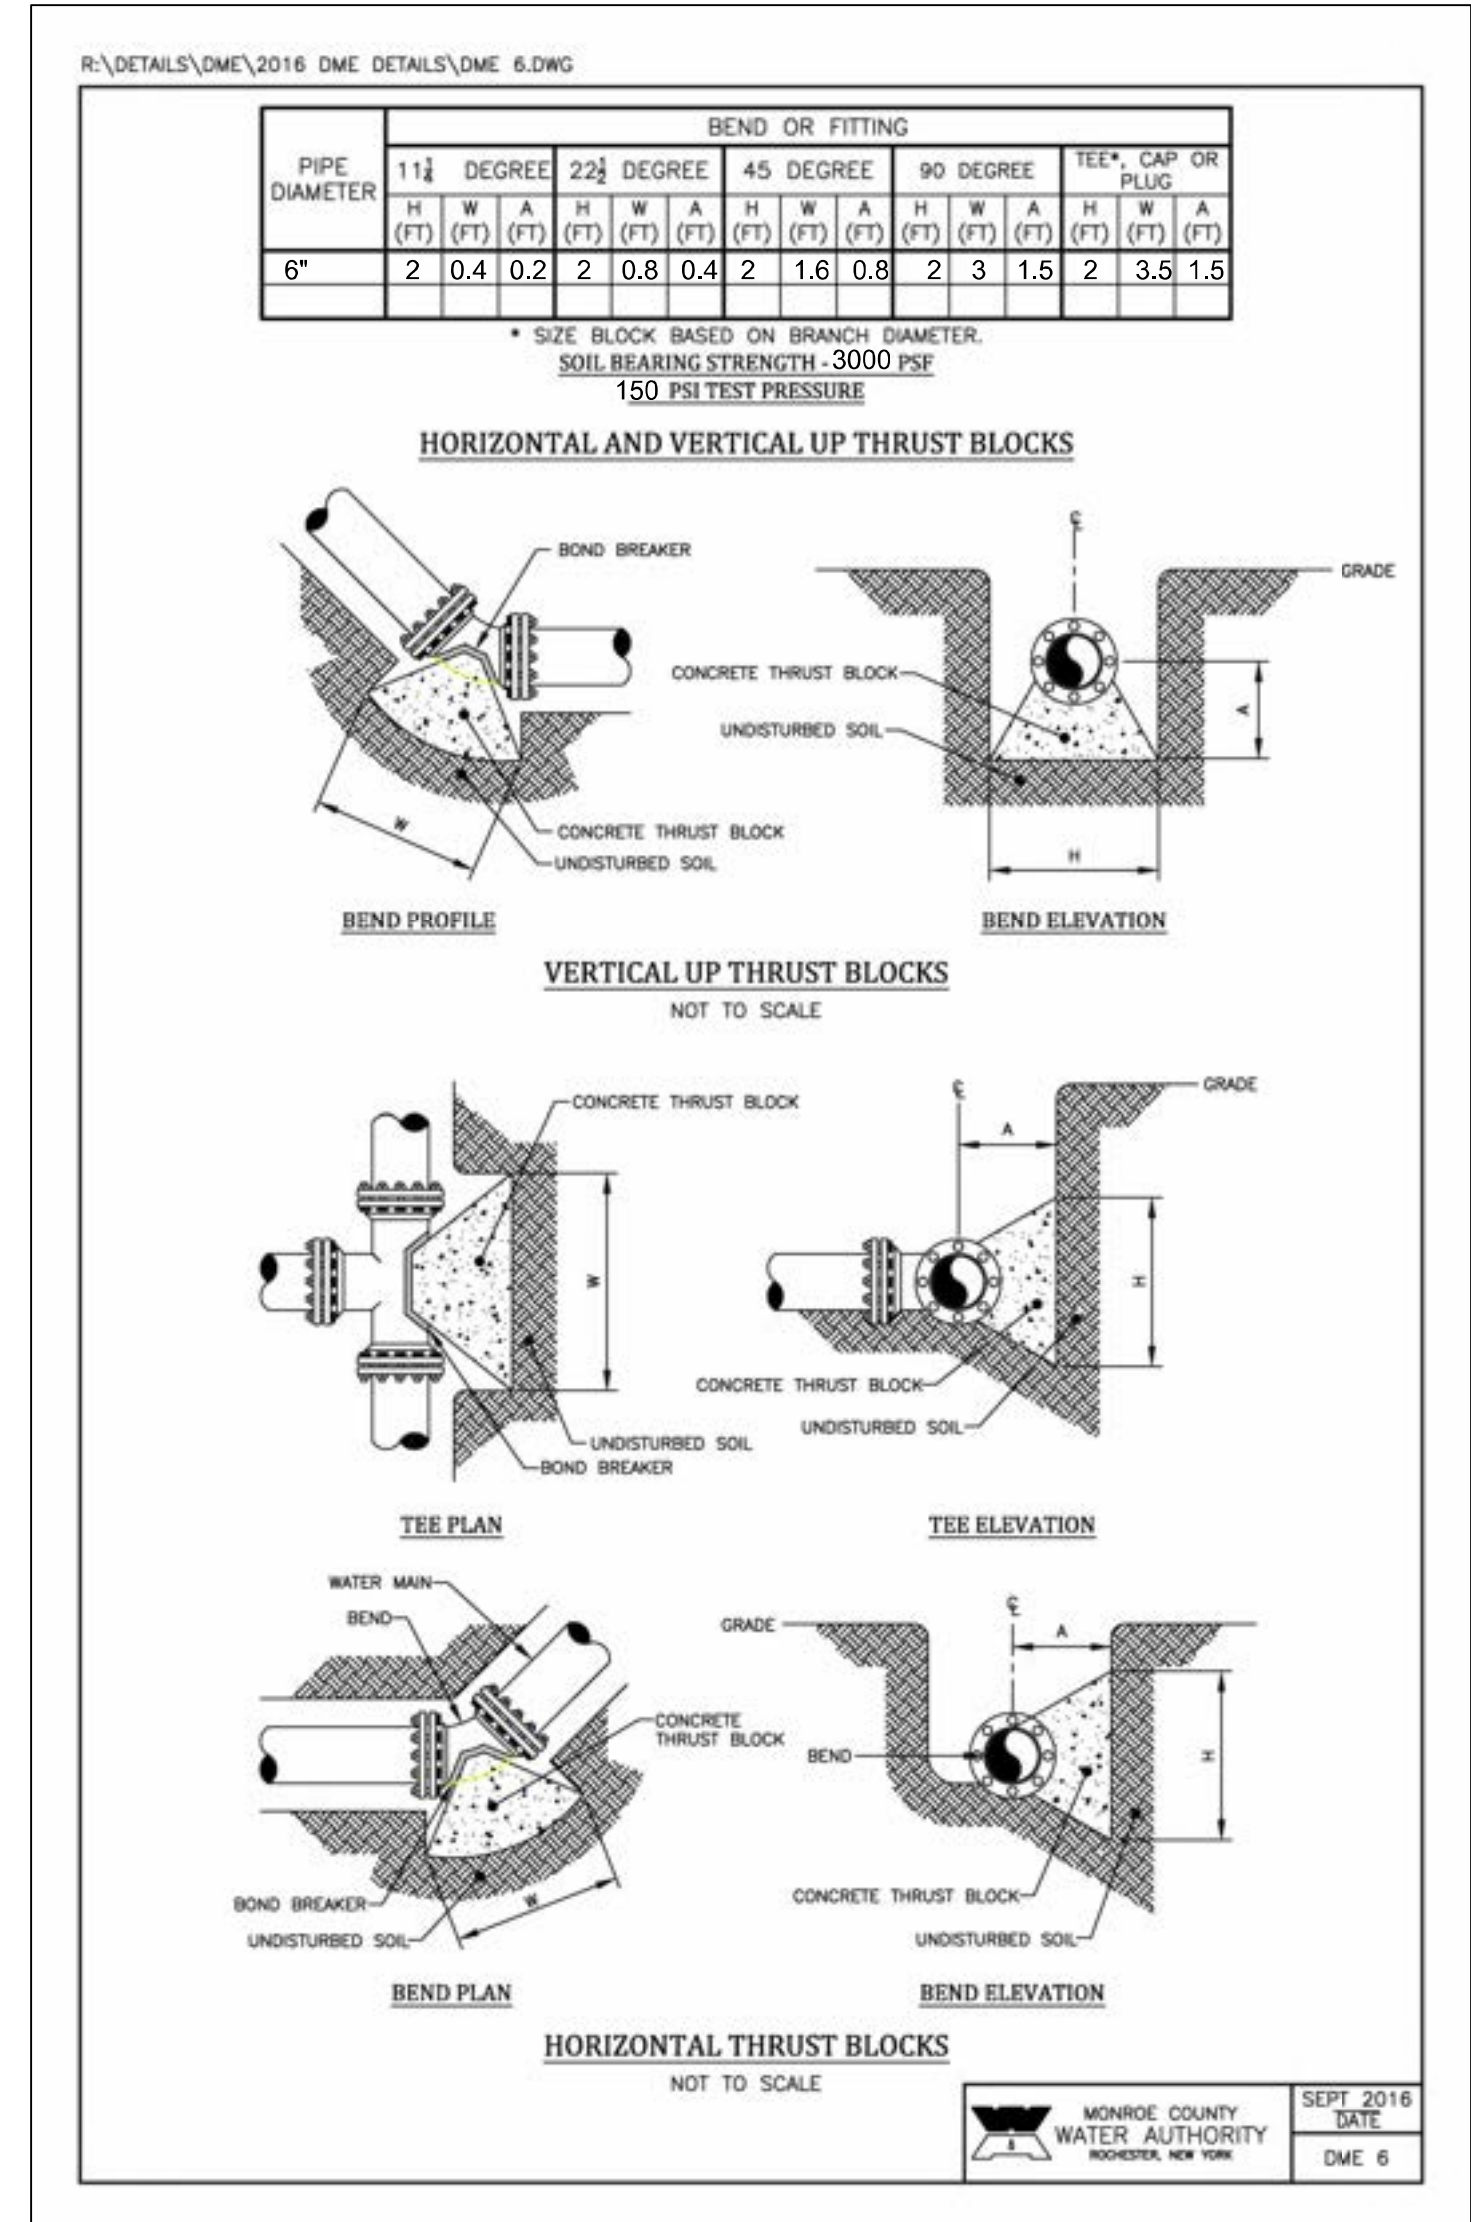

REVISIONS			
DATE	BY	DESCRIPTION	
3/12/25	SH	VILLAGE WATER DEPT INPUT	

DETAIL SHEET

TOWN OF WARSAW LIBRARY – 130 NORTH MAIN STREET
VILLAGE OF WARSAW, WYOMING COUNTY, NEW YORK STATE

PROFESSIONAL ENGINEERING GROUP

7171 VICTOR – PITTSFORD ROAD
VICTOR, NEW YORK 14564
TEL: (585) 924-1860 EMAIL: PROENGINEER1@PRODIGY.NET

DATE: MARCH 2025 ENGINEER: S.A.H DRAWN BY: S.A.H SCALE: AS SHOWN

CUSTOMERS:
BERO ARCHITECTS
32 WINTHROP STREET
ROCHESTER, NY 14607

TAX ACCOUNT NO. 85.8-1-20

SHEET NO.: C-2 DRAWING NO.: 250.30BDT1



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1653 East Main Street
Rochester, NY 14609

MEP/FP ENGINEER:



315 Rockingham Street
Rochester, NY 14620

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REVISIONS:

#	Date	Description

CLIENT / OWNER:



Town of Warsaw
83 Center Street
Warsaw, NY 14569

PROJECT INFORMATION:

Construction Documents
Warsaw Public Library
130 North Main Street, Warsaw, New York

PROJECT NUMBER: 22121

ISSUE DATE: 02/12/2025

DRAWN BY: SR

SHEET TITLE:

FRAMING PLAN

SHEET NUMBER:

S101

LEGEND

(+/- x'-xx") - DENOTES TOP OF STEEL ELEVATION WITH RESPECT TO DATUM ELEVATION

- DENOTES FRAMED OPENING. COORDINATE SIZE AND LOCATION WITH ARCHITECTURAL AND MECHANICAL DRAWINGS

NOTES

- DATUM ELEVATION = LOWER LEVEL FFE = 0'-0"
- TOP OF STEEL = +10'-0 1/2" (VIF)
- MAIN LEVEL TOP OF SLAB = +10'-4" (VIF)
- C3 = 3 1/2" TOTAL THICKNESS NORMAL WEIGHT CONCRETE SLAB ON 1 1/2" 20 GA COMPOSITE METAL DECK - VULCRAFT 1.5VL BASIS OF DESIGN. REINFORCE WITH 6"x6"-W1.4xW1.4 WWF OR 4 LBS/CY FORTA-FERRO (FORTA) MACRO-FIBER REINFORCING.
- SECTIONS INDICATED ARE TYPICAL FOR SIMILAR CONDITIONS.
- BEAMS ARE EQUALLY SPACED UNLESS NOTED OTHERWISE.
- COORDINATE FLOOR OPENINGS WITH MECHANICAL AND ARCHITECTURAL DRAWINGS. OPENINGS NOT INDICATED ON PLANS SHALL CONFORM TO TYPICAL DETAIL REQUIREMENTS.
- PROVIDE A MINIMUM 1/4" ANGLE OR BENT PLATE AT SLAB PERIMETERS UNO. COORDINATE ANGLE OR PLATE OVERHANG DIMENSIONS WITH ARCHITECTURAL DRAWINGS.
- SPLICE BEAMS AS REQUIRED FOR INSTALL. SEE S500 FOR TYPICAL DETAIL.
- L-1: DENOTES NEW (2) L3 1/2X3 1/2X5/16 GALV. EXTERIOR WALL LINTEL (SEE ARCH)



1 PARTIAL FLOOR FRAMING PLAN
1/4" = 1'-0"



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REVISIONS:

#	Date	Description

CLIENT / OWNER:



Town of Warsaw
83 Center Street
Warsaw, NY 14569

PROJECT INFORMATION:

Construction Documents
Warsaw Public Library
130 North Main Street, Warsaw, New York

PROJECT NUMBER: 22121

ISSUE DATE: 02/12/2025


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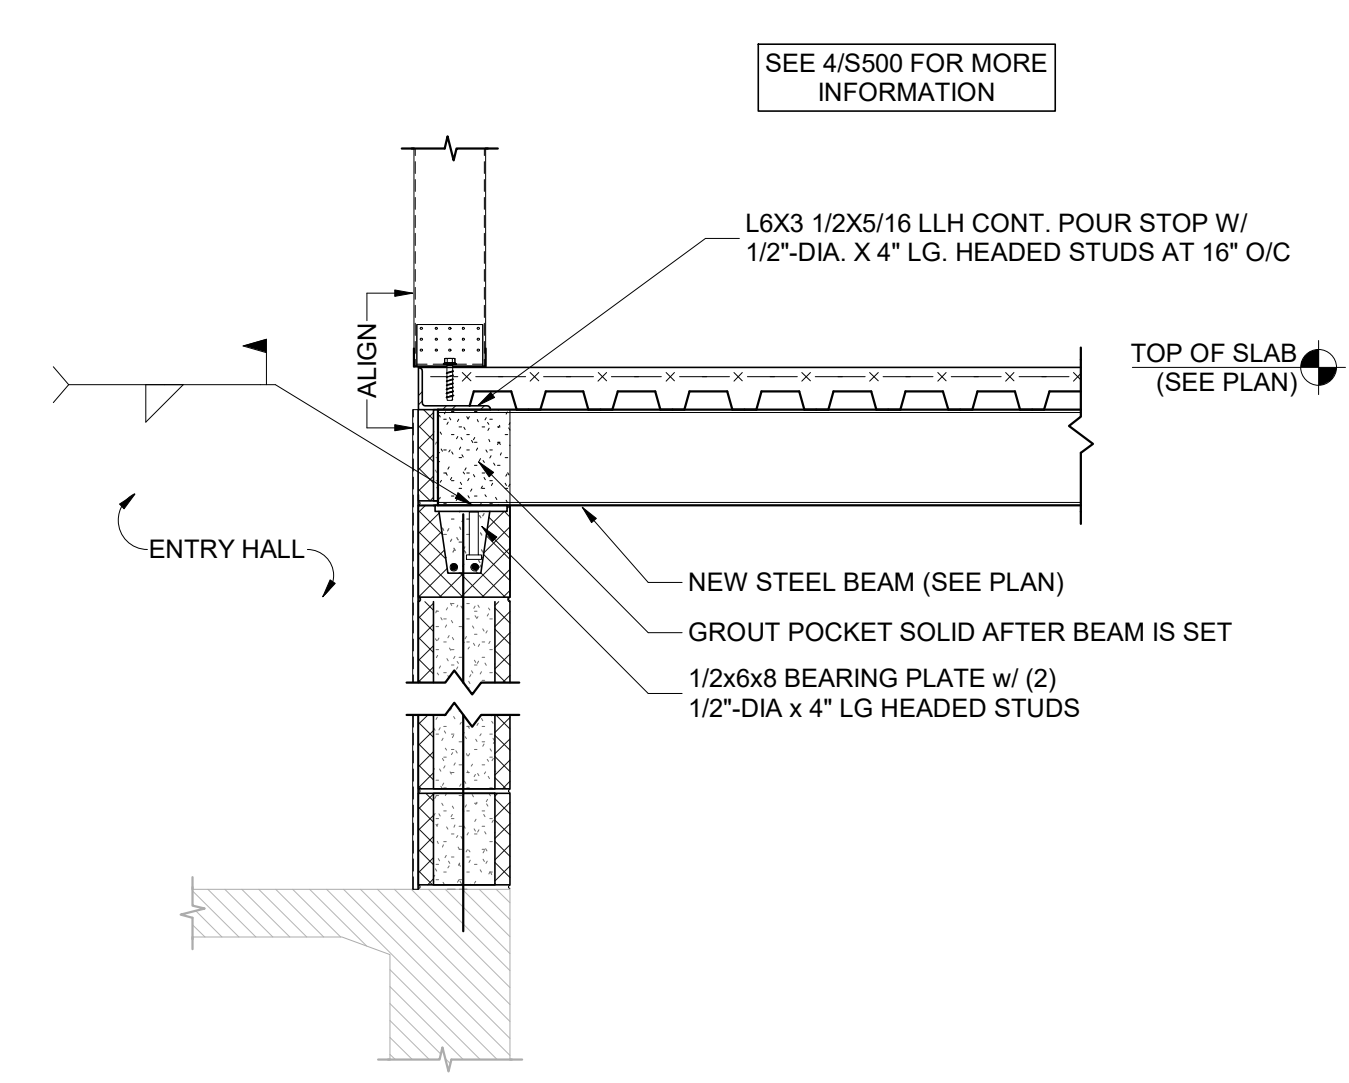
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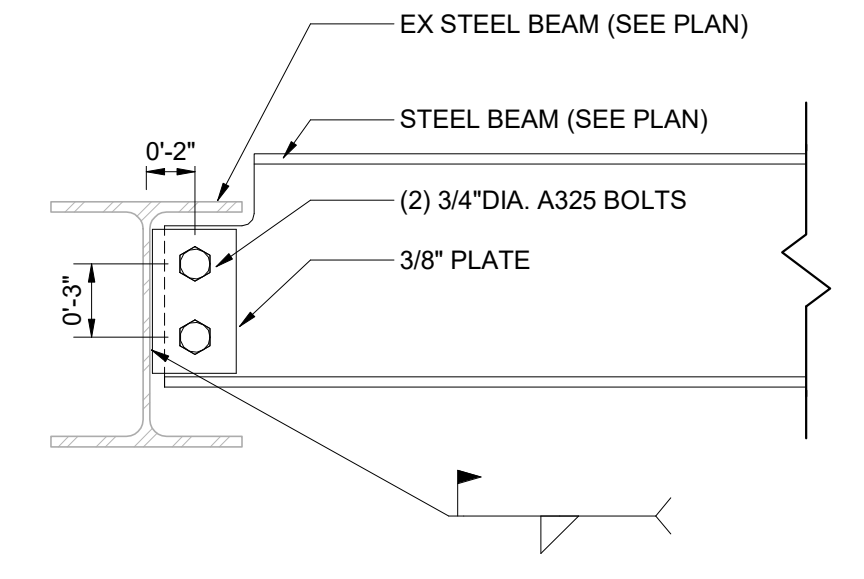
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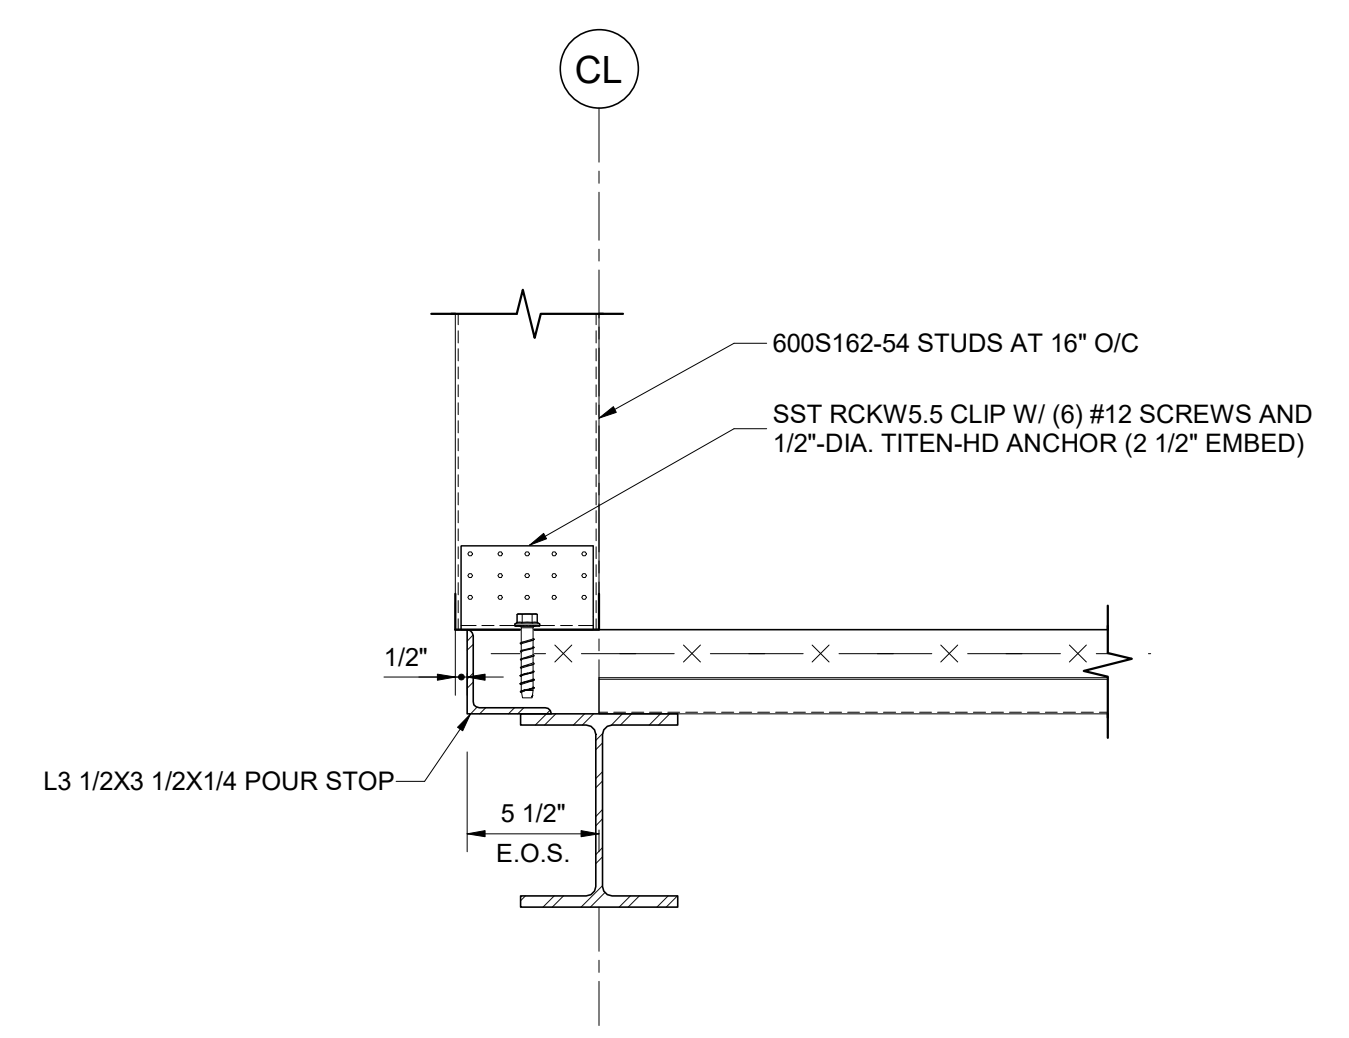
3 MASONRY BEAM POCKET IN EX BRICK
3/4" = 1'-0"




6 MASONRY BEAM POCKET IN NEW CMU
3/4" = 1'-0"




9 NEW BEAM TO EX W10
1 1/2" = 1'-0"

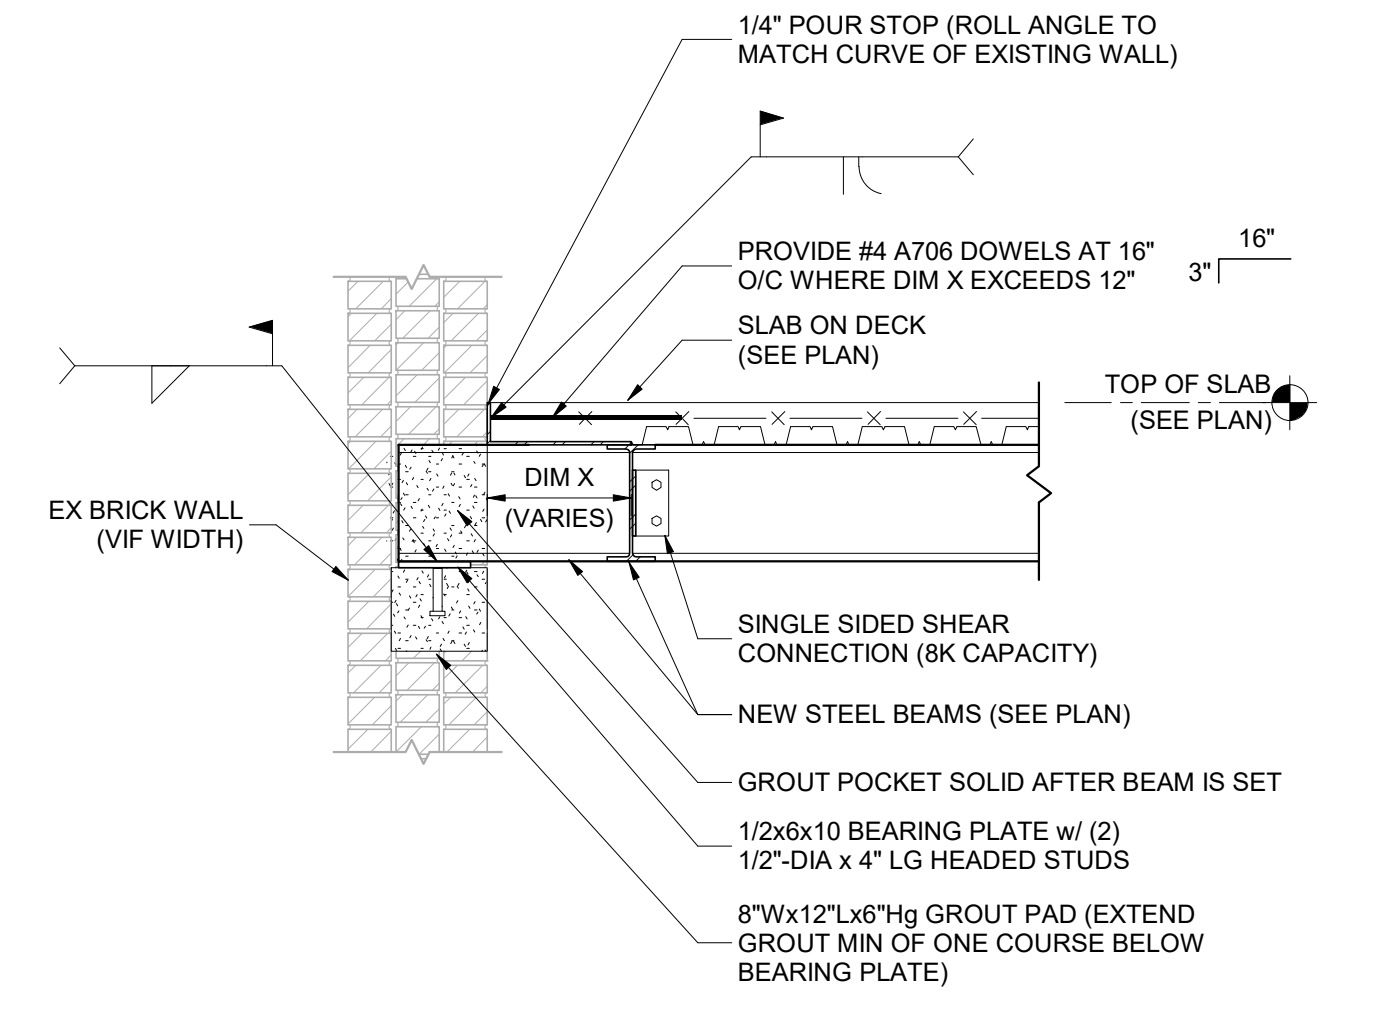


5 FLOOR OPENING
1 1/2" = 1'-0"

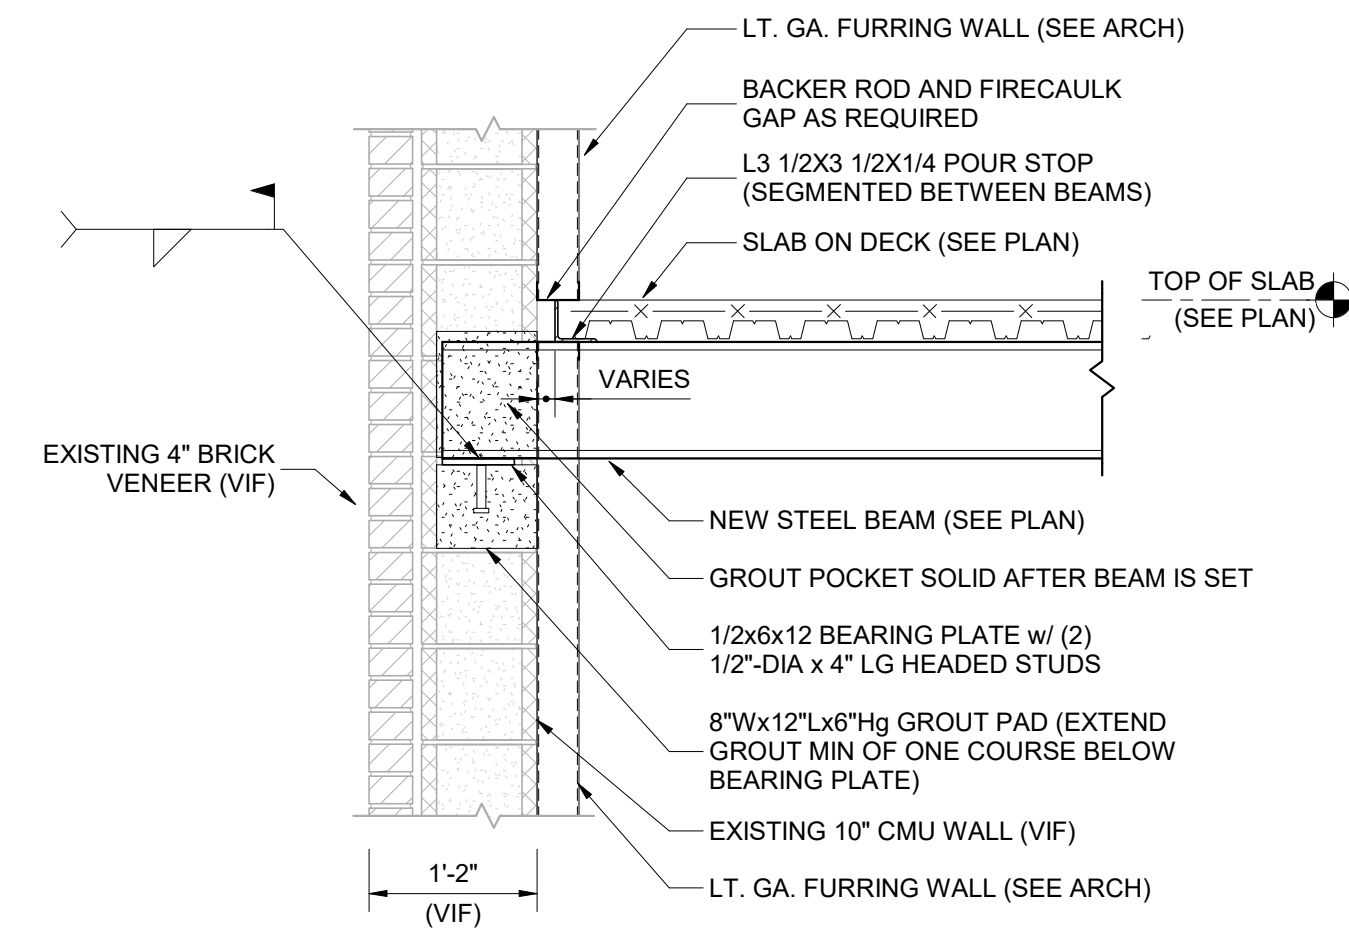


2 MASONRY BEAM POCKET IN EX CMU
3/4" = 1'-0"

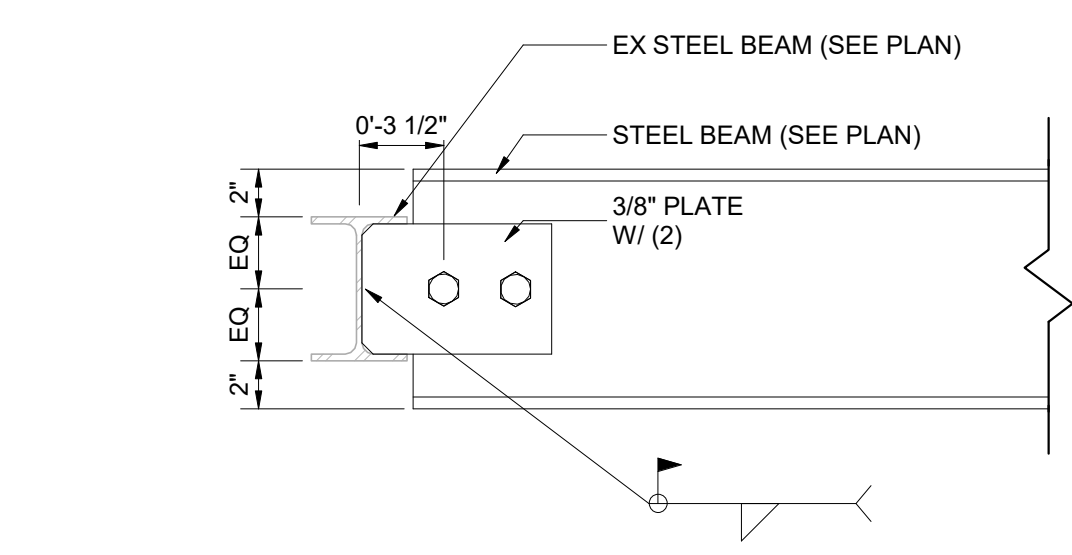


8 NEW BEAM TO EX W6
1 1/2" = 1'-0"

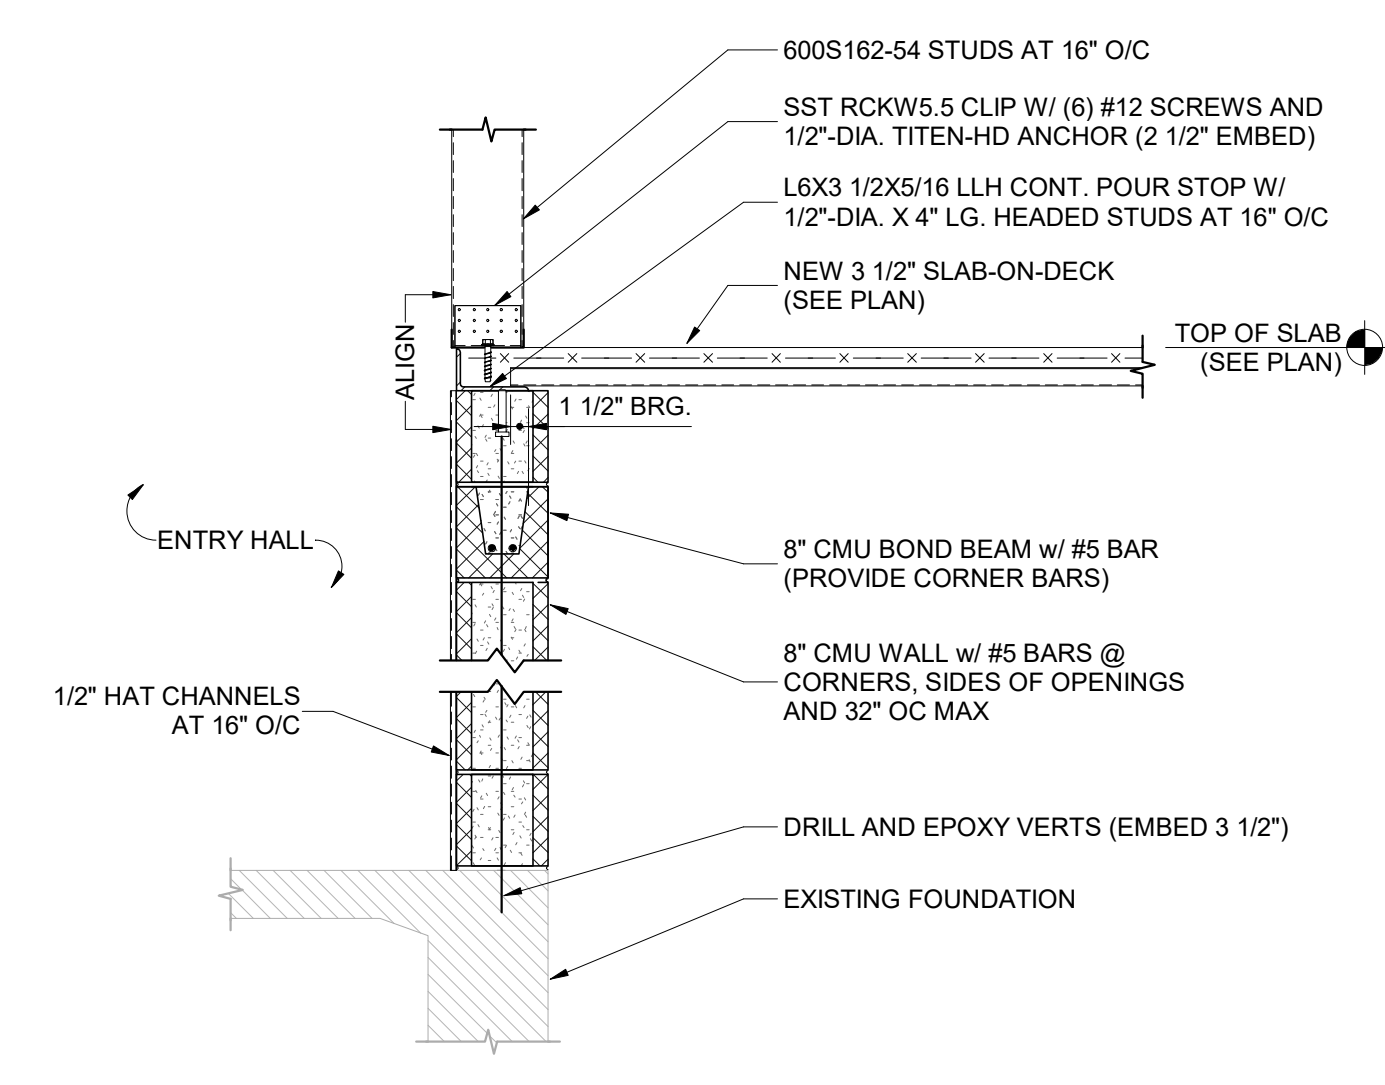


4 EDGE OF SLAB DETAIL
3/4" = 1'-0"

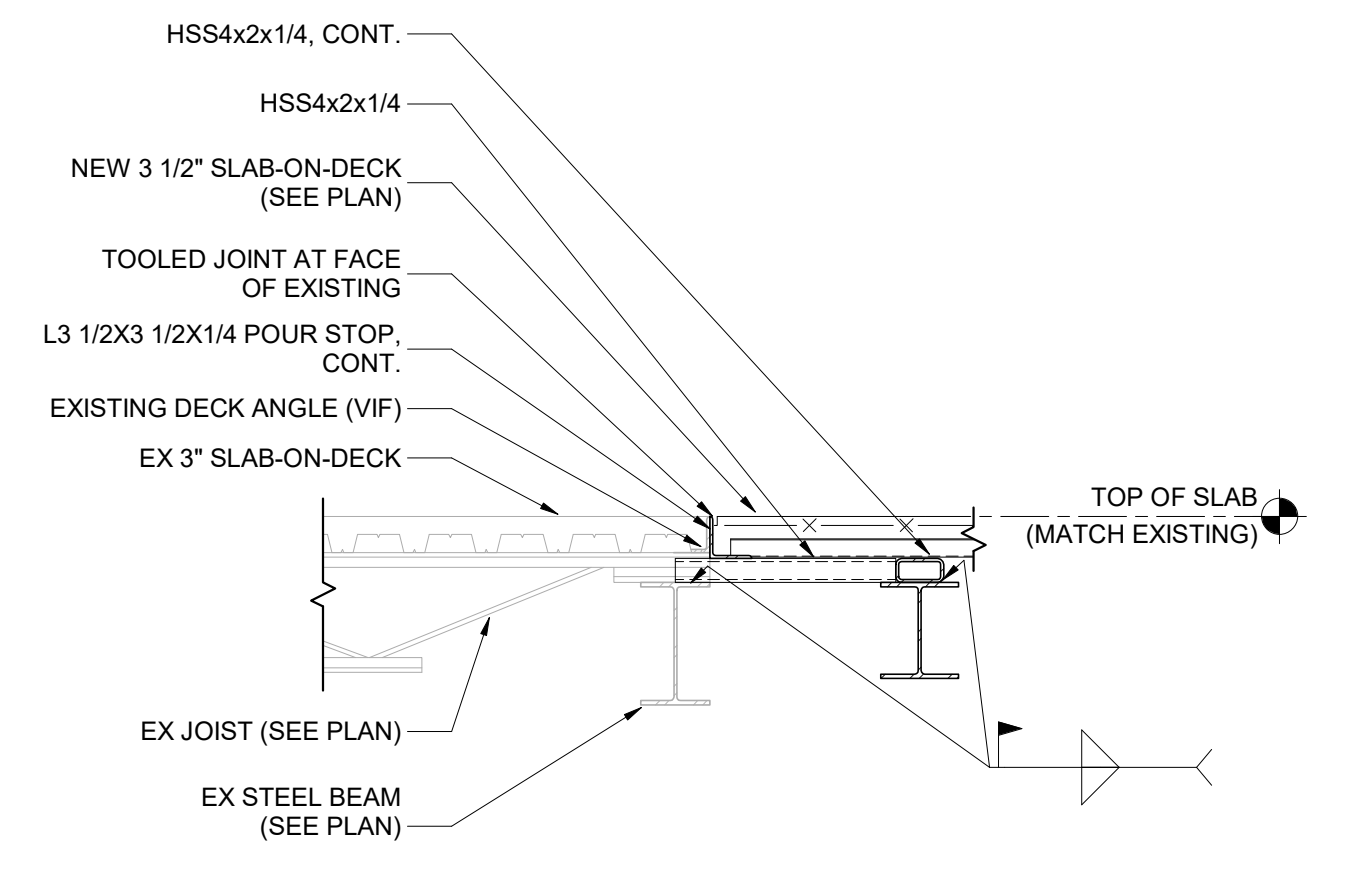


1 SLAB-ON-DECK @ EXISTING
3/4" = 1'-0"

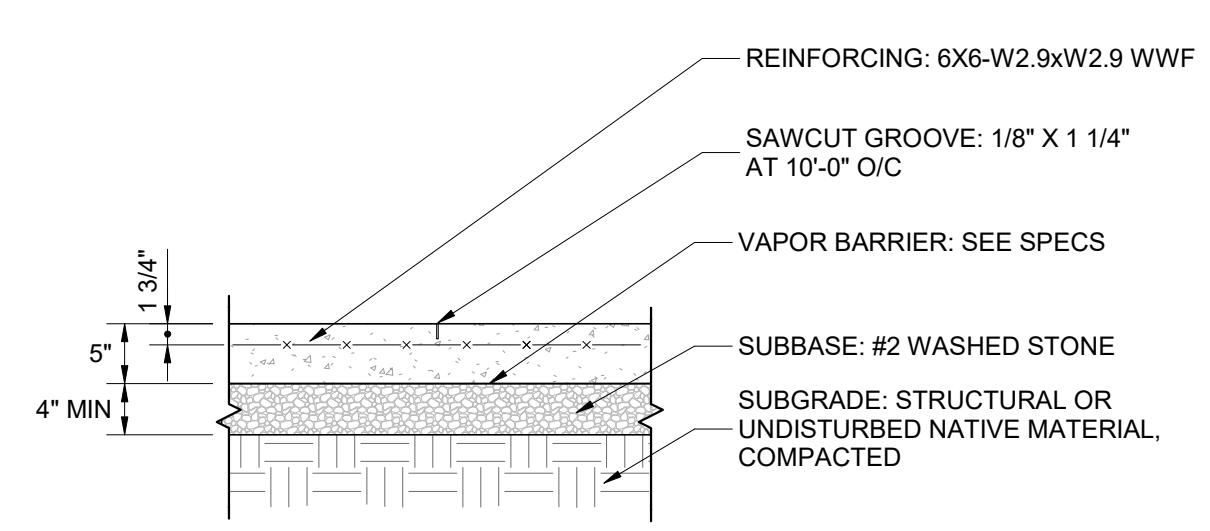


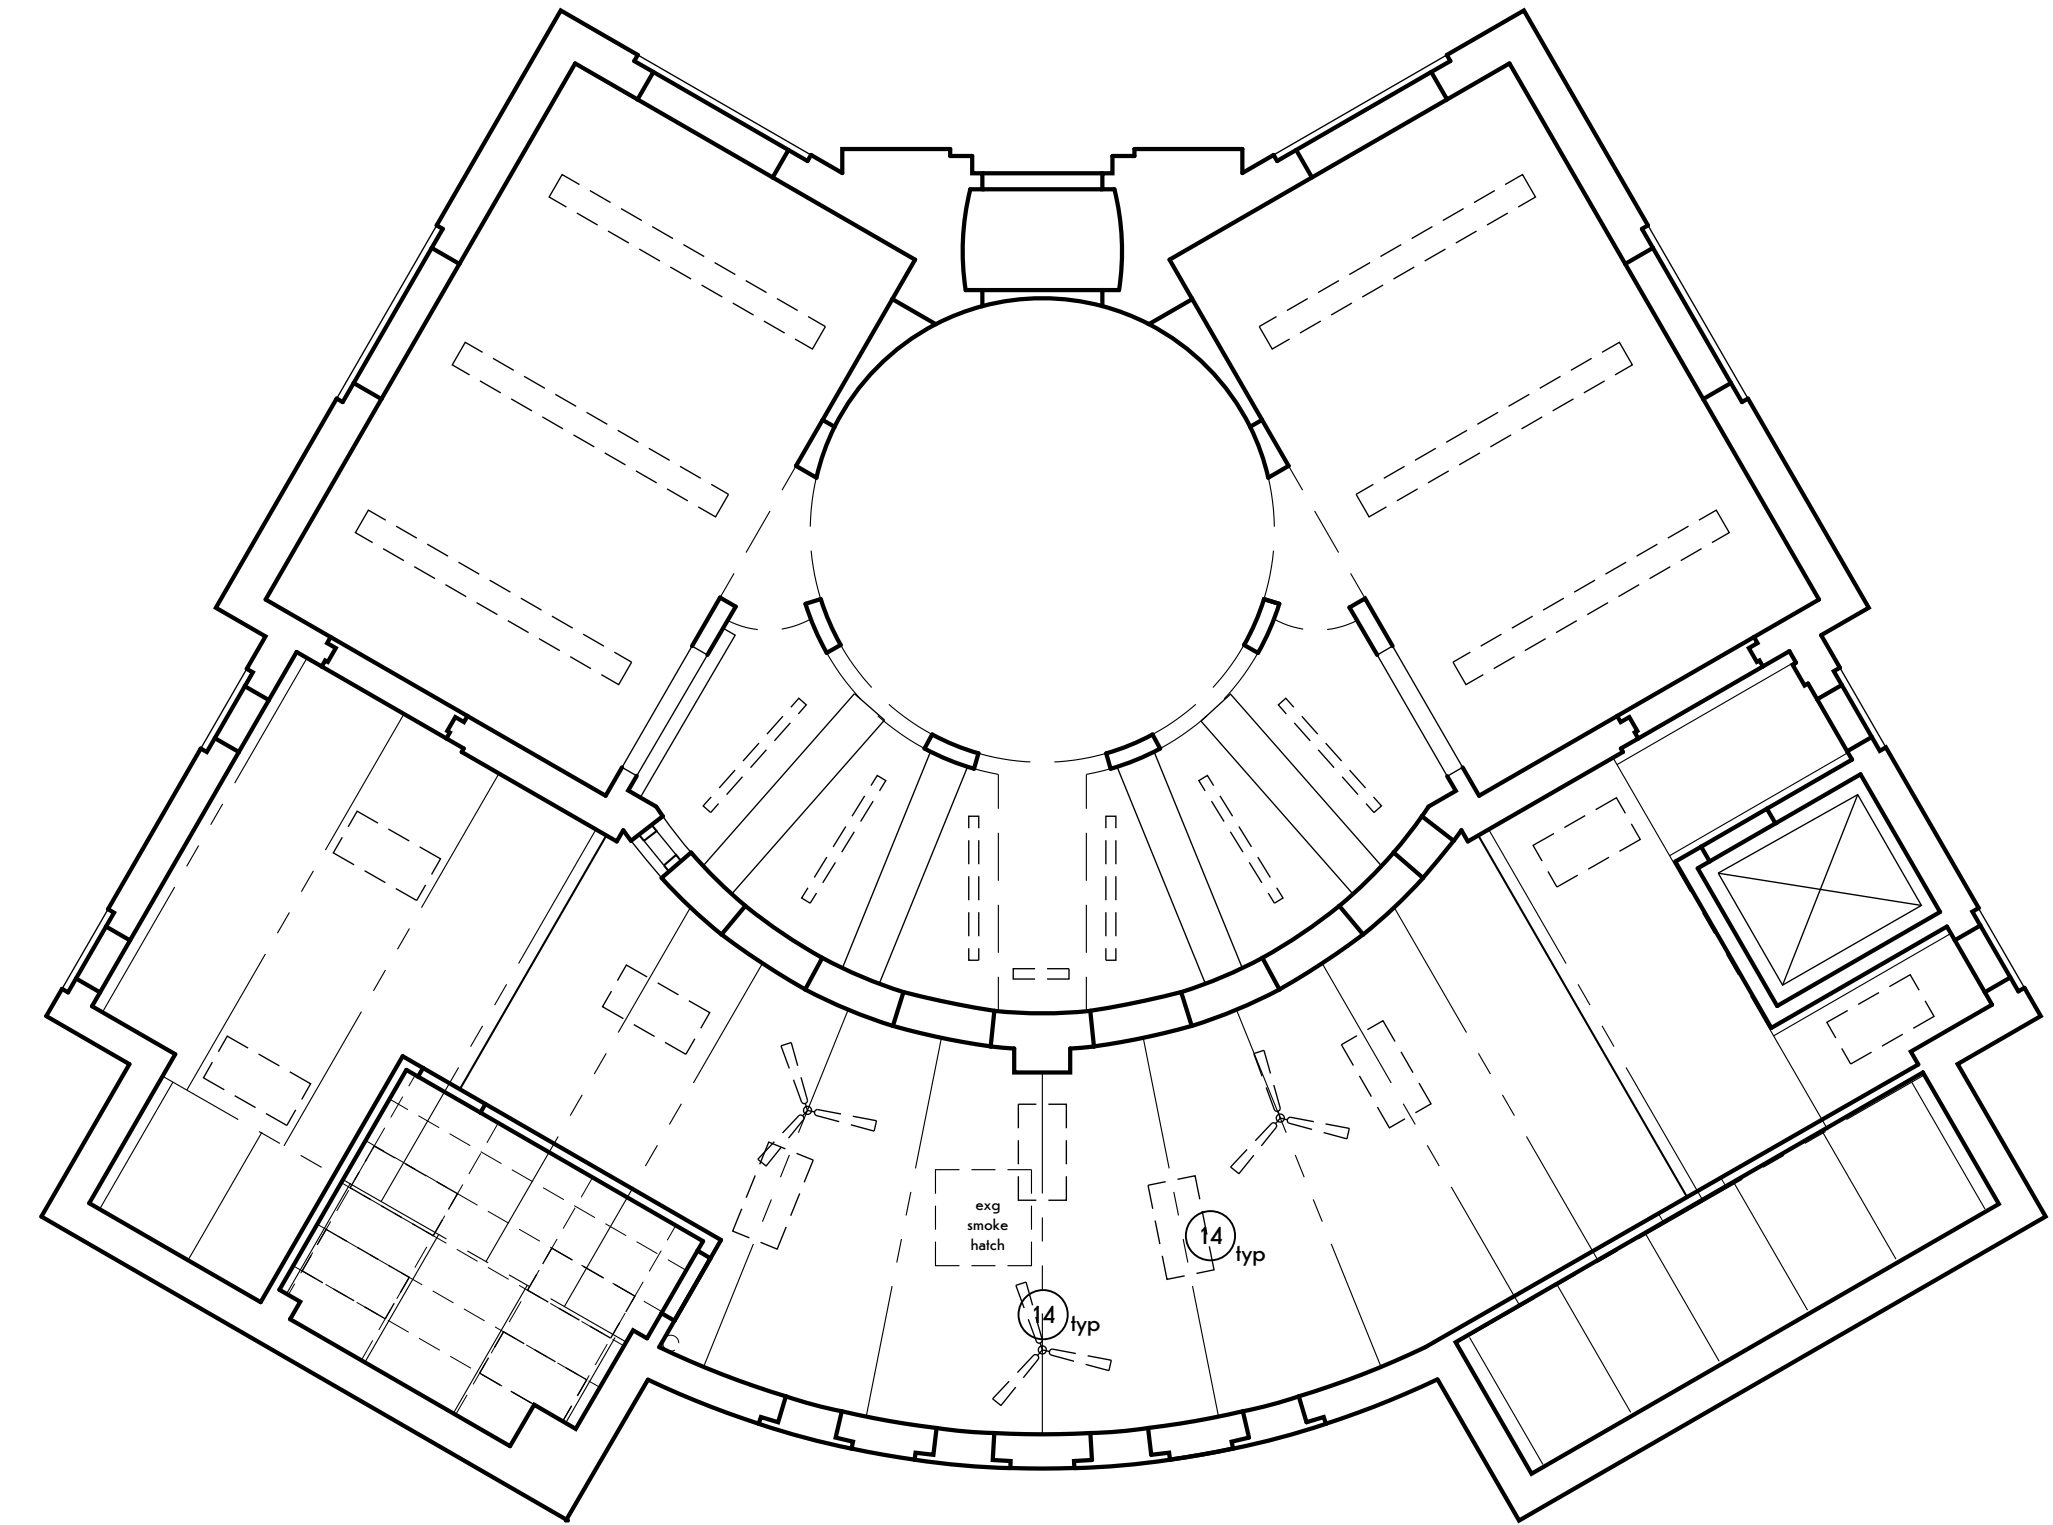
10 NEW SLAB ON GRADE - ALTERNATE NO. 1
3/4" = 1'-0"

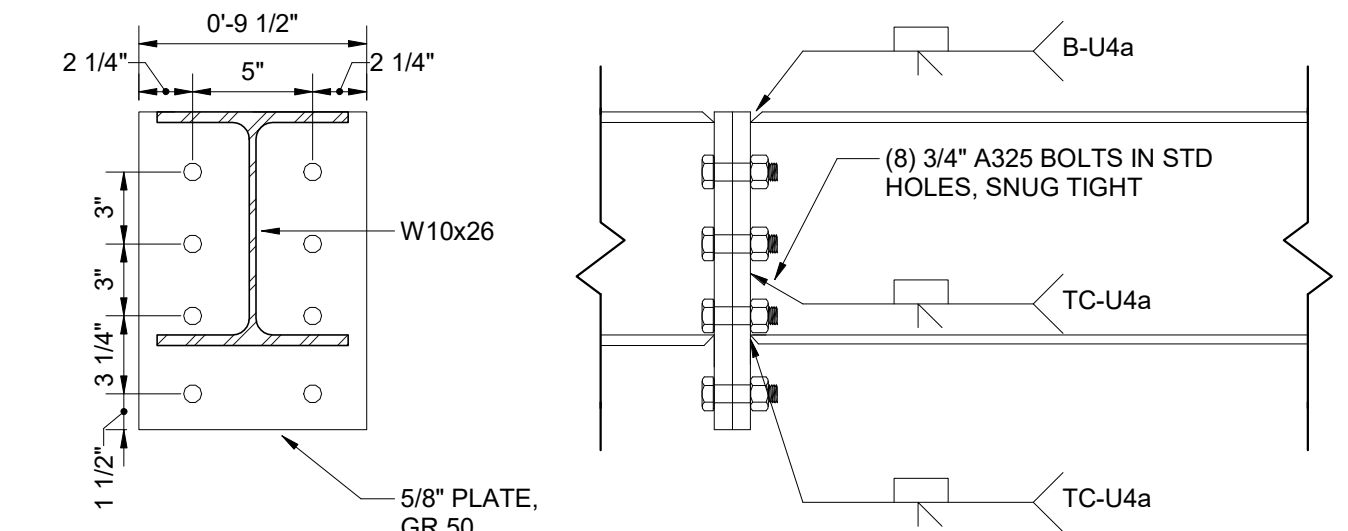


7 BEAM SPLICE DETAIL
1 1/2" = 1'-0"

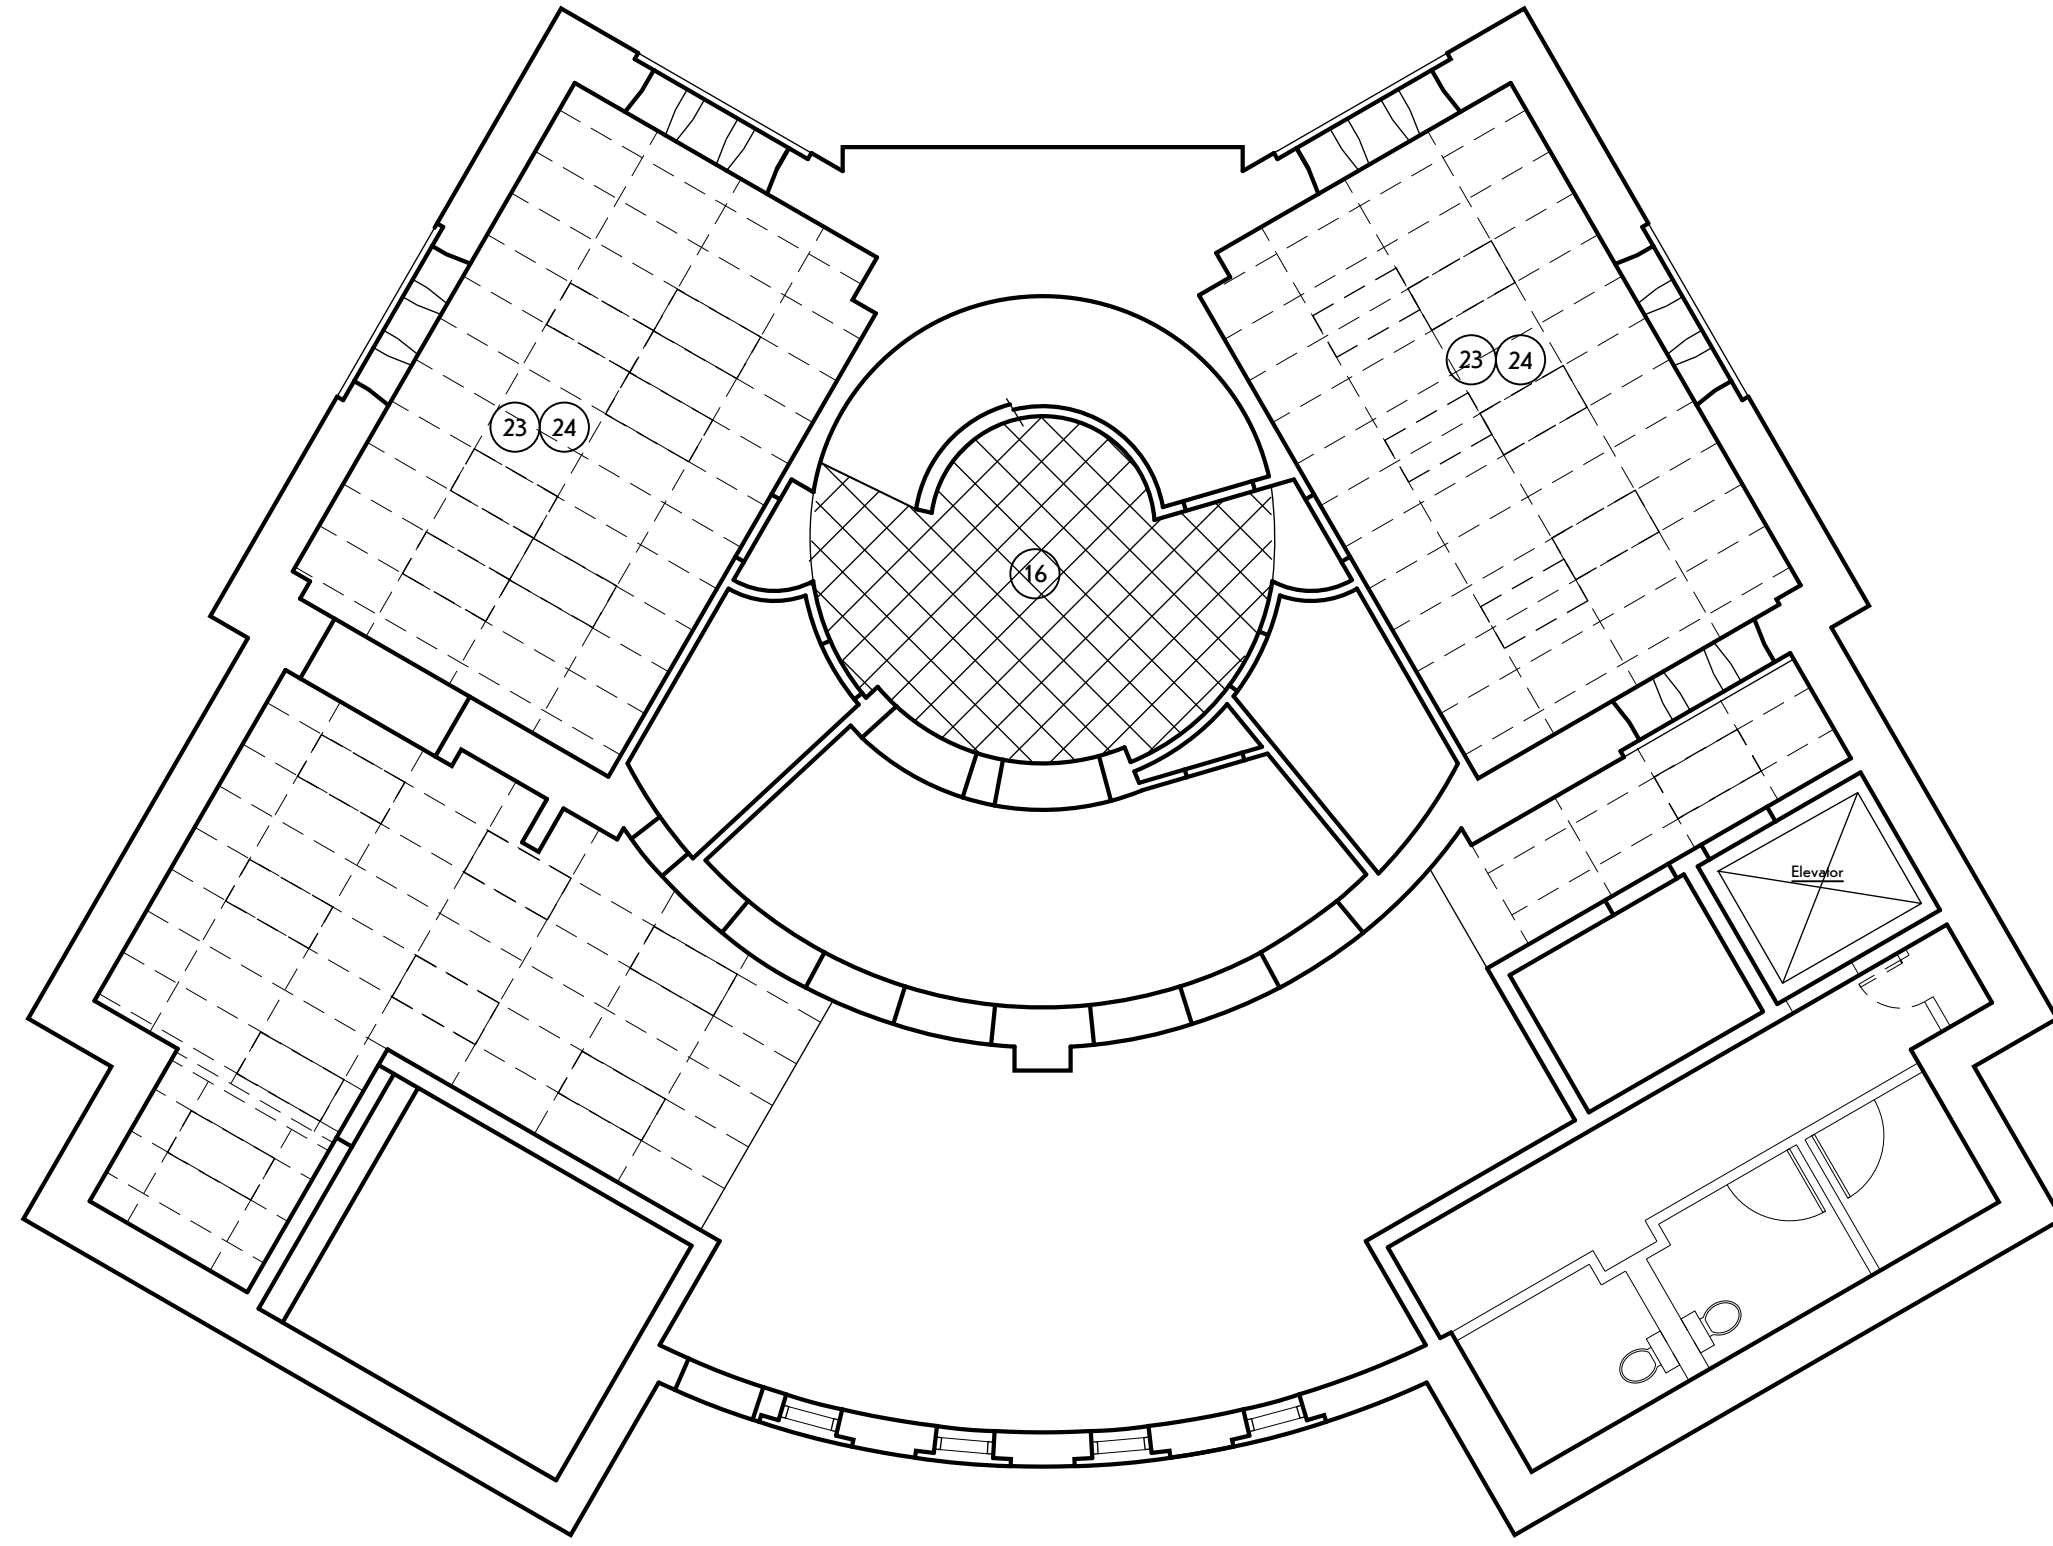


project N
 **2** Lower Level Demolition Reflected Ceiling Plan
 SCALE: 1/8" = 1'-0"



project N
 **4** Main Level Demolition Reflected Ceiling Plan
 SCALE: 1/8" = 1'-0"

DEMOLITION LEGEND:

- - - - - To be removed
- To remain
-  Remove ceiling/floor construction (Alternate No. 1)

GENERAL DEMOLITION NOTES:


1. Protect portions of building not scheduled for removal.
2. Remove carpet and rubber base, full extent of building.
3. Remove metal pipe rail at all, interior existing openings.
4. Elevator to be protected during construction.
5. Refer to MEP drawings for associated removals.


DEMOLITION NOTES:


1. Remove frame wall construction and window. Plumbing and Electrical Contract responsible for relocating power and plumbing in new walls.
2. Remove wall construction to finish floor level.
3. Salvage door and hardware for reinstallation. Store during construction.
4. Remove bifold door.
5. Remove cabinetry, sink, and remaining equipment.
6. Remove rubber stair treads and mastic to expose steel tread.
7. Asbestos containing flooring to be encapsulated.
8. Remove circulation desk casework.
9. Remove guardrail paneling full extent of low guardrail to expose original guardrail, contact Architect for inspection of existing conditions. Original rail is expected behind paneling.
10. Prep walls for paint, full extent of Rotunda and entry stair and Study Room 010.
11. Protect exg entrance mat system with pwd during construction.
12. Remove portion of exg window at floor level to provide new opening. Refer to 1/A-41 for extent of removals.
13. Remove desk and casework below stair.
14. Removal of fans and lighting responsibility of Electrical Contract.
15. Provide openings for wood windows at existing masonry wall.
16. Remove acoustic tile ceiling.
17. Remove fire rated door and frame.
18. Remove vertical wood wall trim.
19. Remove wallpaper, prep walls for paint finish. CG to provide openings as req'd to install ducts (Alternate No. 4), coord w/ Mechanical Contractor.


DEMOLITION NOTES - ALTERNATE NO. 1:

20. Remove wood floor and sleepers for inspection of existing concrete floor.
21. Remove conc floor, Allowance No. 1, and excavate as req'd for new slab.
22. Remove wall paneling.
23. Remove acoustical tile ceiling and grid.
24. Remove wood ceiling lathe and any remaining plaster.

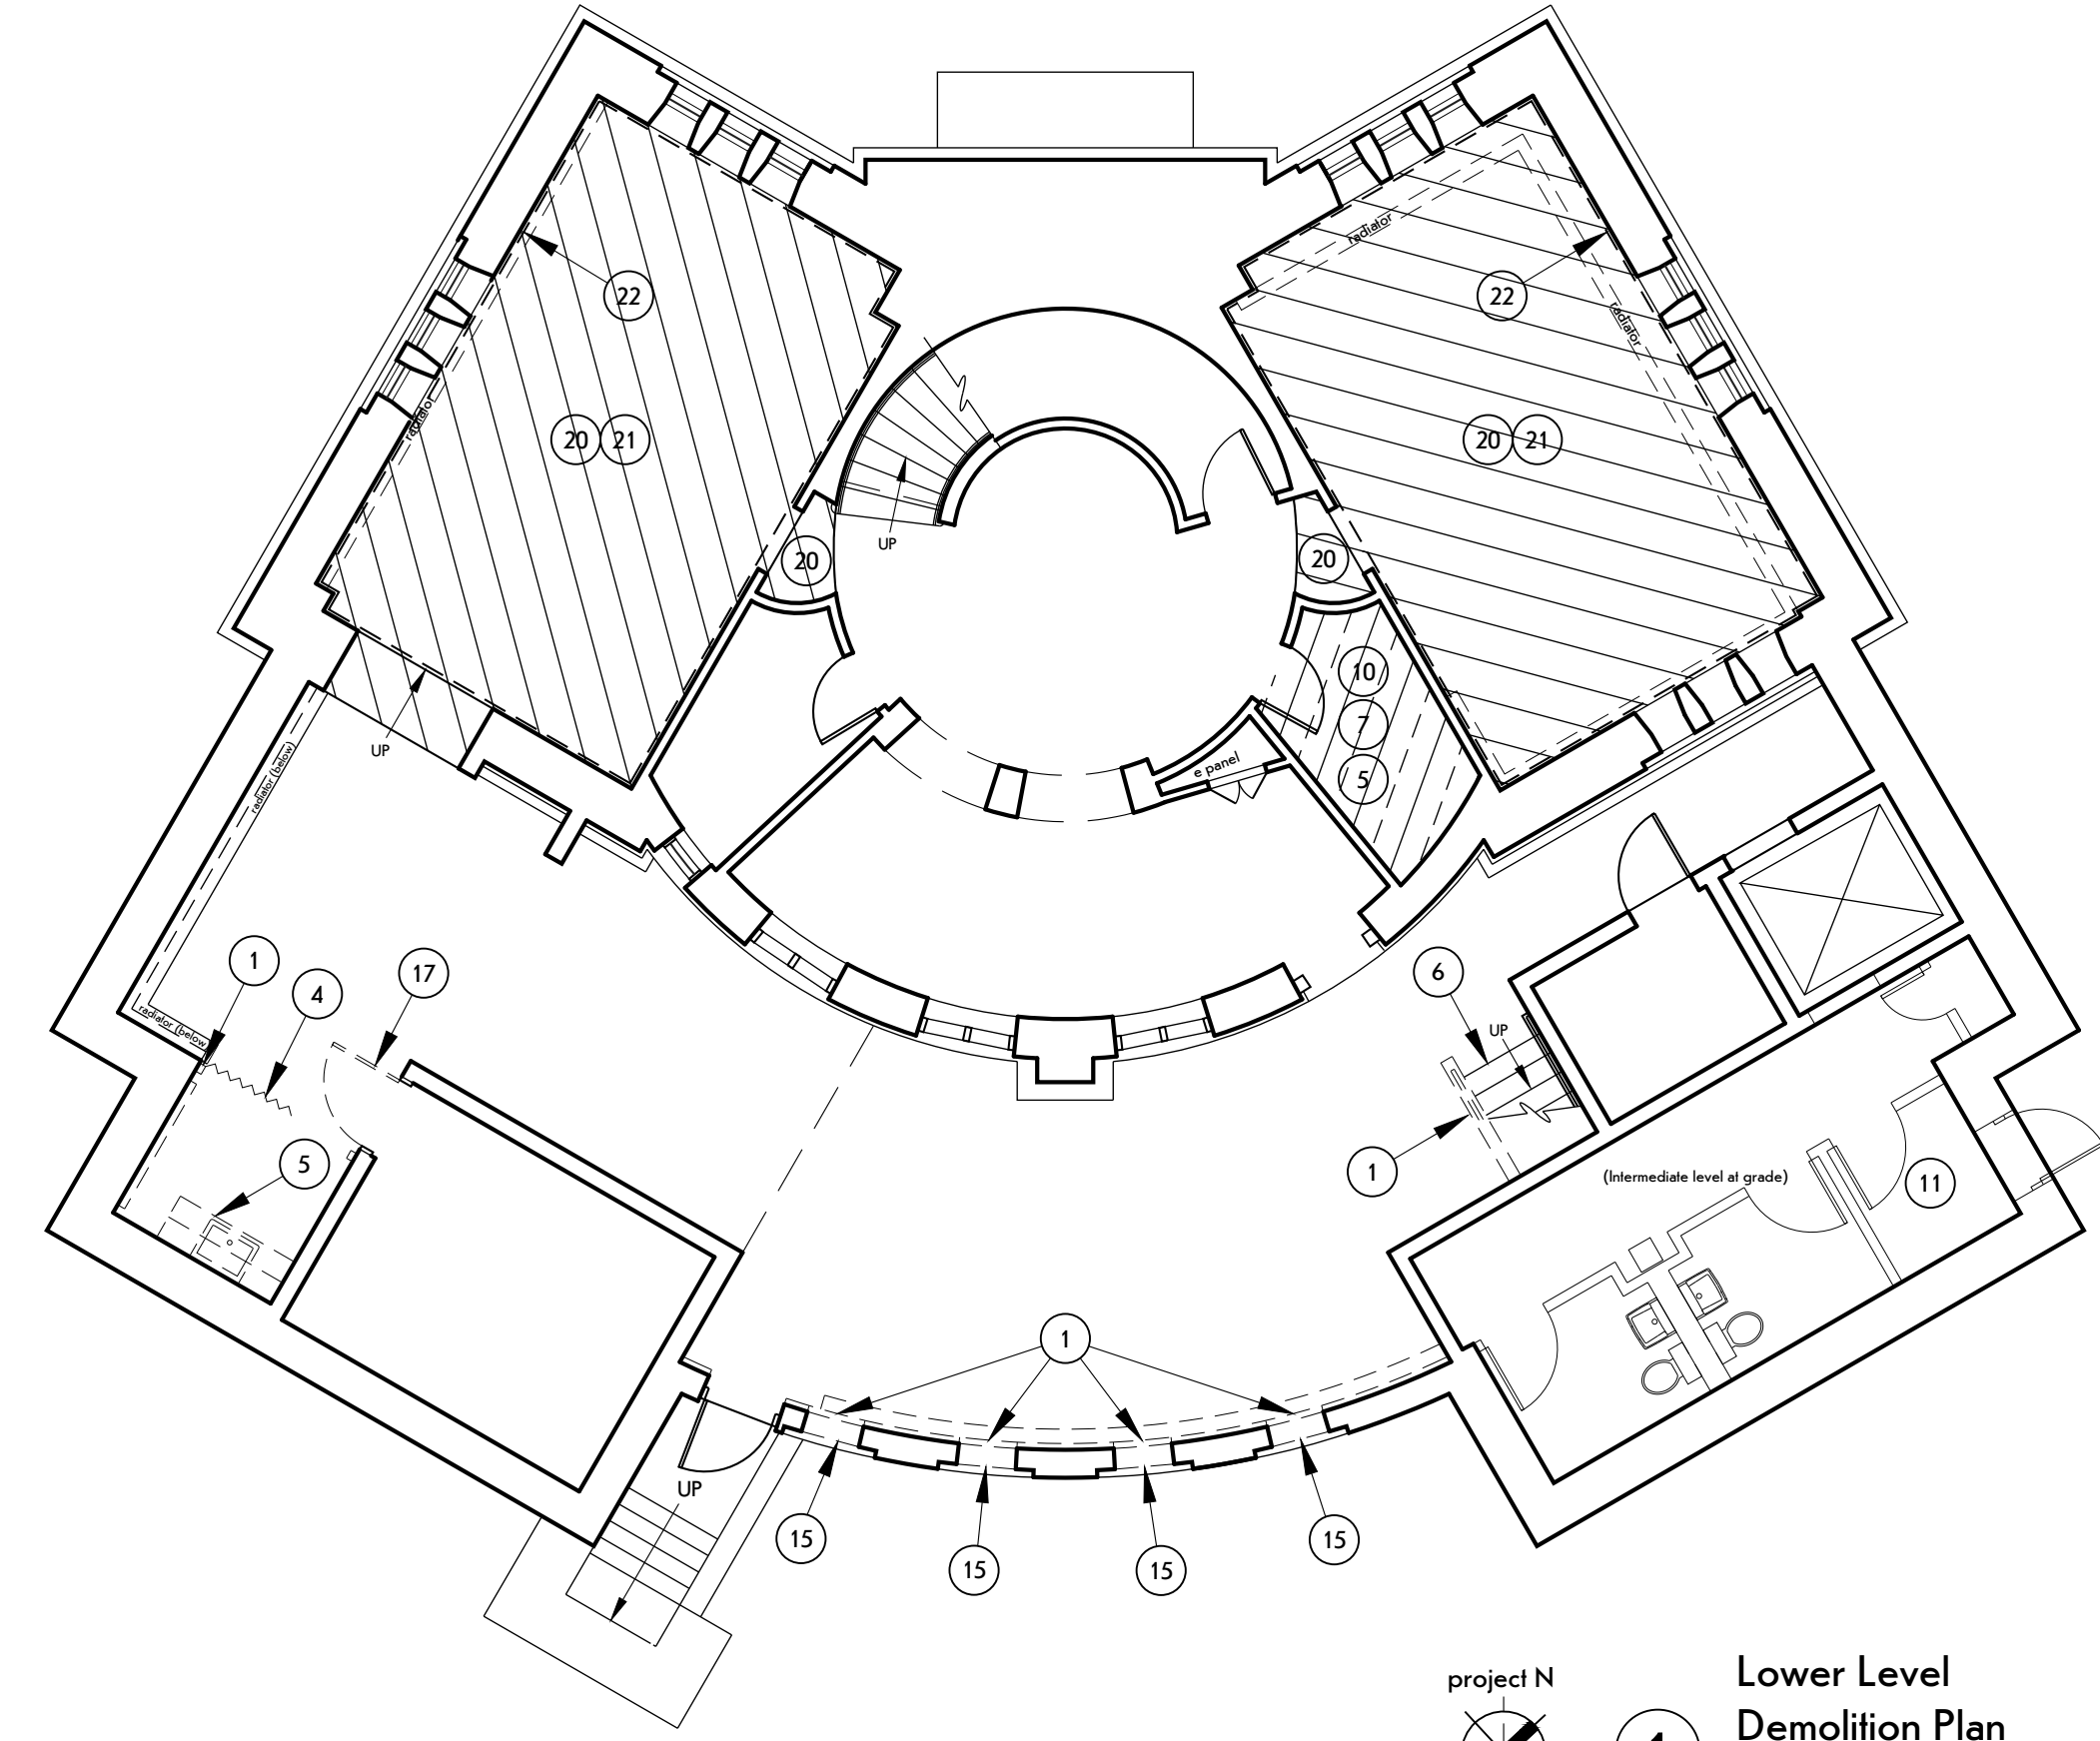

project N
 **1** Lower Level Demolition Plan
 SCALE: 1/8" = 1'-0"

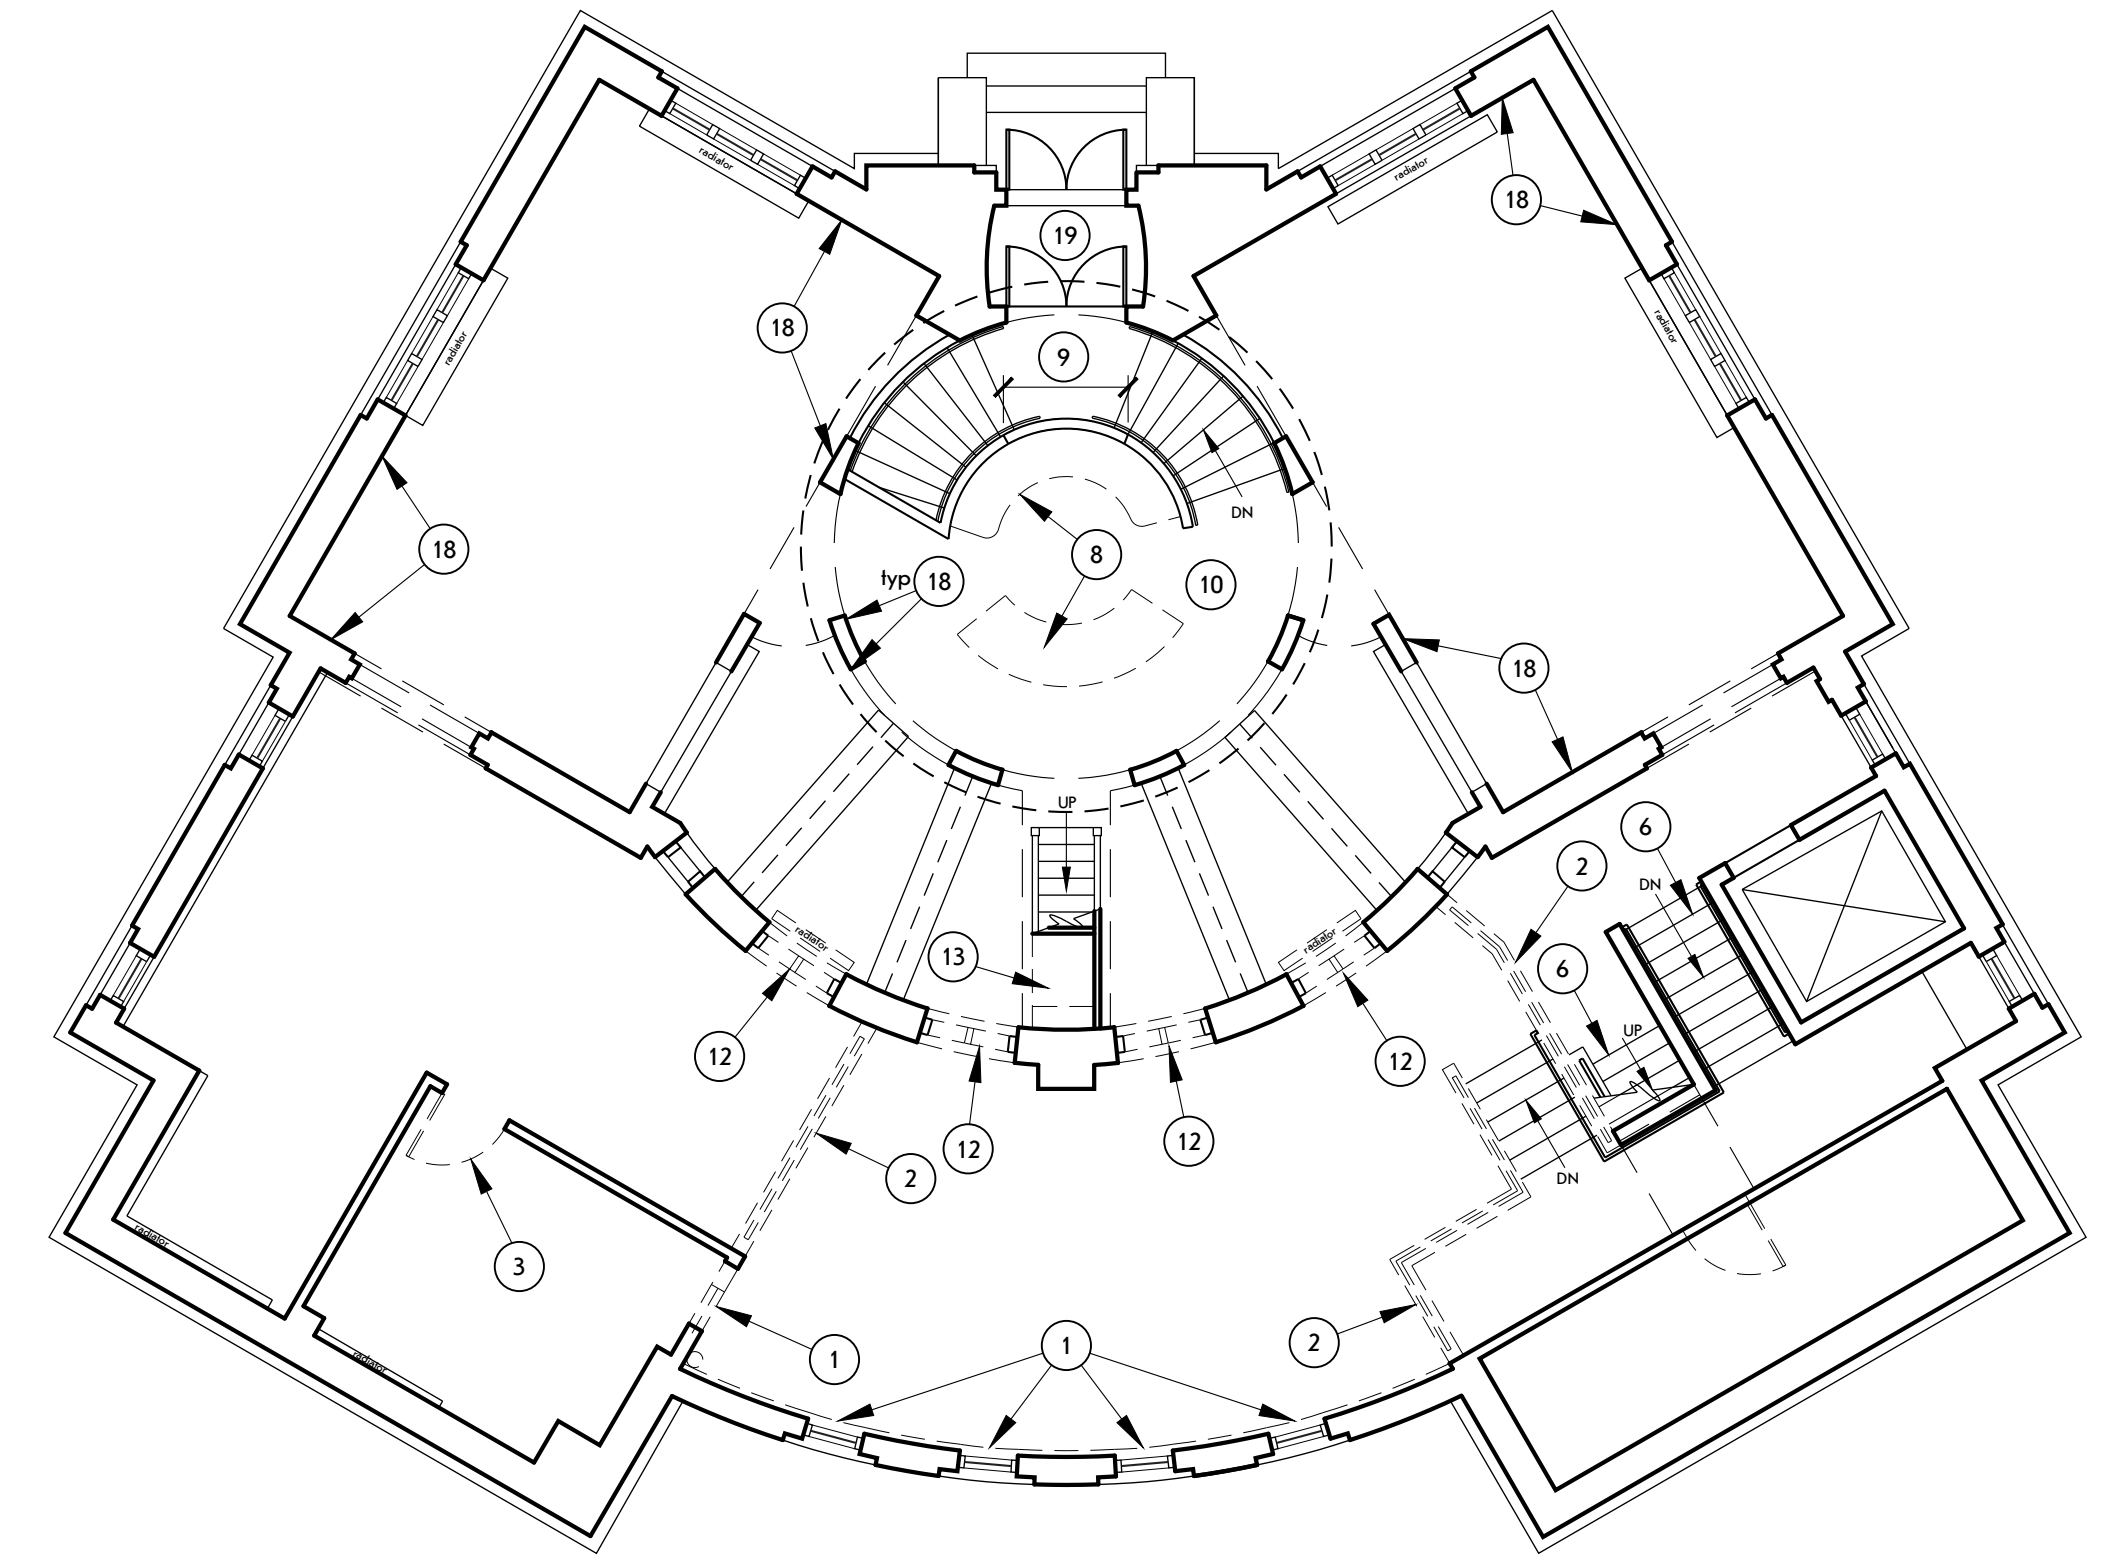

project N
 **3** Main Level Demolition Plan
 SCALE: 1/8" = 1'-0"



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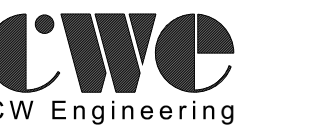
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 Rochester, NY 14609

MEP / FP ENGINEER:



315 Rockingham Street
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REVISIONS:

#	Date	Description

CLIENT / OWNER:



Town of Warsaw
 83 Center Street
 Warsaw, NY 14569

PROJECT INFORMATION:

Expansion and Renovation
 Warsaw Public Library
 130 North Main Street, Warsaw, New York

PROJECT NUMBER: 22121

ISSUE DATE: February 25, 2025

DRAWN BY: LMY

SHEET TITLE:

Main & Lower Level
 Demolition Plan

SHEET NUMBER:

D-10





ROOM FINISH SCHEDULE											
NO.	ROOM NAME	FLOORING				WALLS		CEILING			NOTES
		MAT'L	FC	MAT'L	FC	MAT'L	FC	MAT'L	FC	HGHT.	
001	Meeting Room	cpl	-	rbr	-	e gpdw/gpdw	pnt	apc	-	8'-0"	-
002	not used	-	-	-	-	-	-	-	-	-	-
003	Children's Programming	cpl / lvt	-	rbr	-	e gpdw	pnt	apc	-	8'-0"	-
004	Kitchenette	lvt	-	rbr	-	e gpdw	pnt	apc	-	8'-0"	-
006	Children's Collection	cpl	-	wd	pnt	gpdw	pnt	apc/gpdw	-/pnt	7'-0"/8'-6"	(1) (3) Alternate No. 1
007	Lower Rotunda	cpl	-	wd	pnt	e plas	pnt	gpdw	-	9'-0"	(4)
008	Children's Librarian	cpl	-	e wd	pnt	e plas	pnt	e plas	pnt	9'-0"	-
009	Juvenile Fiction	cpl	-	rbr	-	e gpdw	pnt	e apc	-	6'-4 1/2"	-
010	Study Room	cpl	-	e wd	pnt	e plas	pnt	e plas	pnt	9'-0"	(2)
012	Young Adult	cpl	-	wd	pnt	gpdw	-	apc/gpdw	-/pnt	7'-0"/8'-6"	(1) (3) (5) Alternate No.1
013	Hallway	cpl	-	rbr	-	e gpdw	pnt	apc	-	8'-0"	-
015	Storage	cpl	-	rbr	-	gpdw	pnt	-	-	-	-
020	Entry Hall	e vct	-	e rbr	-	e gpdw	pnt	-	-	-	-

FINISH KEY:

act	Acoustical panel ceiling
bbbd	Beadboard
cpl	Carpet
cmu	Concrete masonry unit
e	Existing
gpdw	Gypsum drywall
lvt	Luxury vinyl tile
plas	Plaster
pnt	Paint
pol	Polished (concrete)
ref	Refinish
rbr	Rubber
stn	Stain and Clear Finish
vct	Vinyl Composite Tile
wd	Wood

LIGHTING TYPES
For reference only, refer to electrical plans

	Flat panel		Suspended indirect/direct
	Wall sconce		Surface mounted strip light
	Surface-mount fixture		

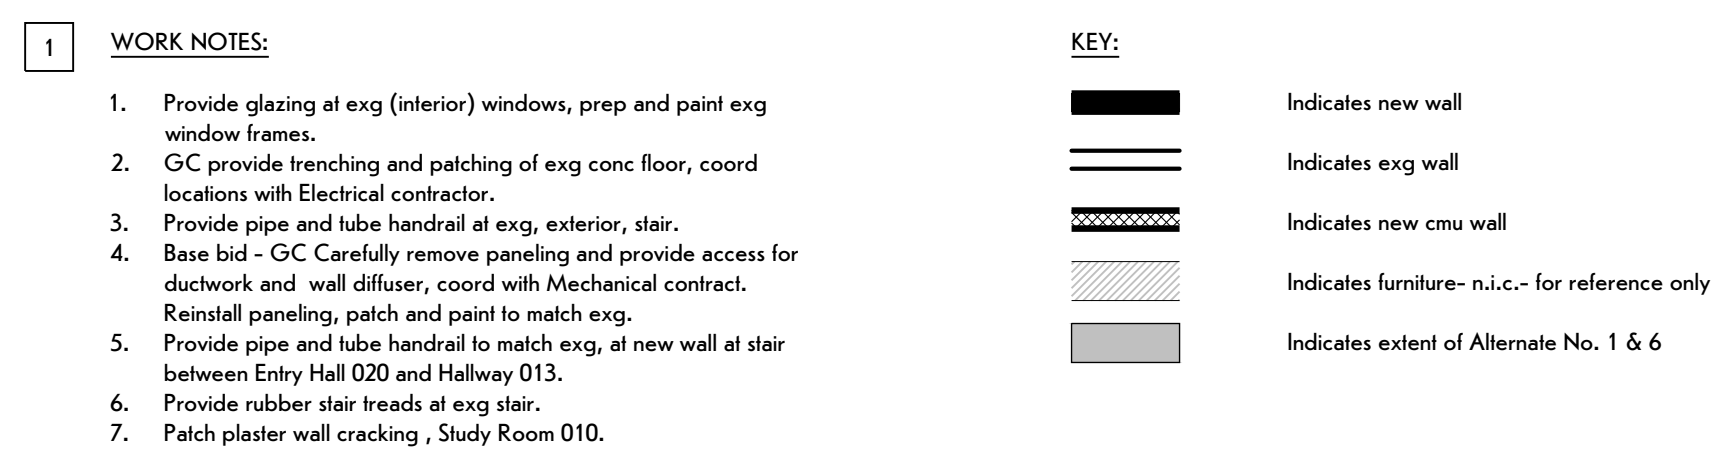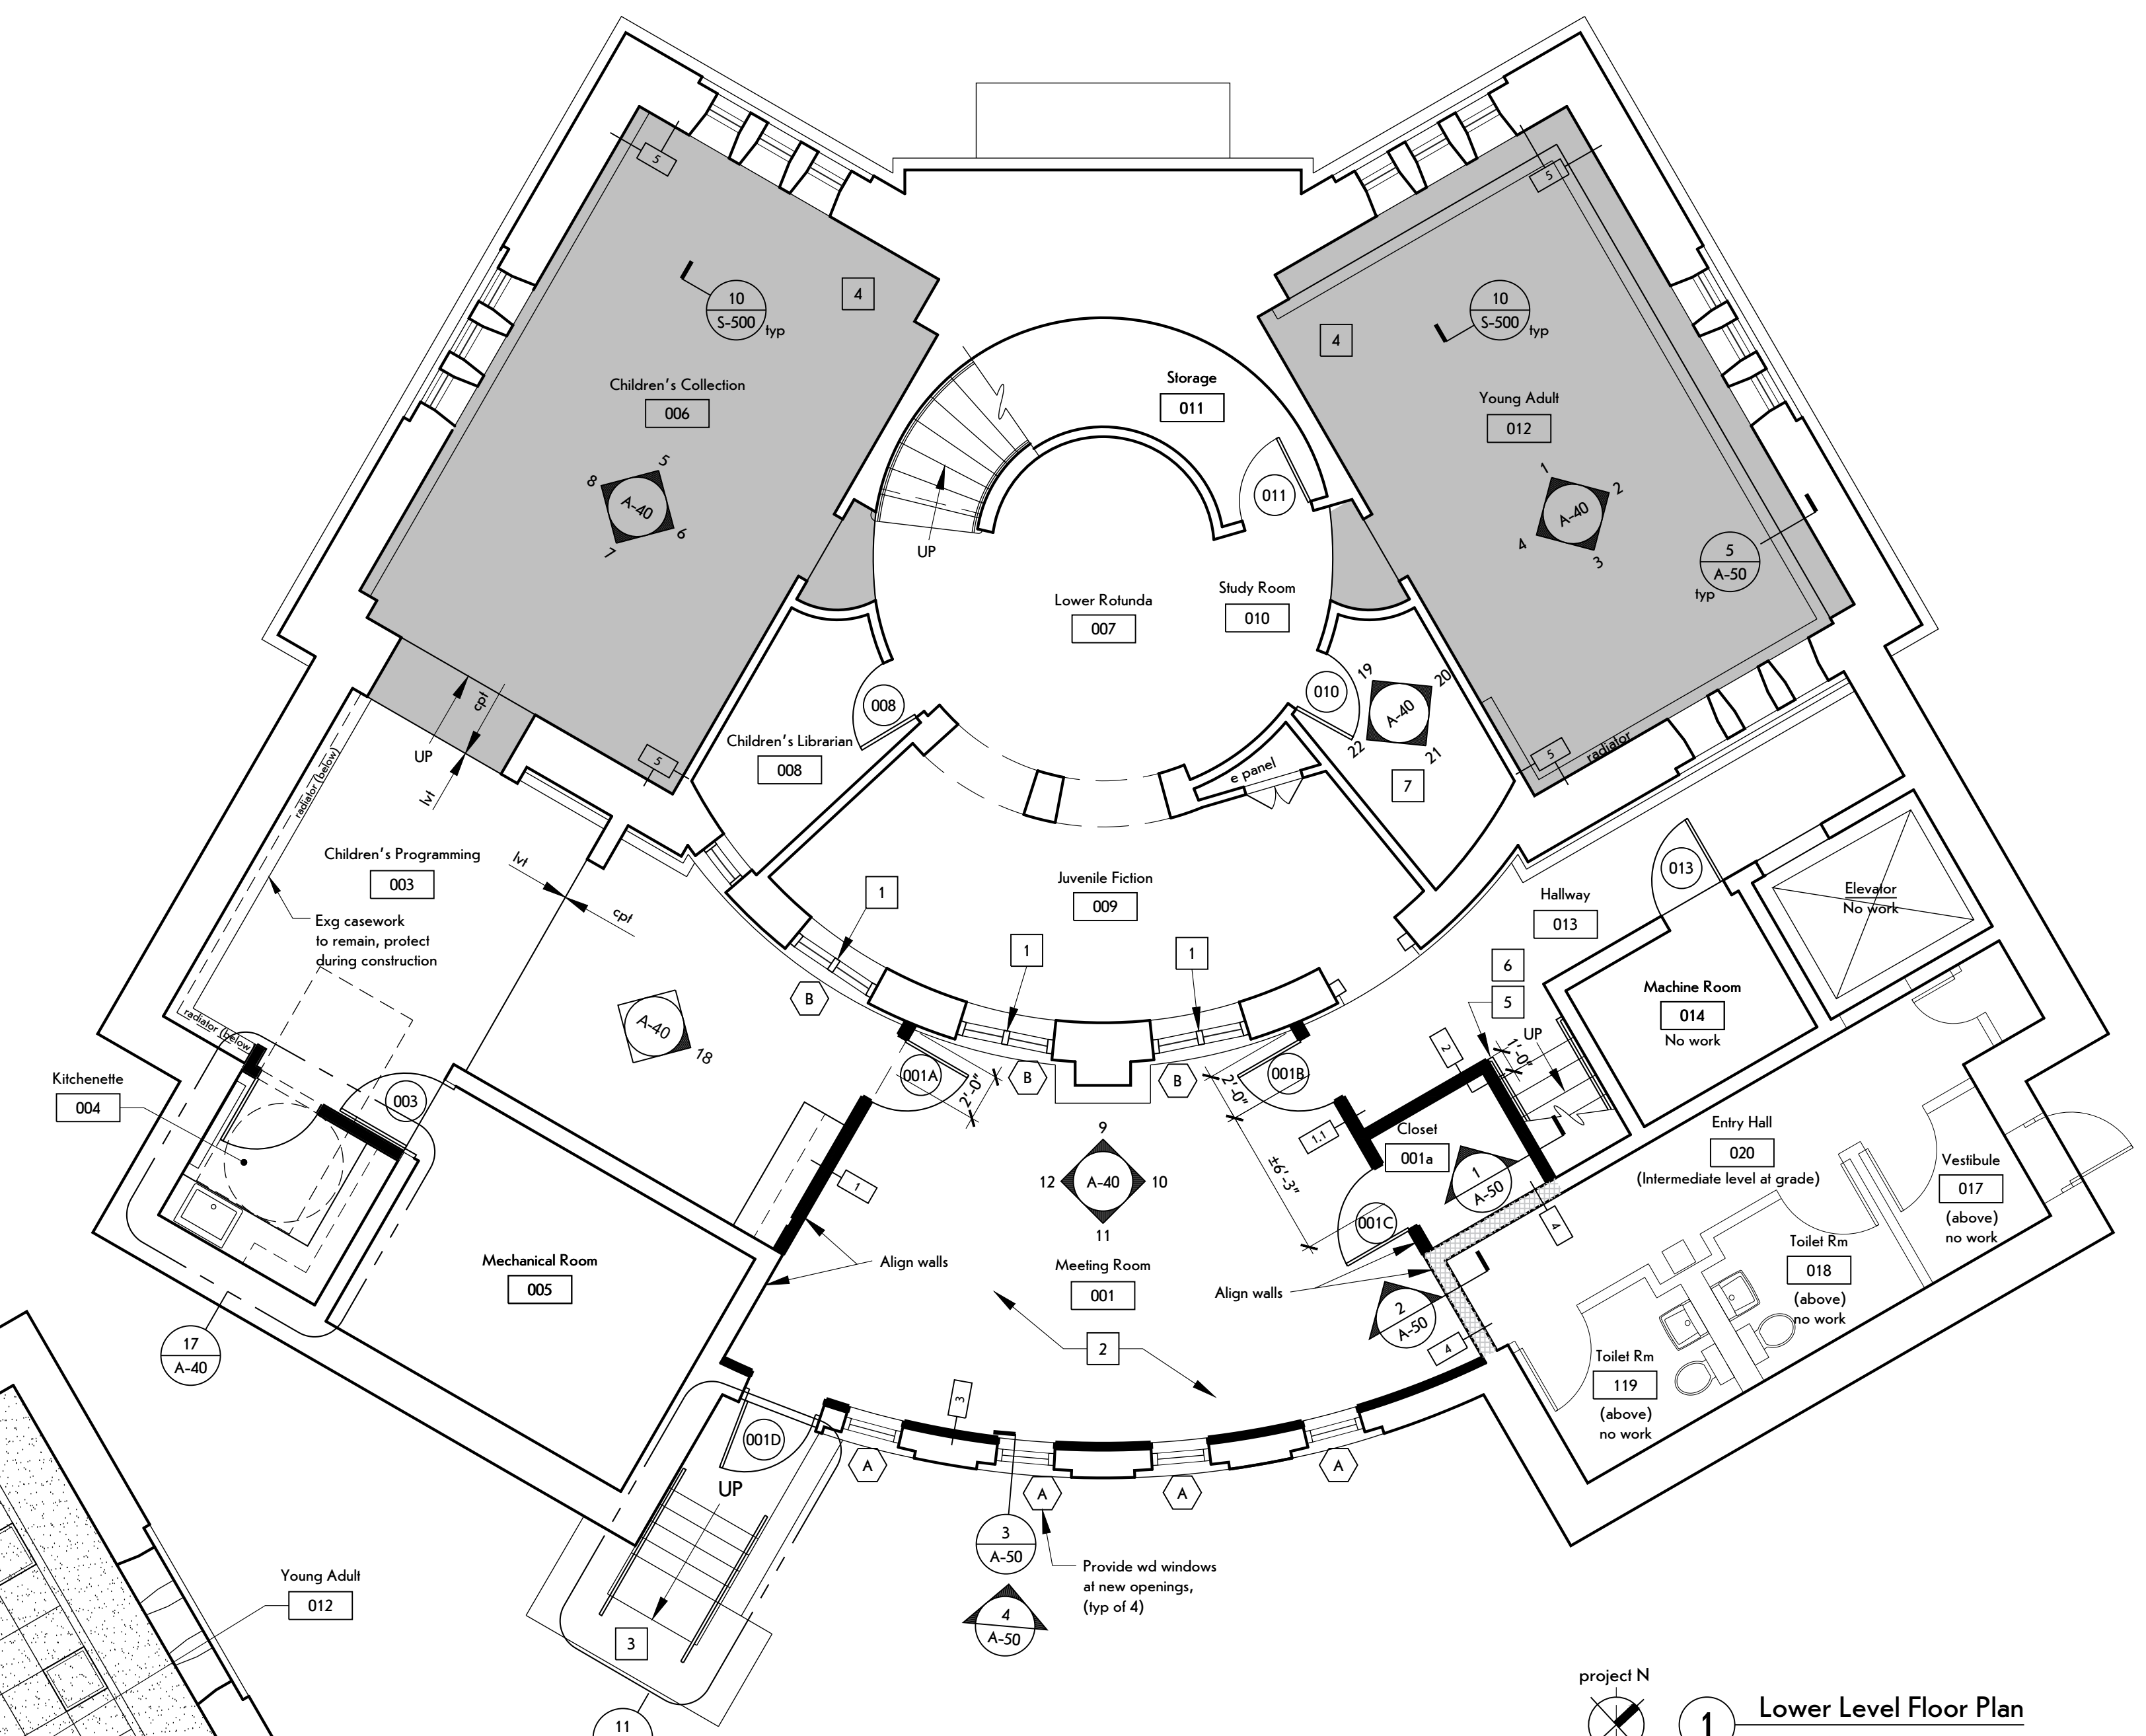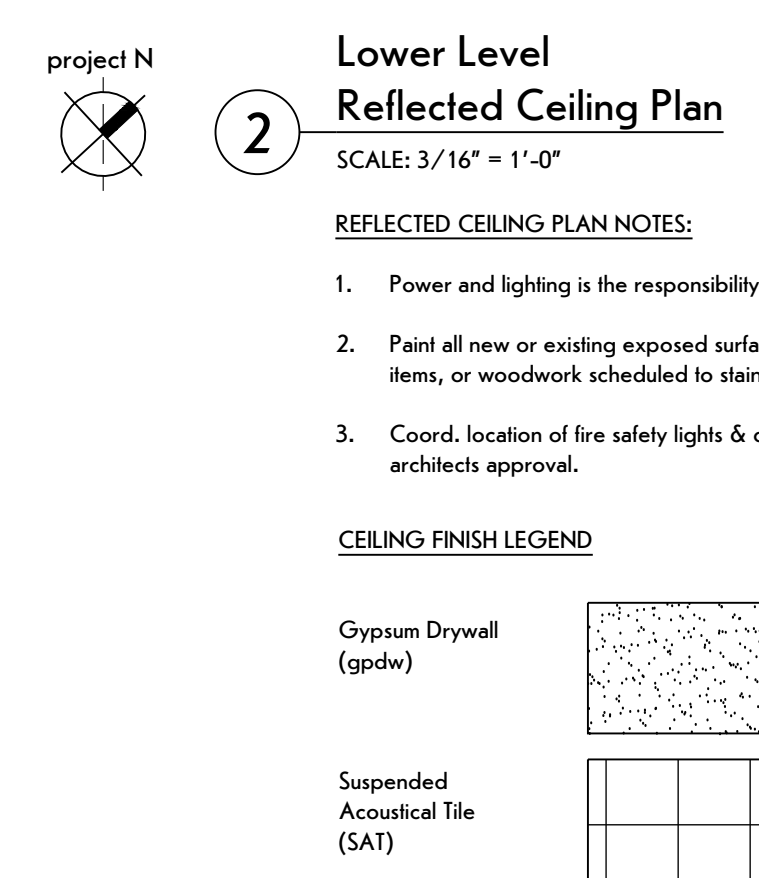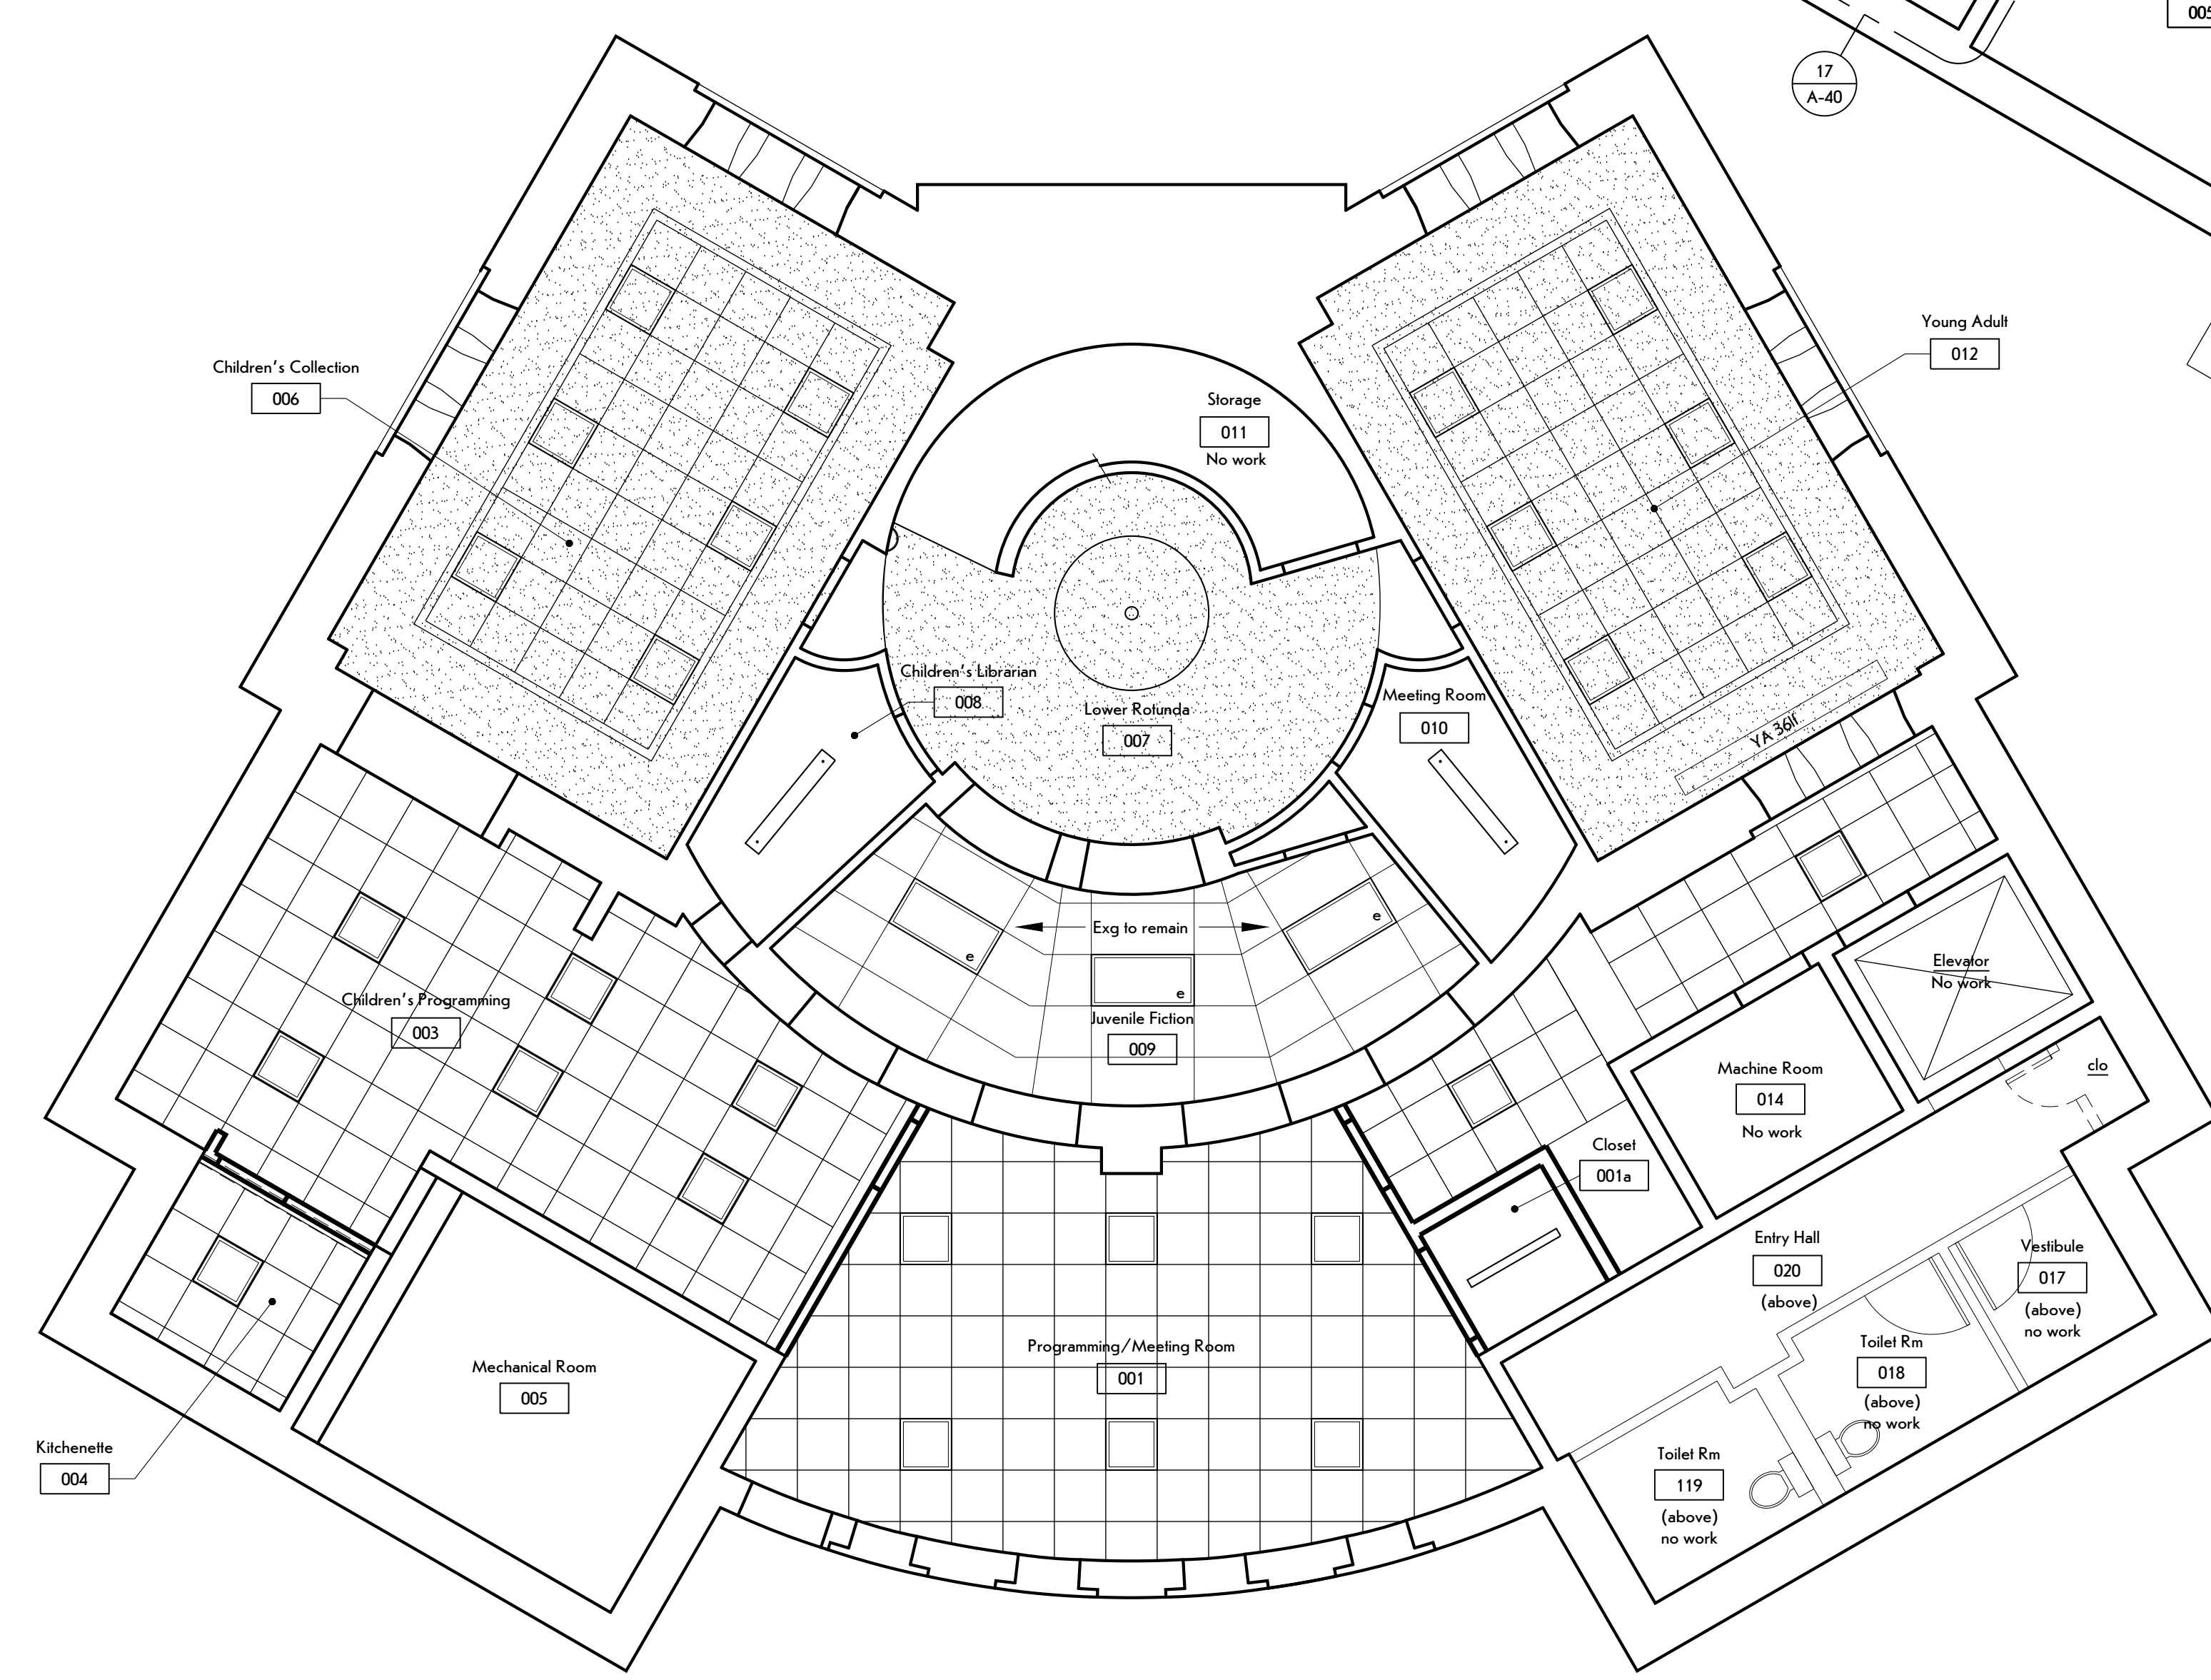

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REVISIONS:

#	Date	Description

CLIENT / OWNER:

Town of Warsaw
83 Center Street
Warsaw, NY 14569

PROJECT INFORMATION:
Expansion and Renovation
Warsaw Public Library
130 North Main Street, Warsaw, New York
PROJECT NUMBER: 22121
ISSUE DATE: February 25, 2025
DRAWN BY: LMY



SHEET TITLE:
Lower Level Floor Plan & Reflected Ceiling Plan
SHEET NUMBER:
A-10

ROOM FINISH SCHEDULE											
NO.	ROOM NAME	FLOORING				WALLS		CEILING			NOTES
		MAT'L	FC	MAT'L	FC	MAT'L	FC	MAT'L	FC	HGHT.	
101	Circulation	cpl	-	rbr	-	e.gpdw	pnt	e.structure	-	-	-
102	Office	cpl	-	rbr	-	e.gpdw/gpdw	pnt	act	-	7'-11 1/2"	-
103	Media	cpl	-	rbr	-	e.gpdw	pnt	e.structure	-	-	-
104	Meeting Room	cpl	-	rbr	-	e.gpdw/gpdw	pnt	act	-	-	-
105	Non Fiction	cpl	-	rbr	-	e.tile	-	e.gpdw*	pnt	11'-10"	(1) (2)
106	Upper Rotunda	cpl	-	e.wd	pnt	e.gpdw	pnt	e.gpdw	pnt	13'-10 1/2"	(2) (3) (5)
107	Fiction	cpl	-	e.wd	pnt	e.gpdw	pnt	e.bdtd	-	6'-6 1/2"	(2)
108	Large Print	cpl	-	e.wd	pnt	e.gpdw	pnt	e.bdtd	-	6'-6 1/2"	(2)
109	Fiction	cpl	-	rbr	-	e.gpdw*	pnt	e.tile	-	11'-10"	(1) (2)
110	Vestibule	wd	ref	wd	pnt	e.plas	pnt	e.plas	pnt	-	*Prov jt compound & fin @ exg gpdw "v" jts.
111	Hallway	cpl	-	rbr	-	e.gpdw	pnt	-	-	-	(4) (6)
112	Upper Landing	cpl	-	rbr	-	e.gpdw	pnt	-	-	-	(4)


- GENERAL NOTES**
1. Repair & refinish disturbed areas.
 2. Paint all exg & new exposed elements in areas receiving work including, but not limited to walls, ceilings, utilities, ducts, conduit.
- NOTES**
1. Provide jt compound & fin @ exg gpdw "v" jts.
 2. Patch gpdw at vert wd removals.
 3. Remove abandoned ceiling ac outlets and patch.
 4. Provide rubber stair treads at exg stair.
 5. Remove wallpaper and prep walls for paint.
 6. Paint exg and new handrails.

FINISH KEY:

act	Acoustical tile ceiling
bdbd	Beadboard
cpl	Carpet
cmu	Concrete masonry unit
e	Existing
gpdw	Gypsum drywall
lvt	Luxury vinyl tile
plas	Plaster
pnt	Paint
pol	Polished (concrete)
ref	Refinish
rbr	Rubber
stn	Stain and Clear Finish
vct	Vinyl Composite Tile
wd	Wood

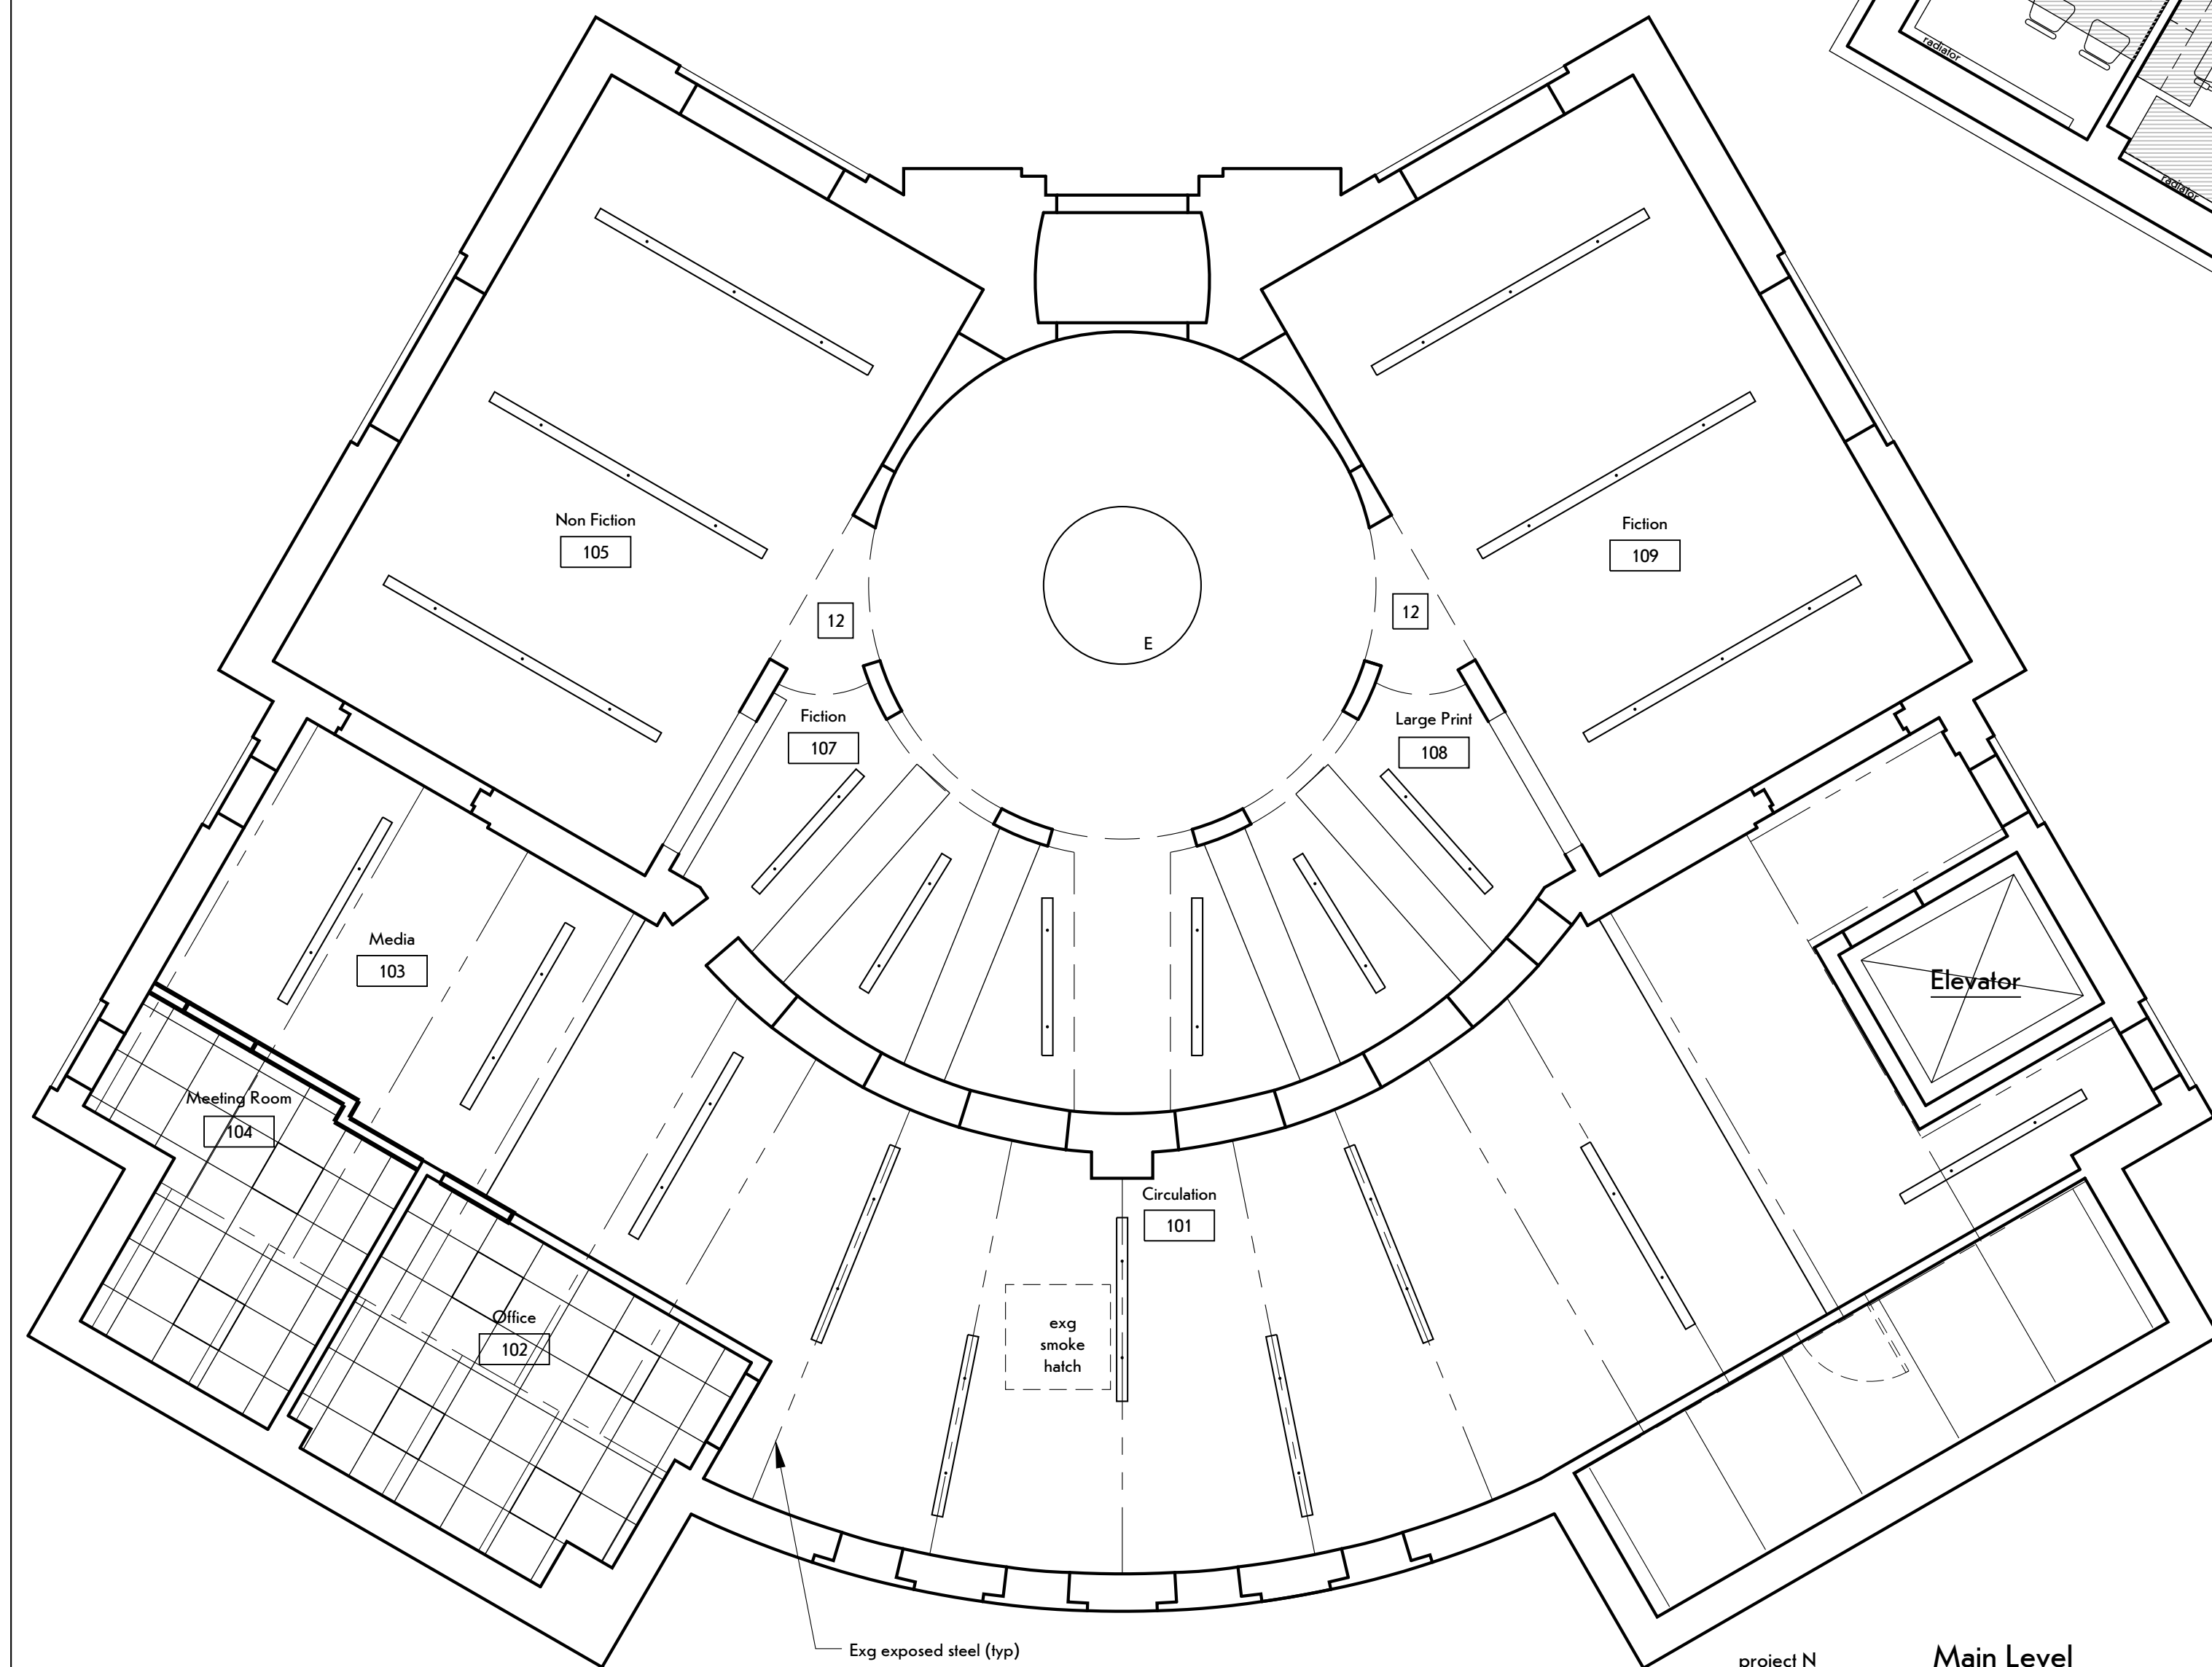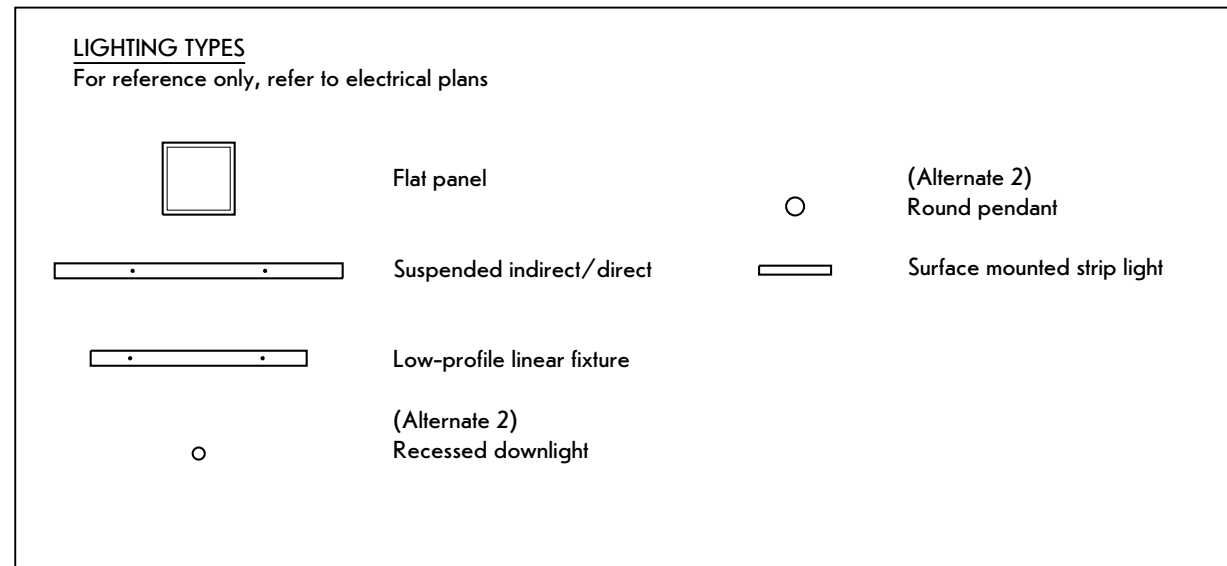


2 Main Level Reflected Ceiling Plan
SCALE: 3/16" = 1'-0"

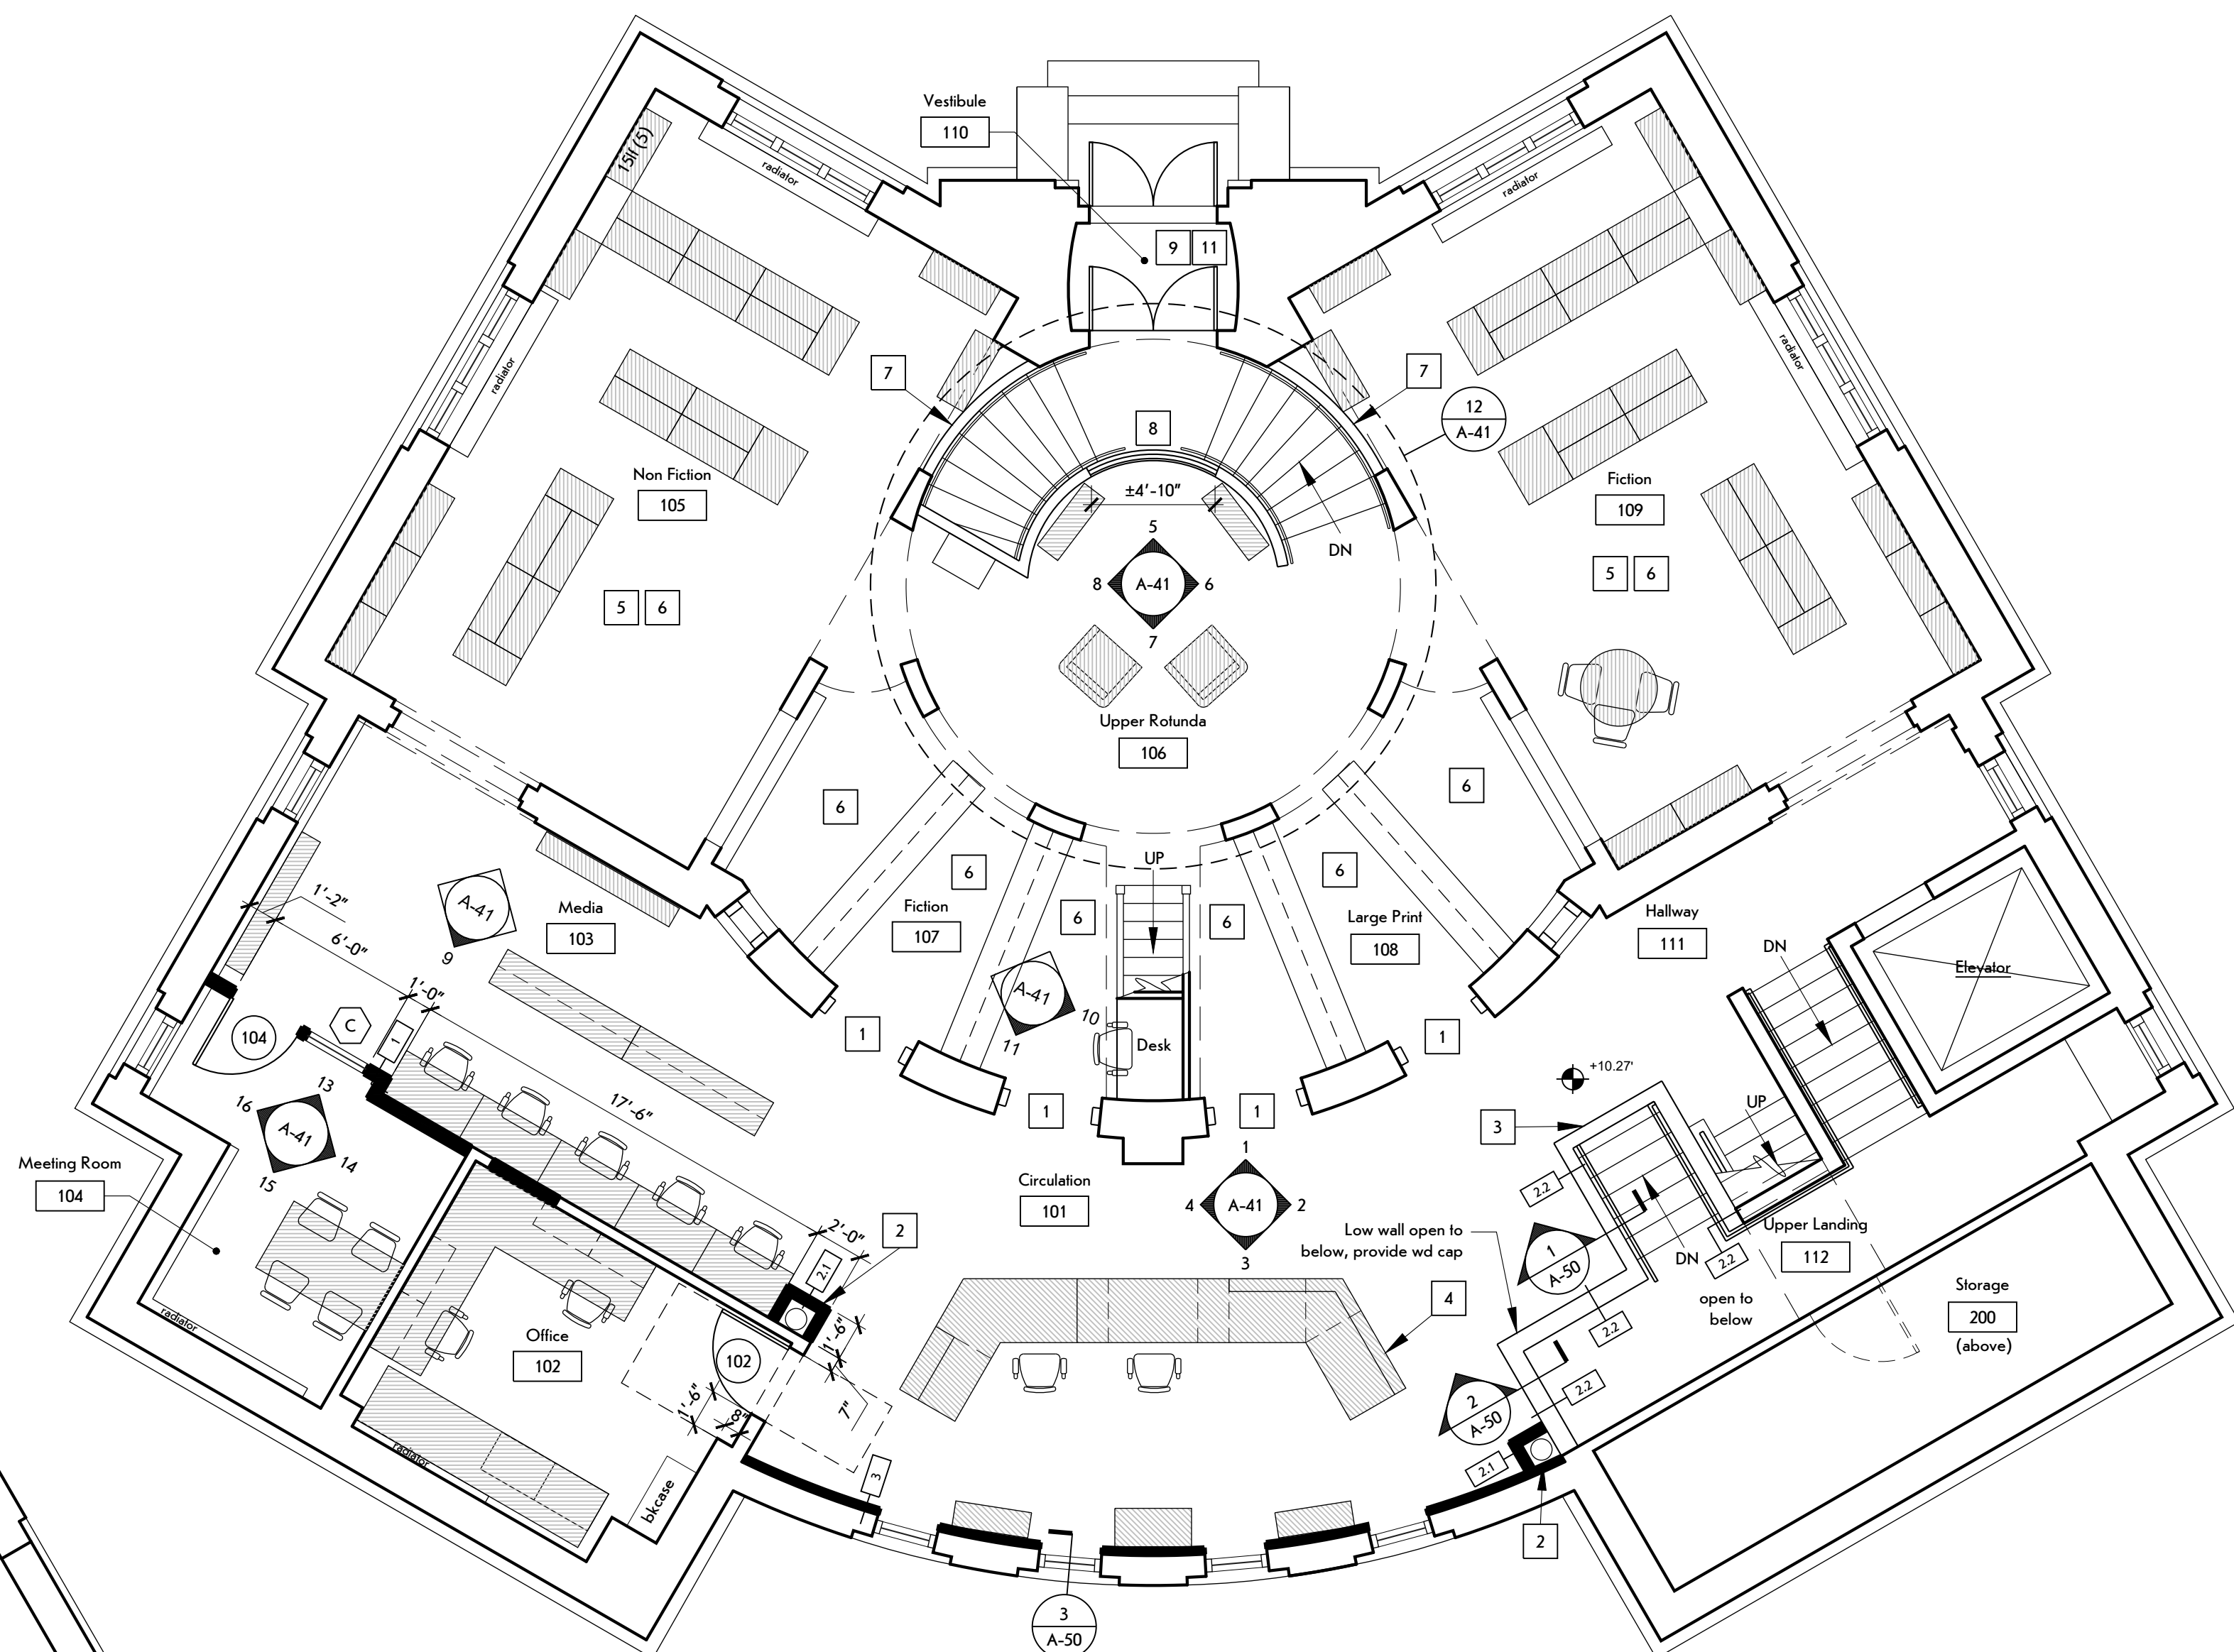


- FLOOR PLAN AND RCP WORK NOTES:**
1. Portion of original windows to be removed to provide access to stacks. Refer to 1/A-41.
 2. GC provide openings in conc slab for ductwork penetrations.
 3. Provide low wall, refer to 1 & 2/A-50.
 4. Circulation desk is by Others, coordinate power with Owner's separate contractor.
 5. Provide joint compound and finish at existing gpdw "v" joints, rooms 105 and 109.
 6. Fill holes and repair walls to smooth at rooms 105, 106, 107, 108, and 109.
 7. Provide trim at all of rotunda interior openings, refer to 5/A-40.
 8. Open low wall to expose wood guardrail, reconfigure guardrail, repair, and refinish. Refer to 5/A-41.
 9. Refinish exg wood at Upper Rotunda 106 stair and Vestibule 110.
 10. Alternate No. 2: Provide acoustical, hung panel ceiling. Coord. installation location with Architect.
 11. Alternate No. 4: GC to provide openings of each side of Vestibule 110 for installation of ductwork. GC responsible for patching and finishing.
 12. Sand prep and paint exg clg, at these location.
 13. Provide glazing at exg (interior) windows.

CEILING FINISH LEGEND

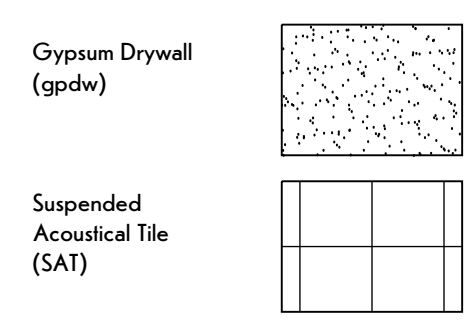


REFLECTED CEILING PLAN - GENERAL NOTES:

1. Power and lighting is the responsibility of the Electrical Contractor.
2. Paint all new or existing exposed surfaces except SAT, prefinished items, or woodwork scheduled to stained.
3. Coord. location of fire safety lights & devices - locate only after architects approval.

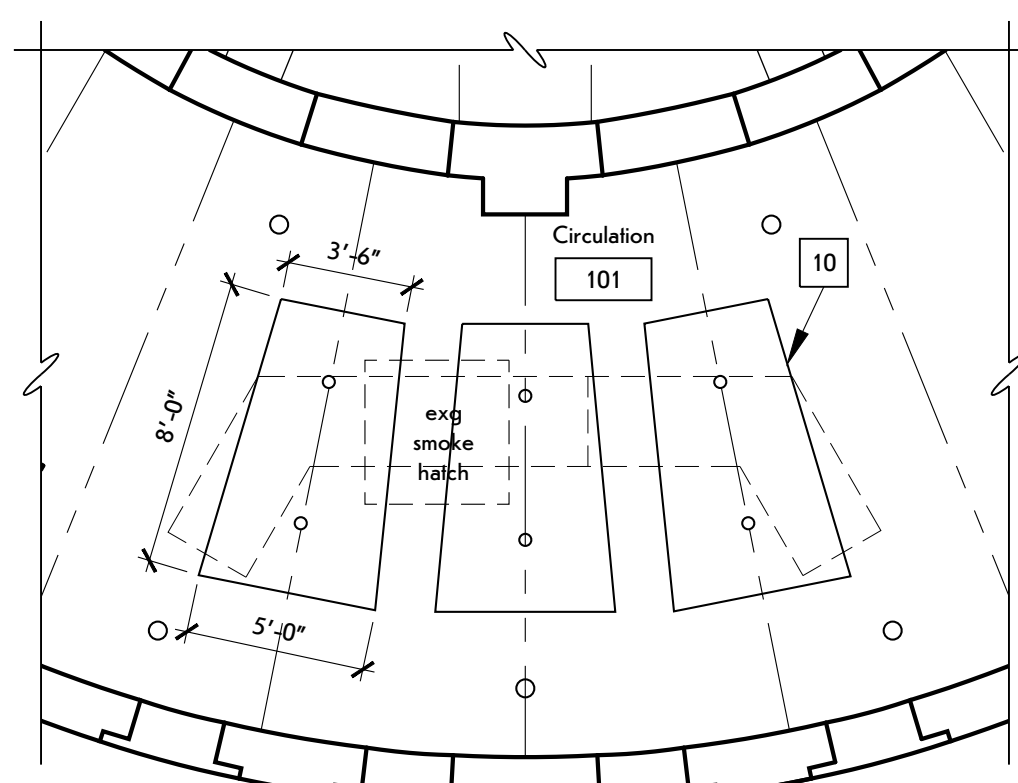


3 Alternate No. 2: Partial Main Level RCP
SCALE: 3/16" = 1'-0"

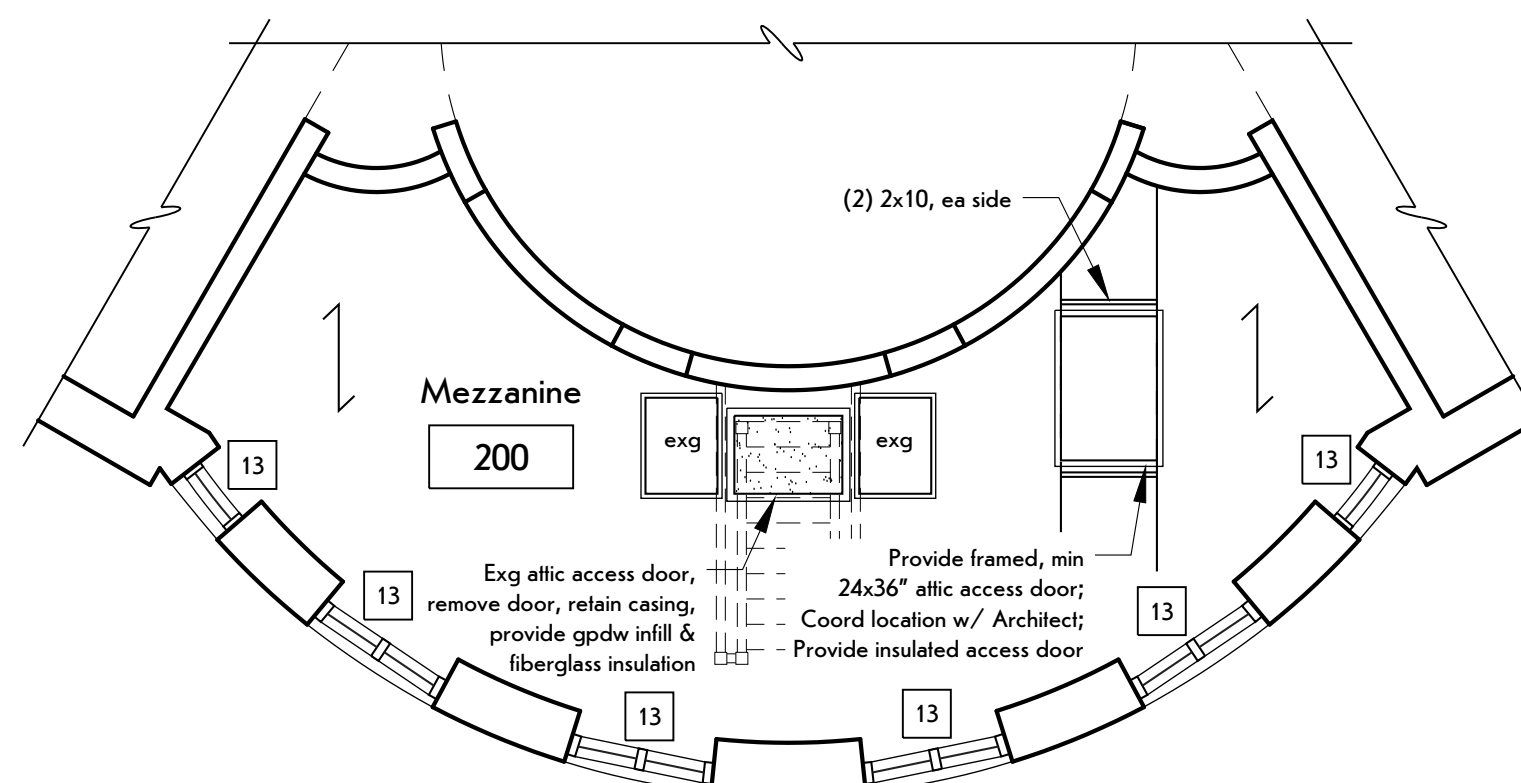

4 Alternate No. 5 Mezzanine Reflected Ceiling Plan
SCALE: 3/16" = 1'-0"

1 Main Level Floor Plan
SCALE: 3/16" = 1'-0"

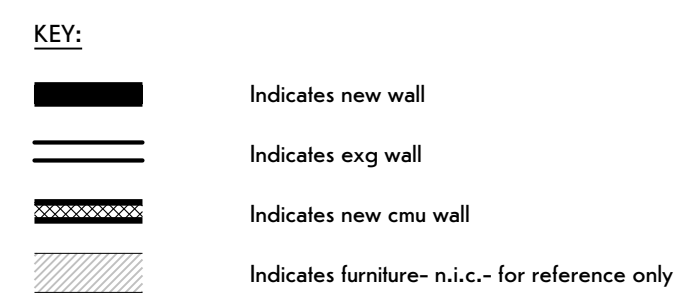

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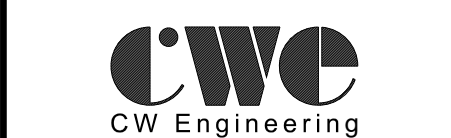
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Expansion and Renovation
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130 North Main Street, Warsaw, New York

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ISSUE DATE: February 25, 2025

DRAWN BY: LMY

SHEET TITLE:

Main Level Floor Plan & Reflected Ceiling Plan

SHEET NUMBER:

A-11

General Wood Casework Notes:

All finish products are to be installed in accordance with contract specifications and manufacturer's instructions. Refer to specifications and details for additional information on installation of specified materials.

1. All countertops to be 1" solid surface.
2. Provide 4" high backsplashes and side at all locations, U.N.O.
3. Provide cabinets with finished sides, including but not limited to, locations of adjacent cabinets or equipment with a depth less than cabinet or equipment.
4. Provide sealant at all countertop sink cutout locations, refer to spec section 079200.
5. Provide cuts at all conditions that interfere with countertops/cabinets: scribe to fit.
6. Provide as noted on drawings and details: 2" grommets at open base counters.
7. Provide blocking at new and existing gypsum board walls per manufacturer recommendations for support of wall mounted units.
8. Provide countertop cut-outs for sinks and faucets, coordinate with all required contractors.
9. All sinks and accessories are as per specification.


Device Key:

- DR Duplex Receptacle
- QR Quad Receptacle

Note: Refer to MEP drawings to confirm type and quantity.

General Notes:

Repair and patch exg gpdw at any wall damaged during construction.

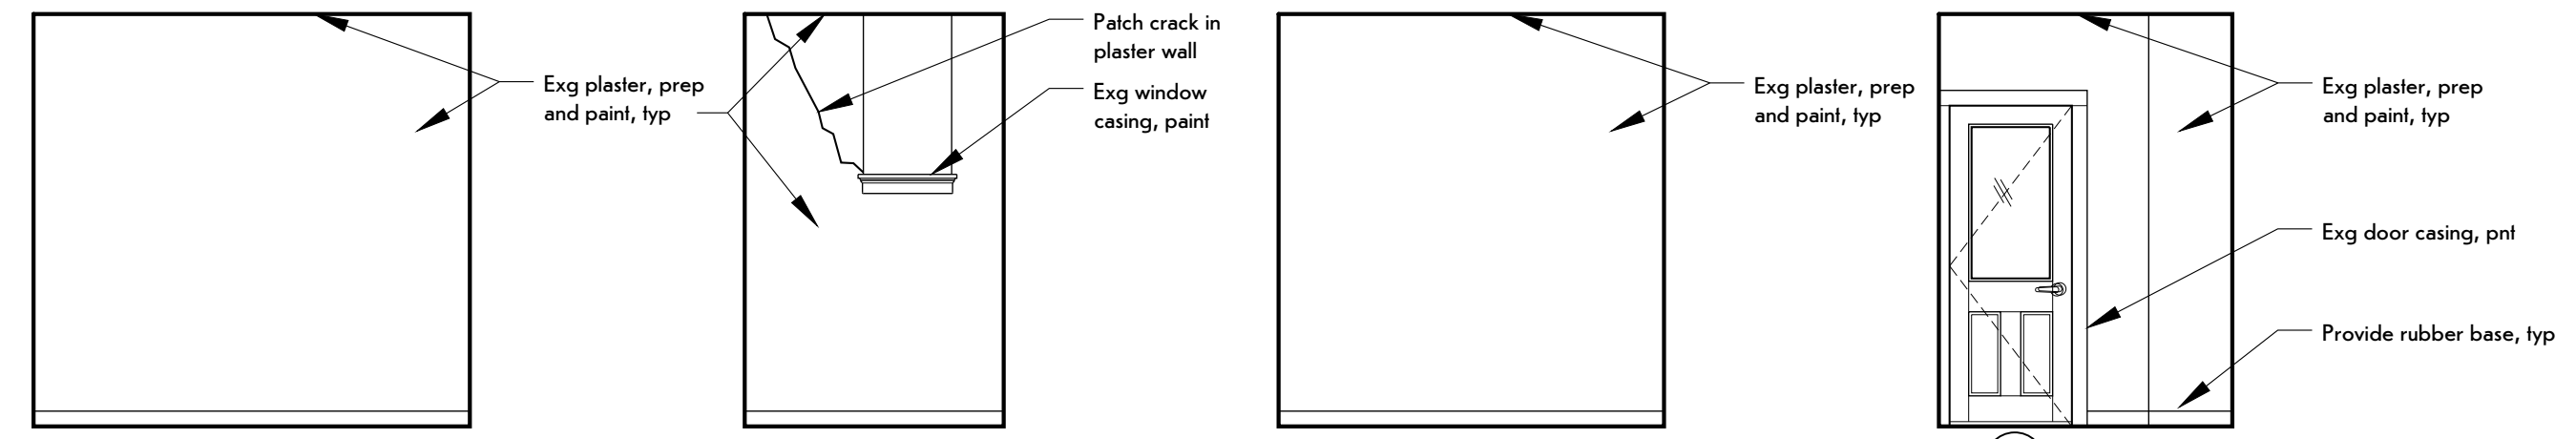


Meeting Room 010
West Elevation
SCALE: 1/4" = 1'-0"

Meeting Room 010
South Elevation
SCALE: 1/4" = 1'-0"


Meeting Room 010
East Elevation
SCALE: 1/4" = 1'-0"

Meeting Room 010
North Elevation
SCALE: 1/4" = 1'-0"

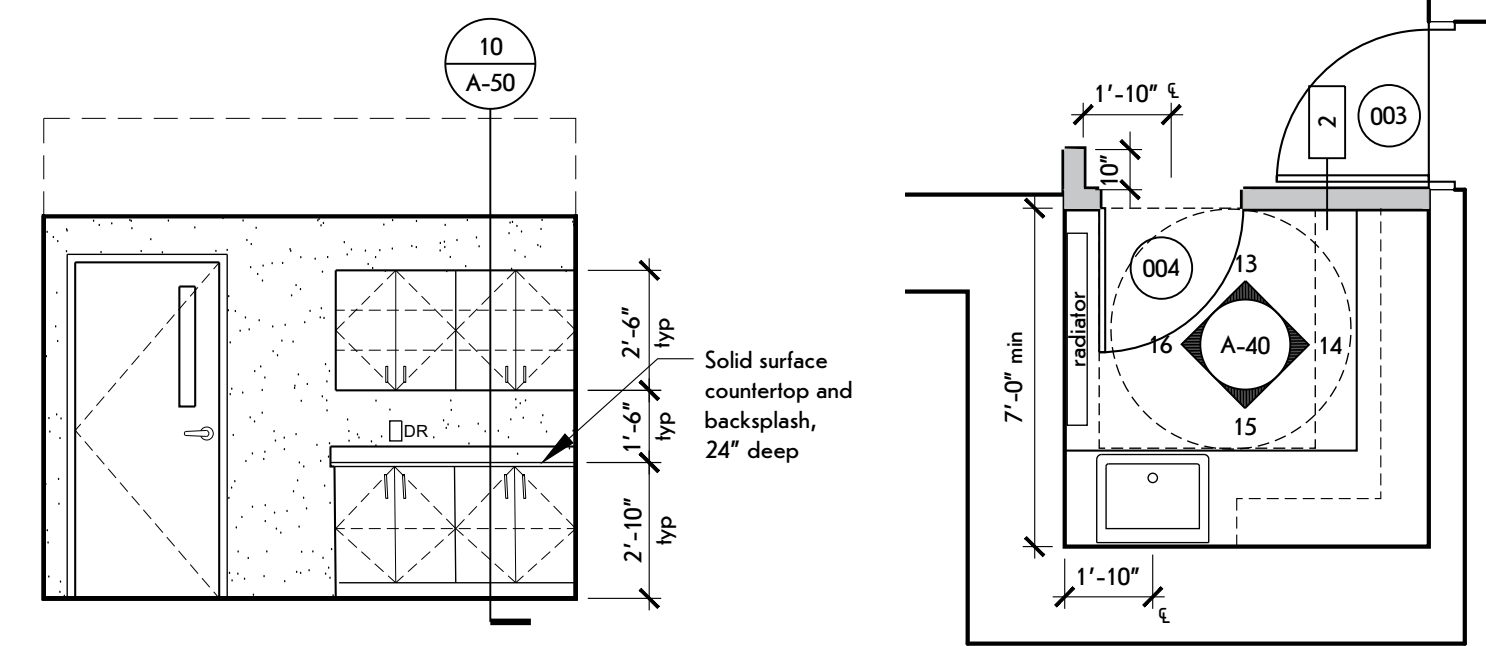


Childrens Programming 003
East Elevation
SCALE: 1/4" = 1'-0"


Kitchenette 004
Enlarged Floor Plan
SCALE: 1/4" = 1'-0"

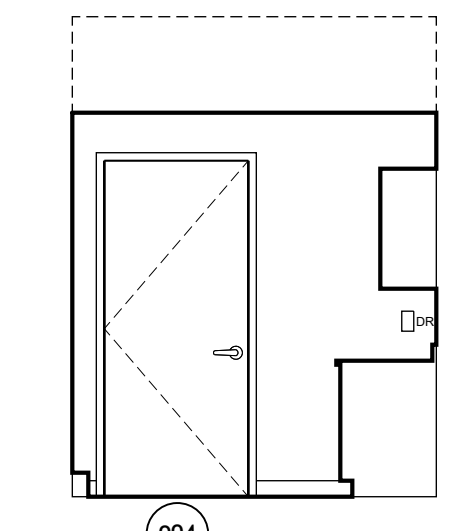


Kitchenette 004
East Elevation
SCALE: 1/4" = 1'-0"

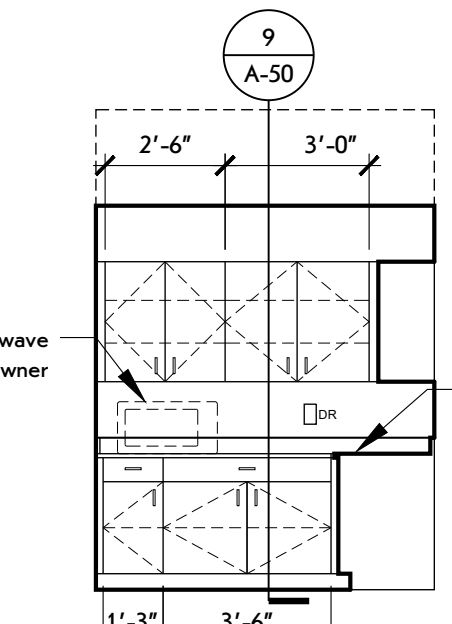


Kitchenette 004
South Elevation
SCALE: 1/4" = 1'-0"

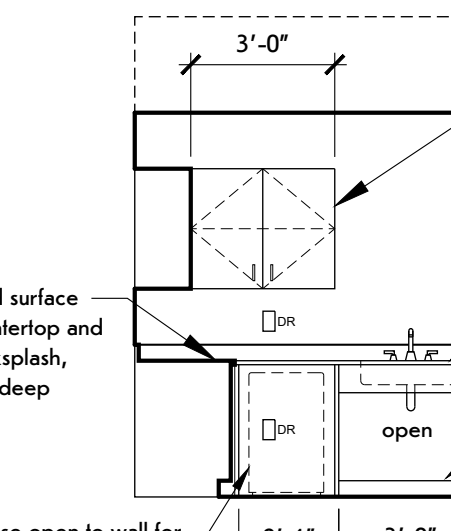


Kitchenette 004
West Elevation
SCALE: 1/4" = 1'-0"

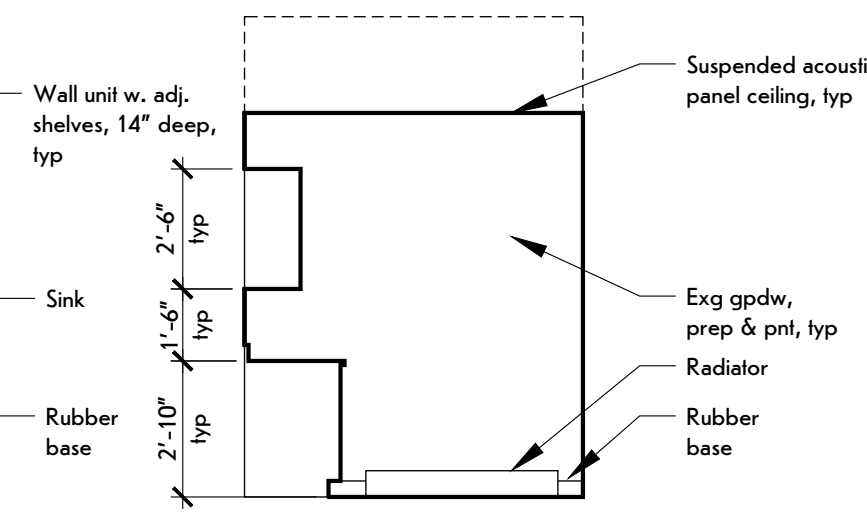


Kitchenette 004
North Elevation
SCALE: 1/4" = 1'-0"

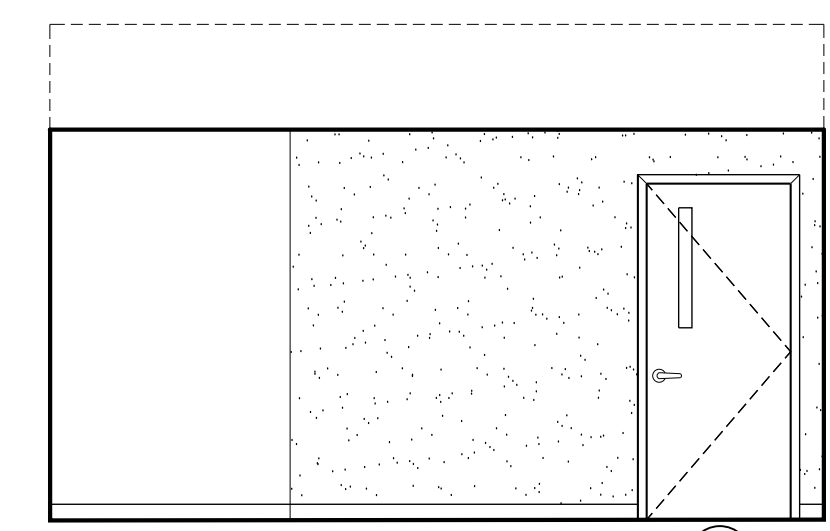


Meeting Room 001
West Elevation
SCALE: 1/4" = 1'-0"

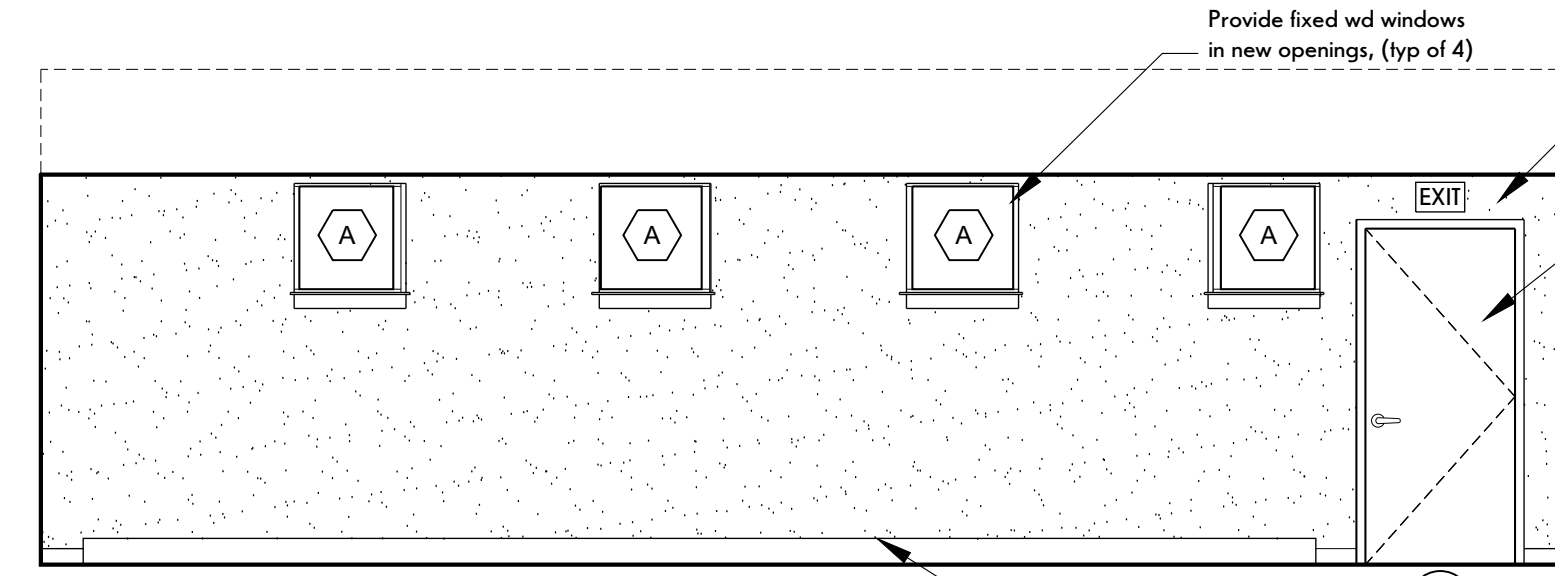

Programming/Meeting Room 001
South Elevation
SCALE: 1/4" = 1'-0"

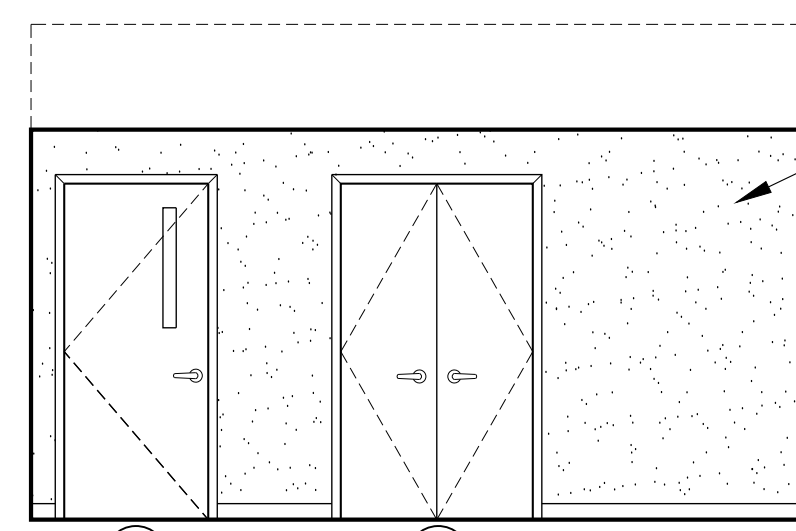


Meeting Room 001
East Elevation
SCALE: 1/4" = 1'-0"

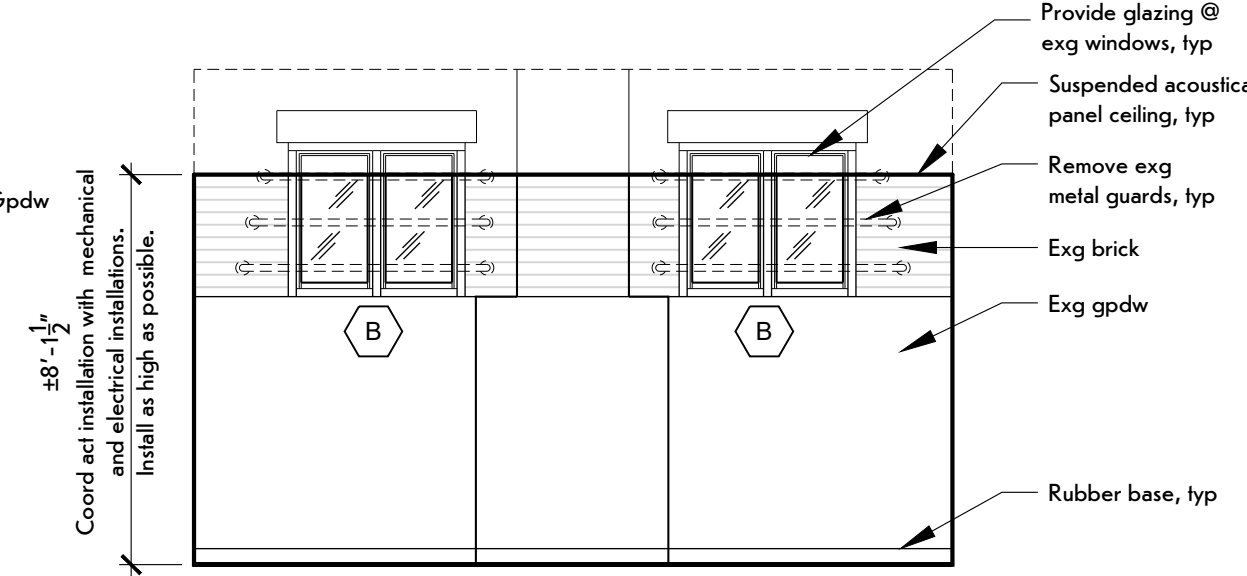


Meeting Room 001
North Elevation
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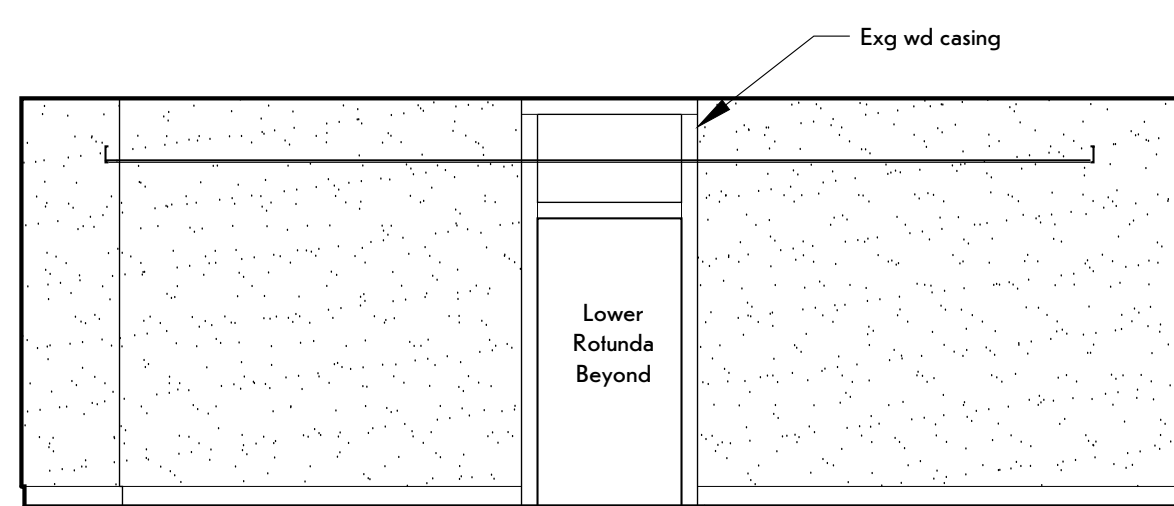
ALTERNATE NO. 1

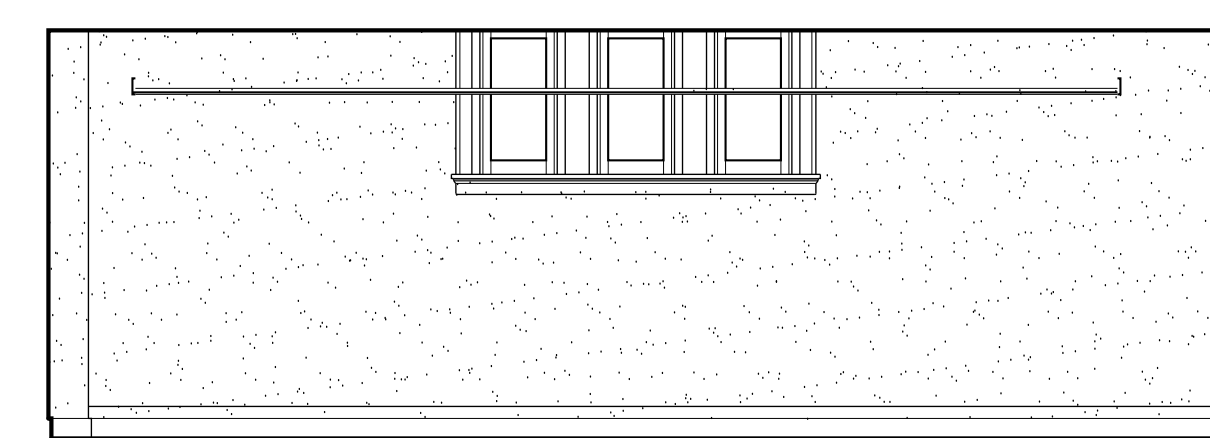


Children's Collection 006
West Elevation
SCALE: 1/4" = 1'-0"

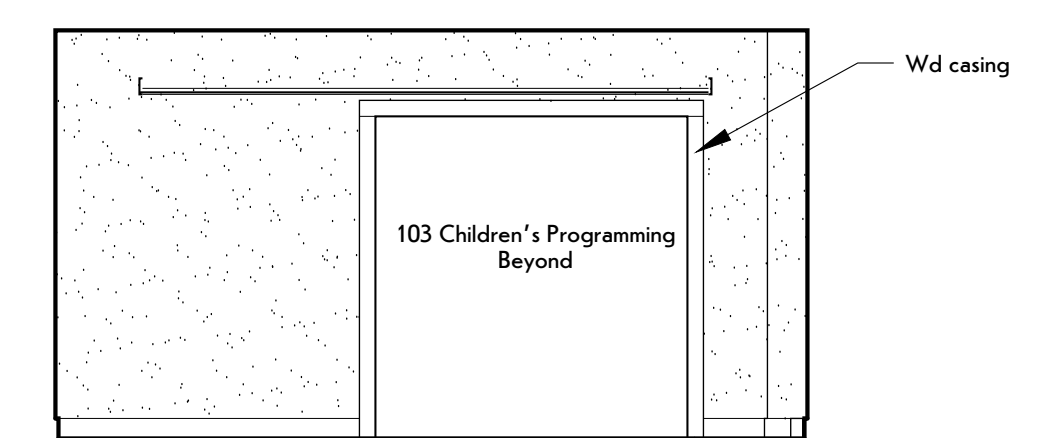


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South Elevation
SCALE: 1/4" = 1'-0"




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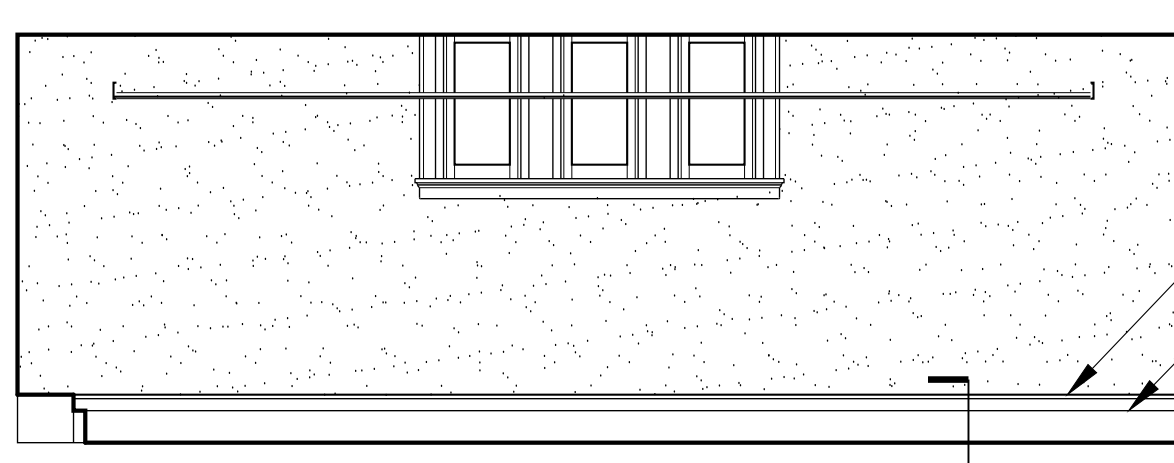
Children's Collection 006
North Elevation
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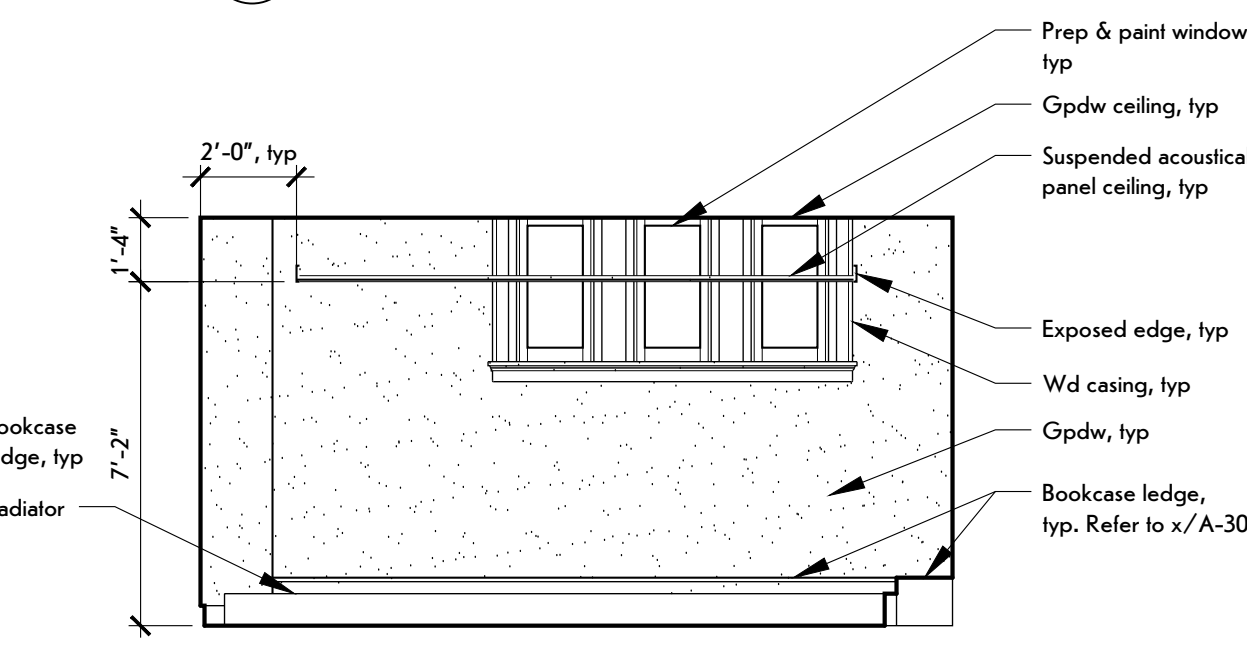
Young Adult 012
West Elevation
SCALE: 1/4" = 1'-0"

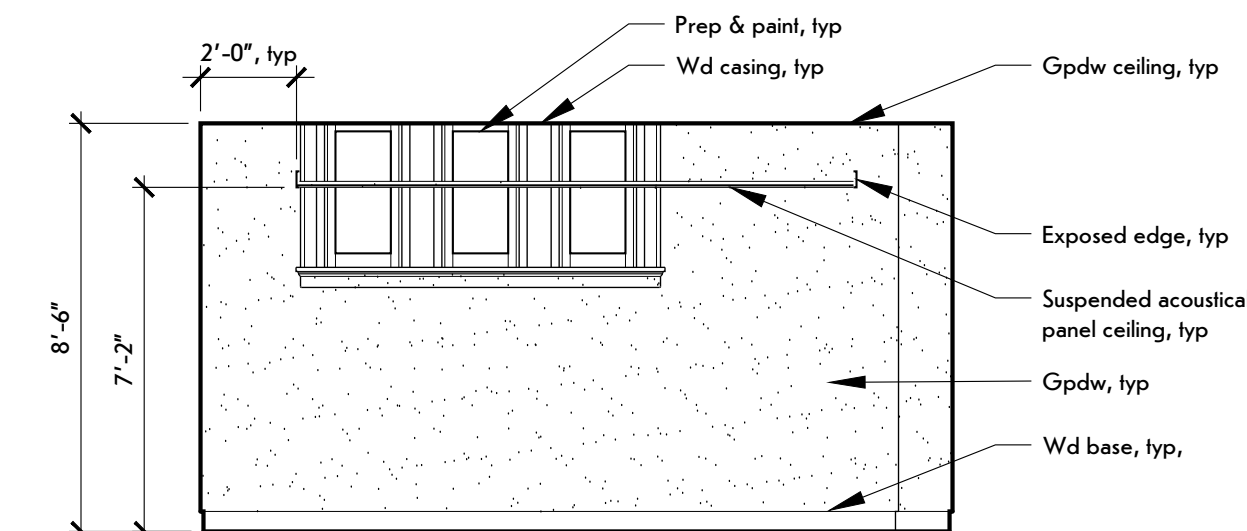

Young Adult 012
South Elevation
SCALE: 1/4" = 1'-0"

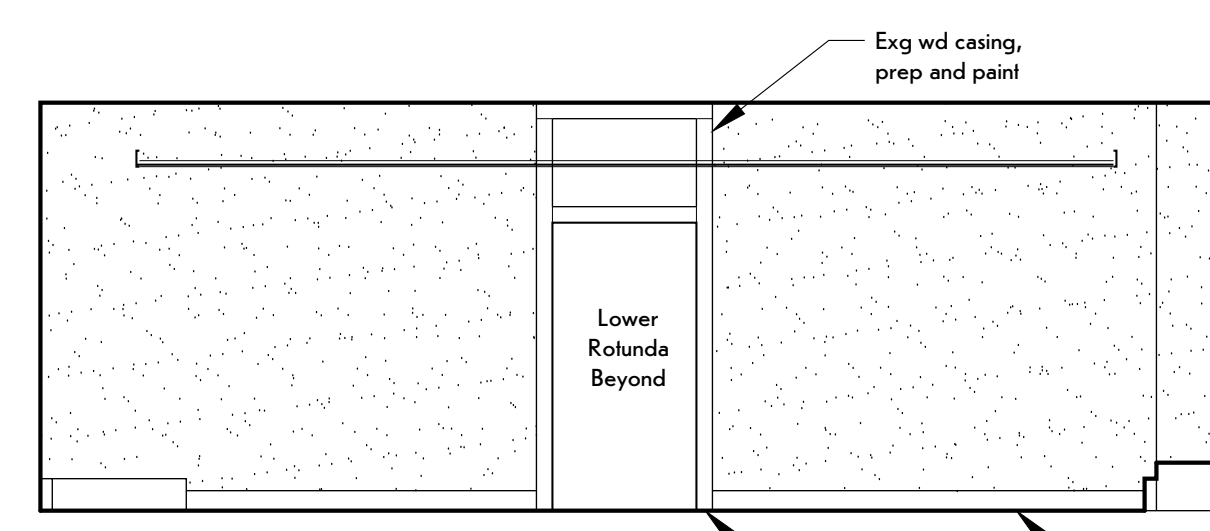

Young Adult 012
East Elevation
SCALE: 1/4" = 1'-0"

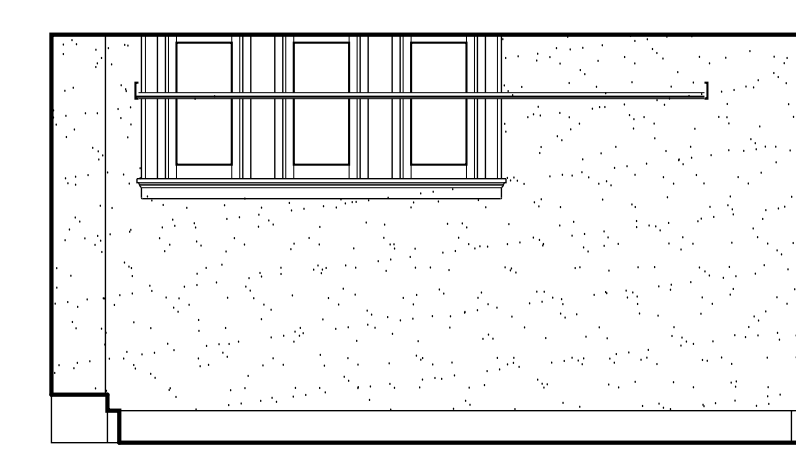

Young Adult 012
North Elevation
SCALE: 1/4" = 1'-0"



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SHEET TITLE:

**Lower Level
Interior Elevations**

SHEET NUMBER:

A-40



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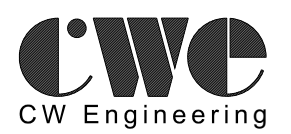
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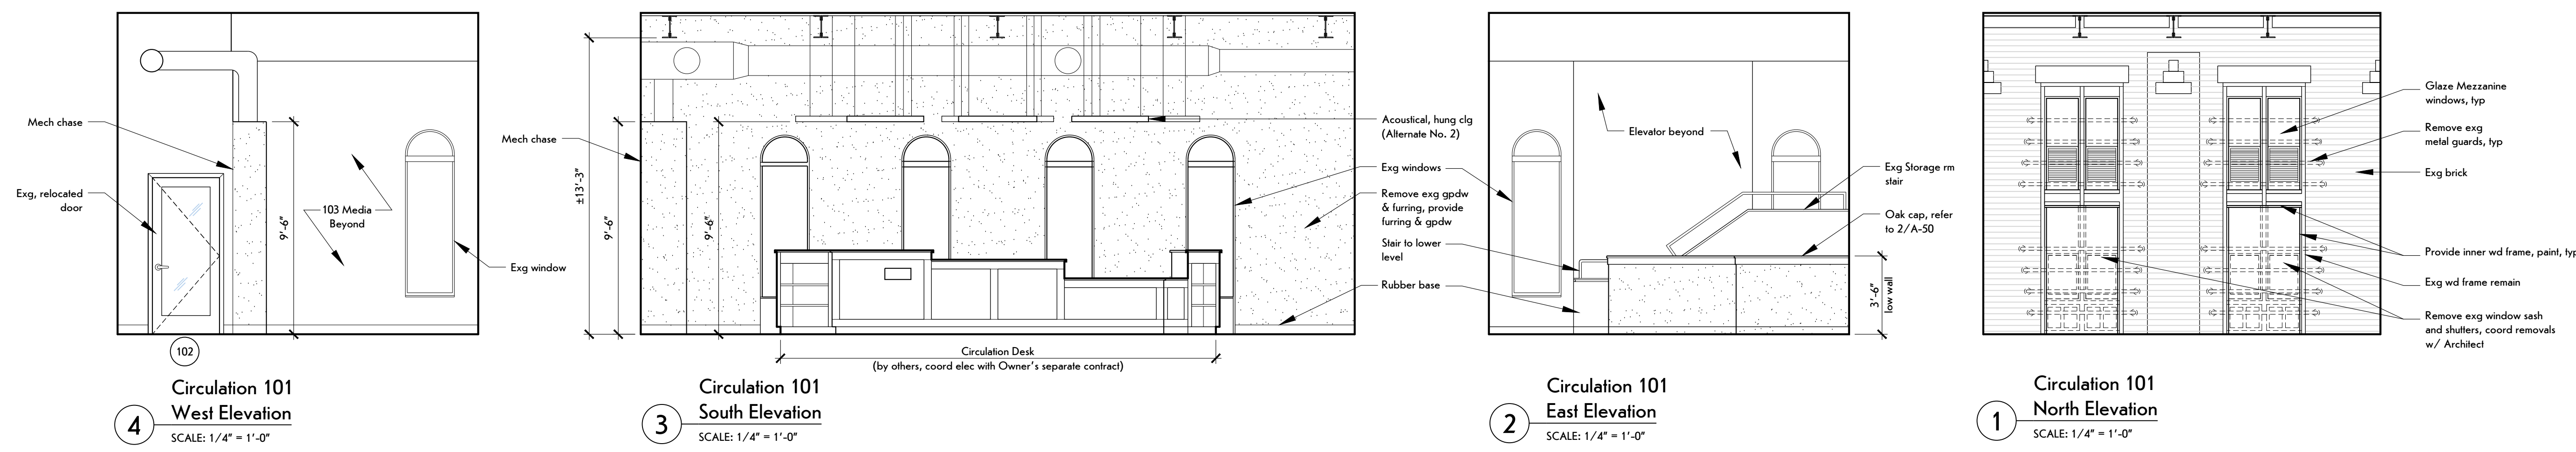
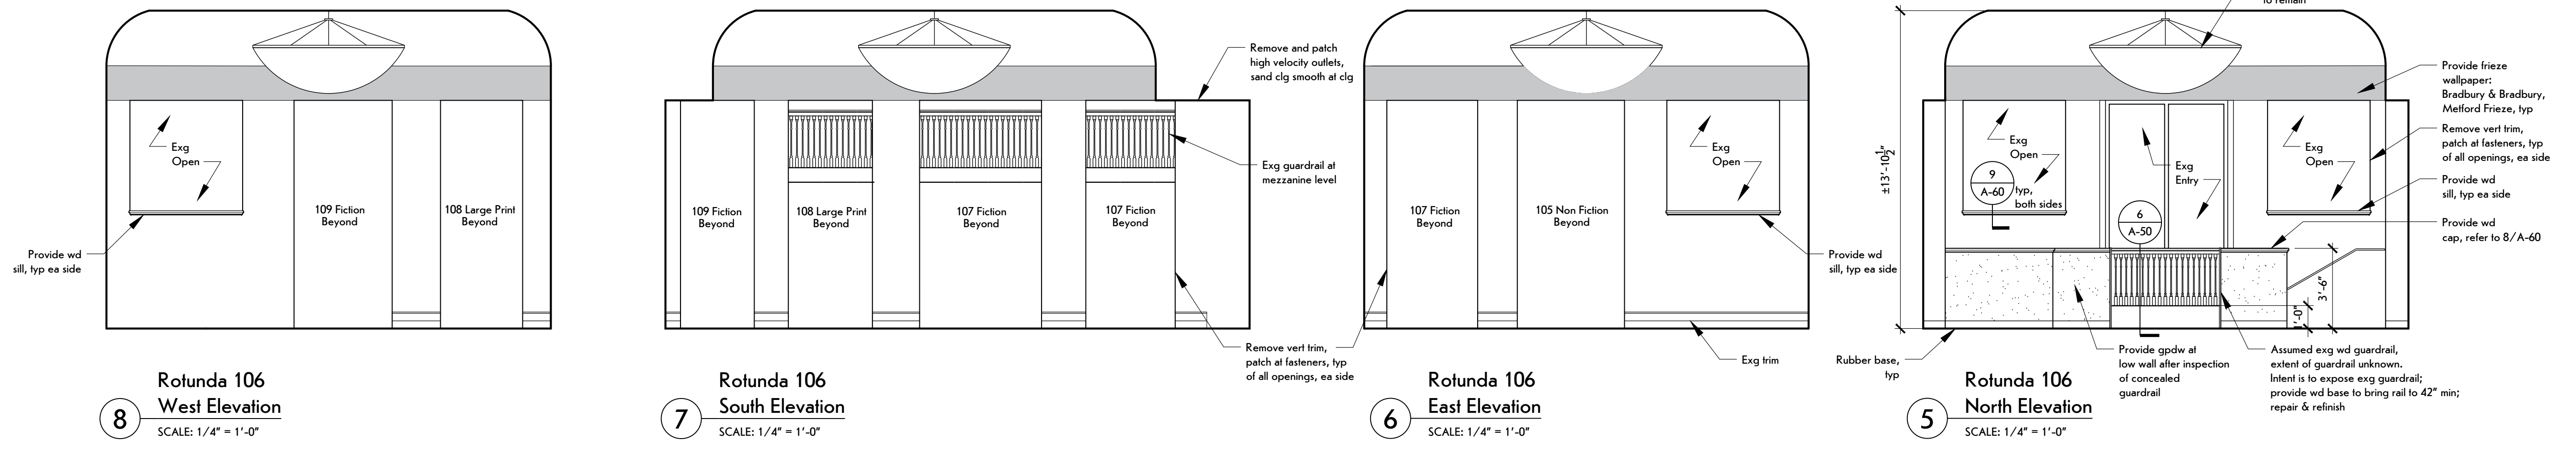
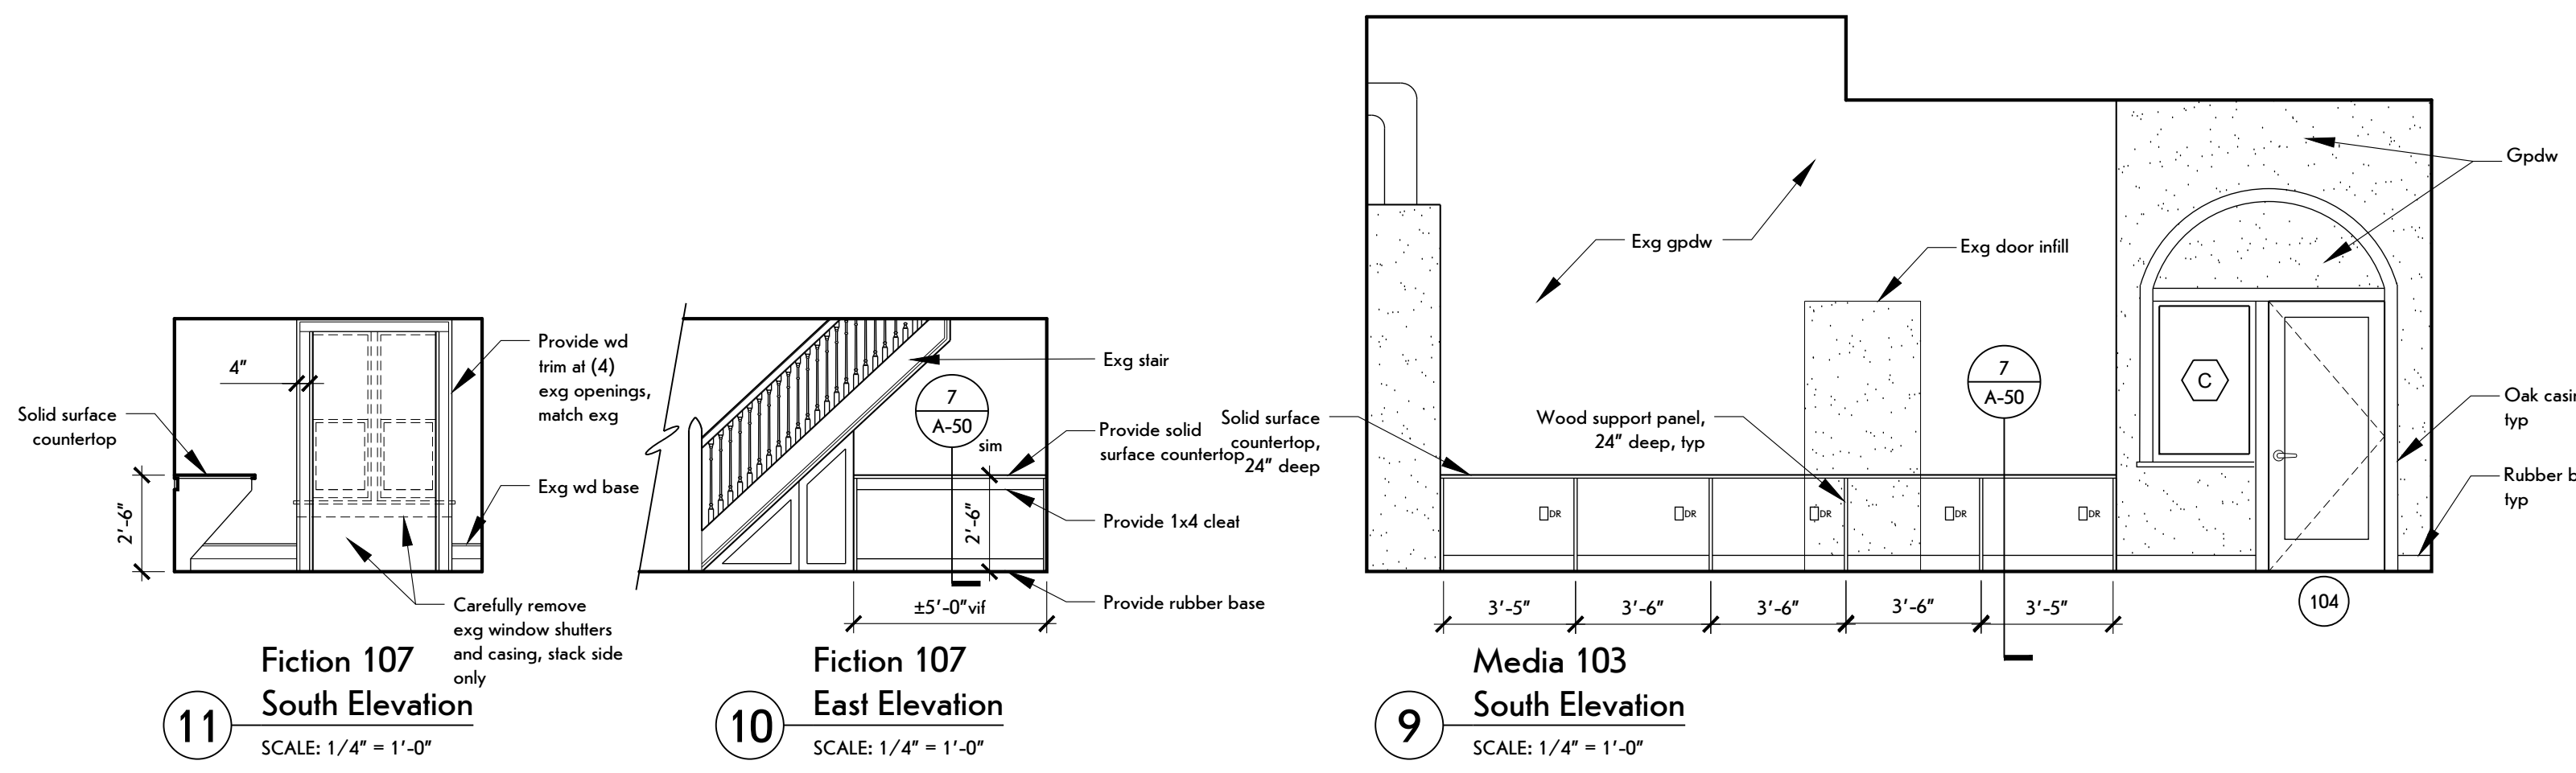
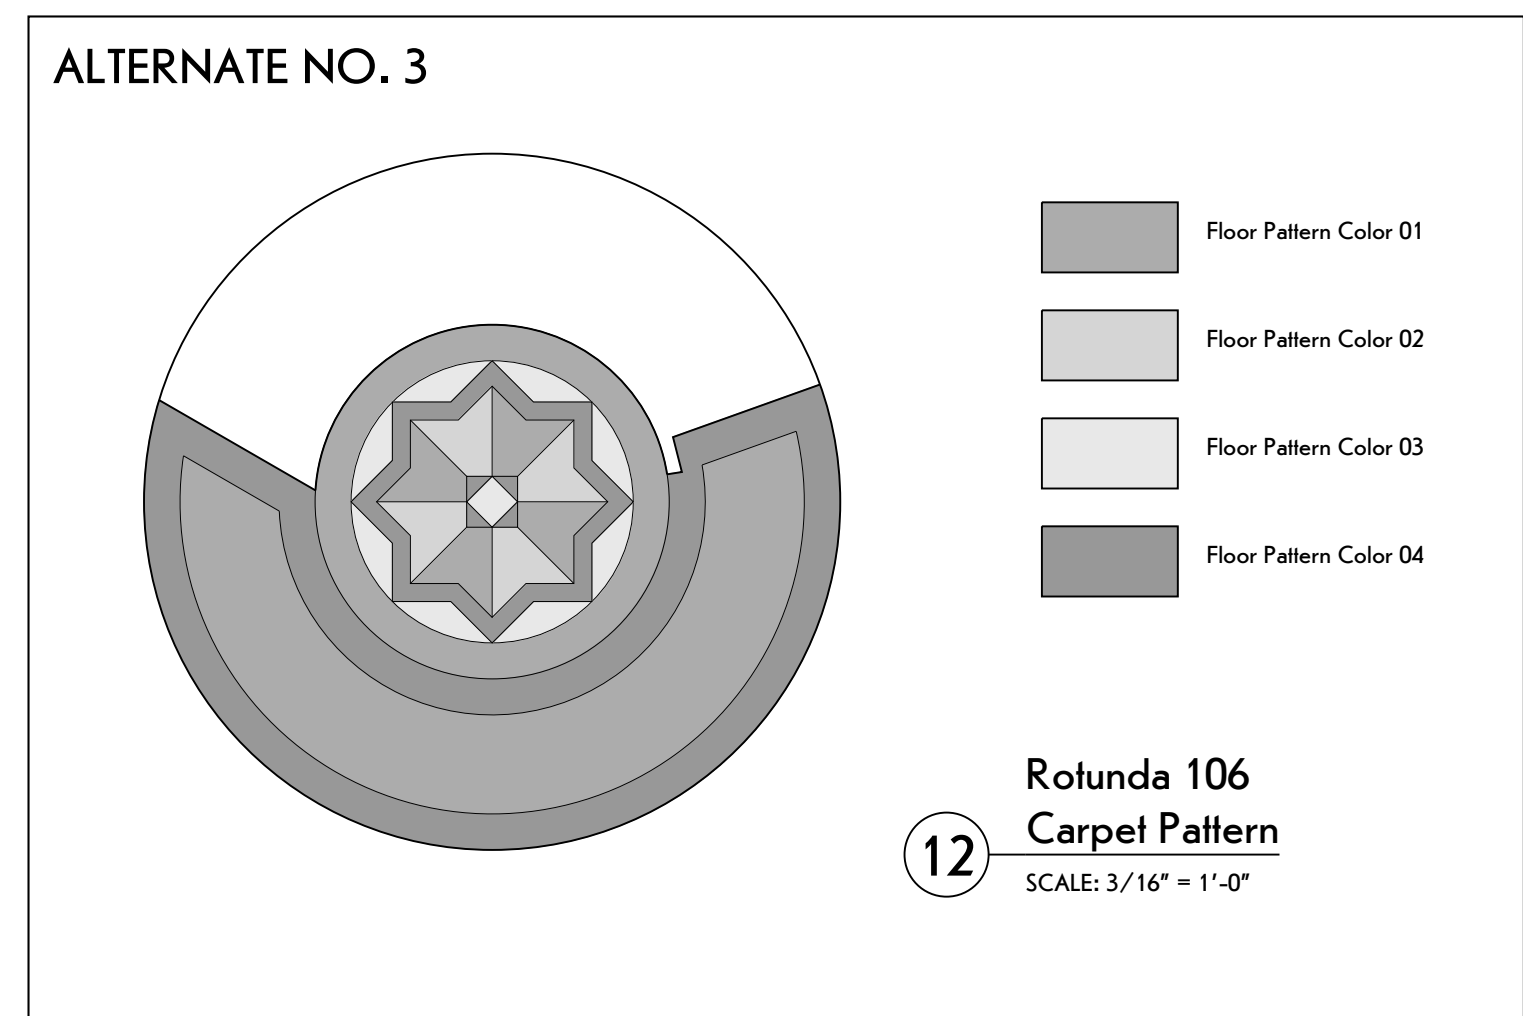
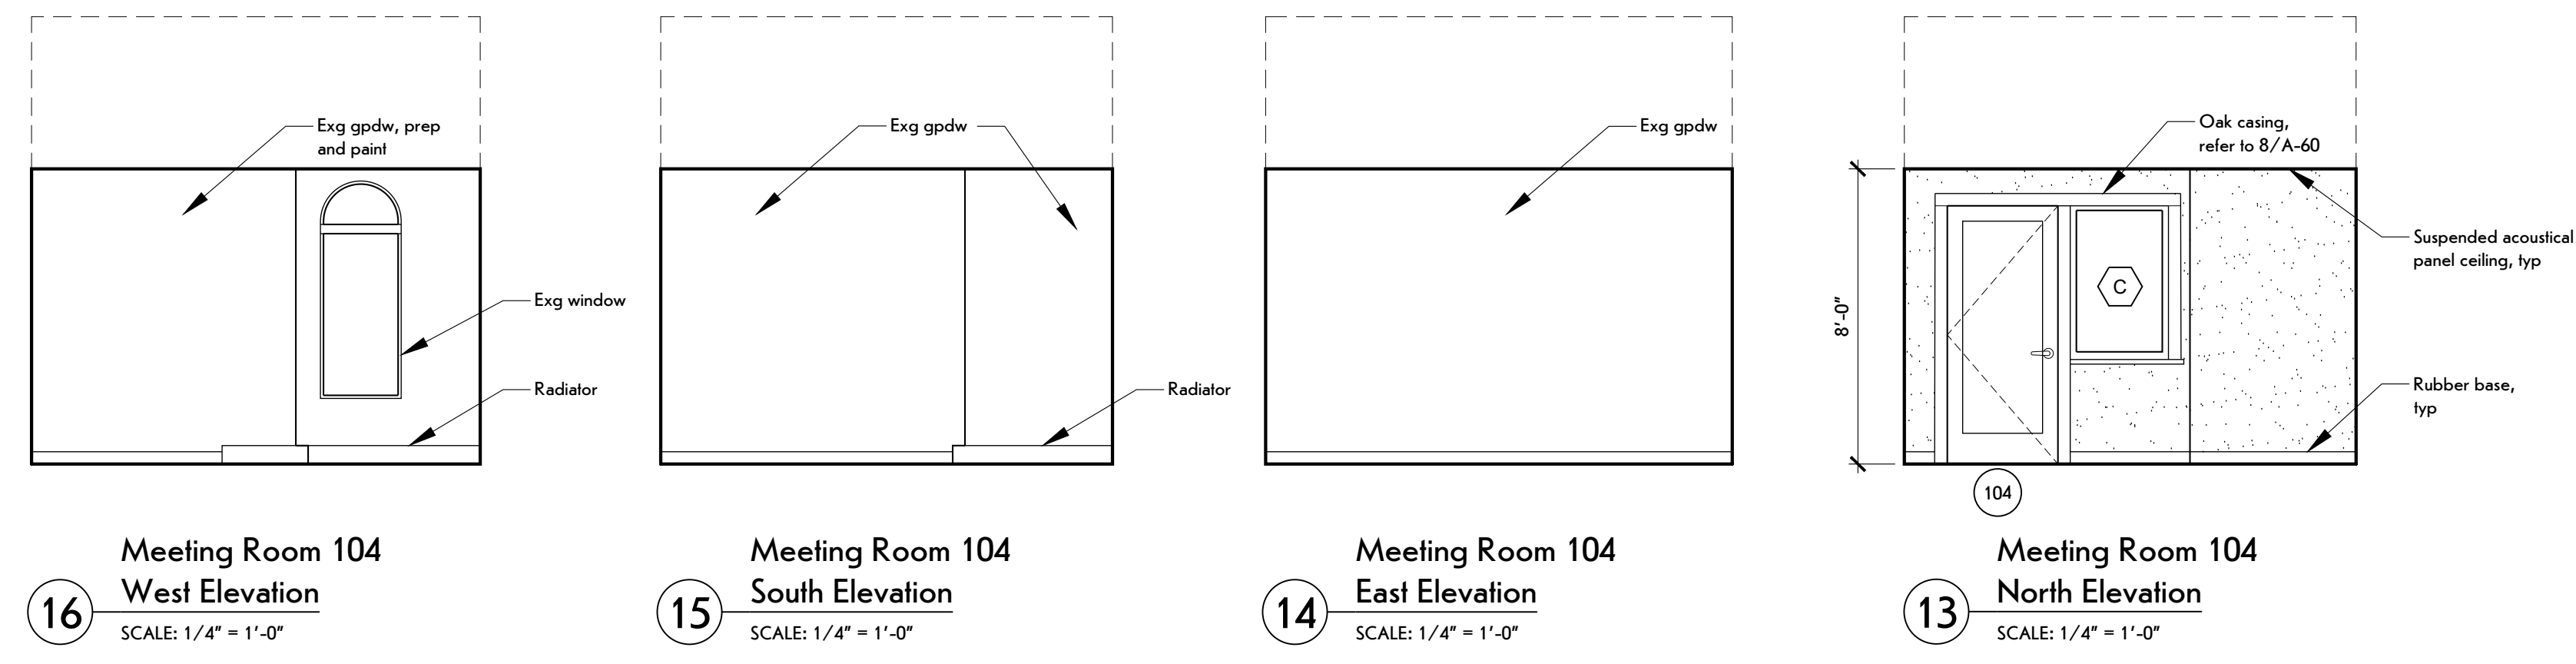
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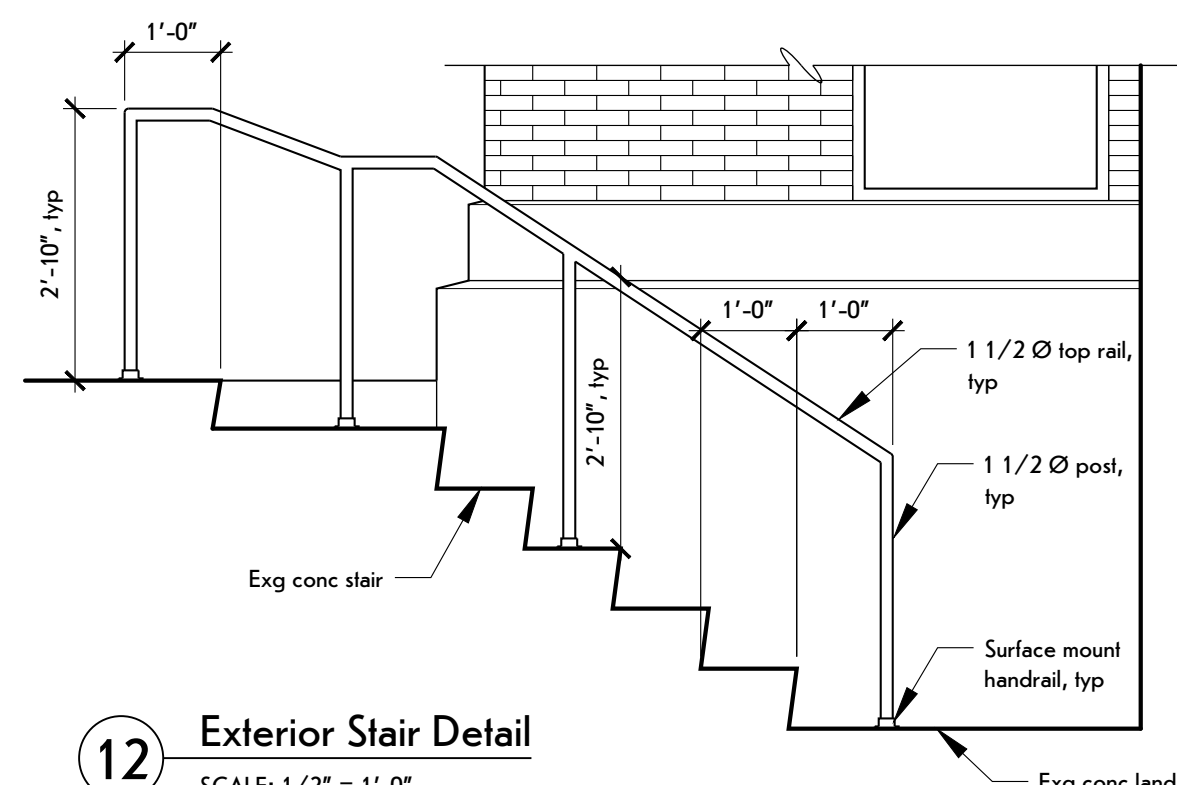
SHEET TITLE:

Main Level
Interior Elevations


SHEET NUMBER:

A-41







12 Exterior Stair Detail
SCALE: 1/2" = 1'-0"

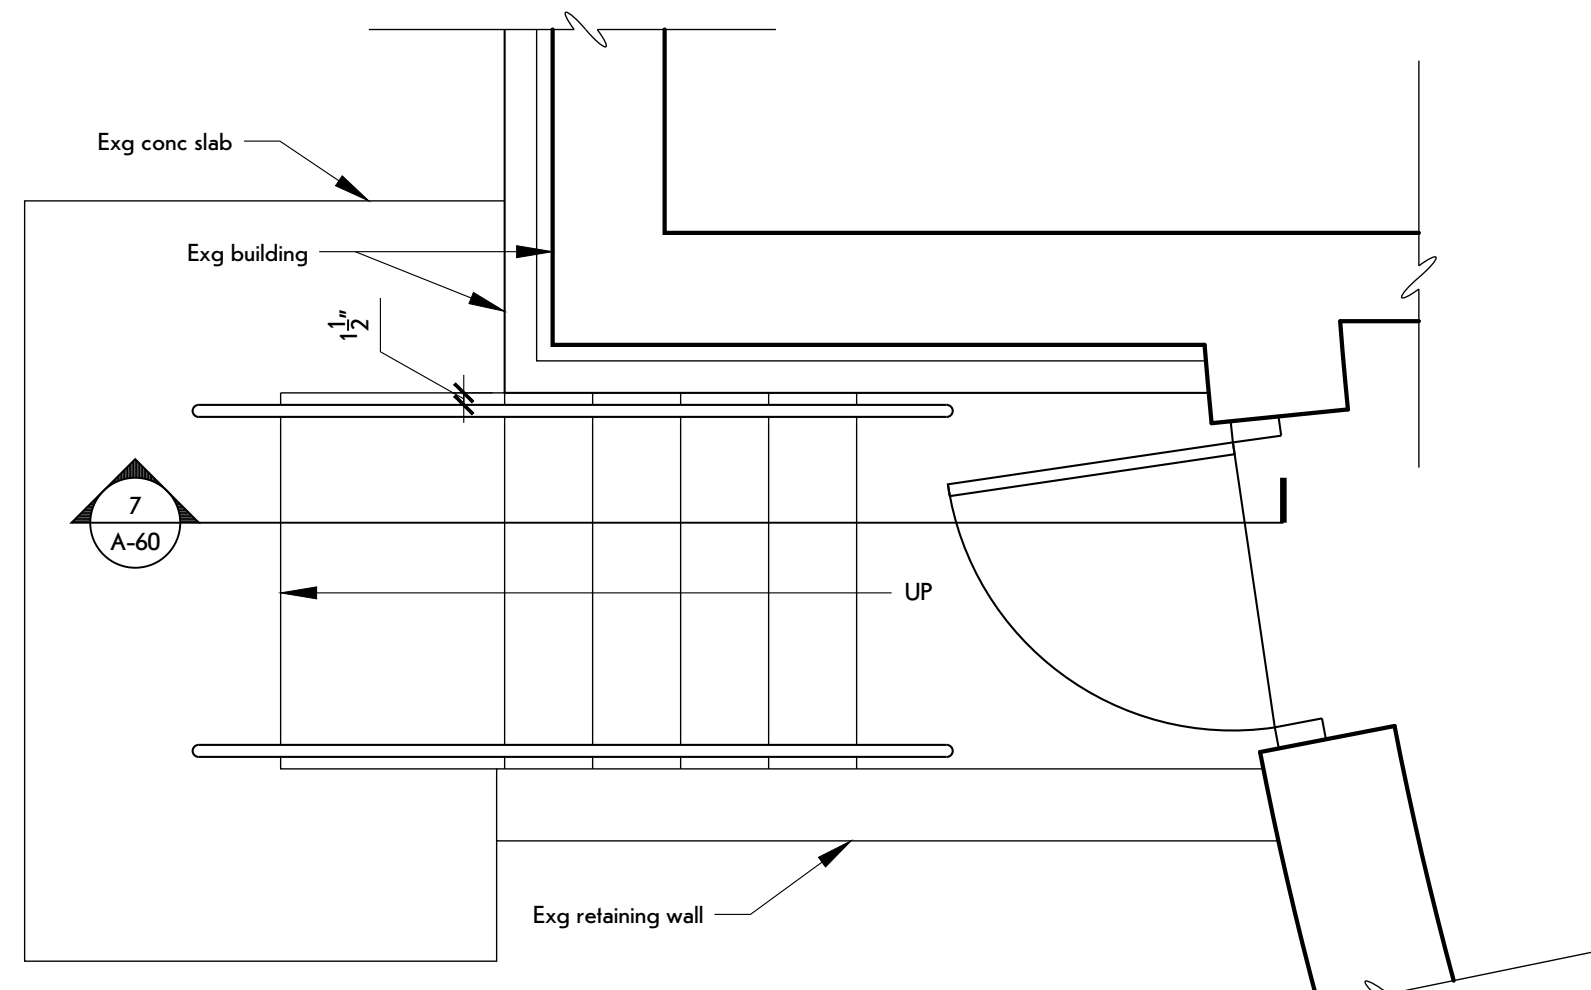


11 Enlarged Exterior Stair Plan
SCALE: 1/2" = 1'-0"

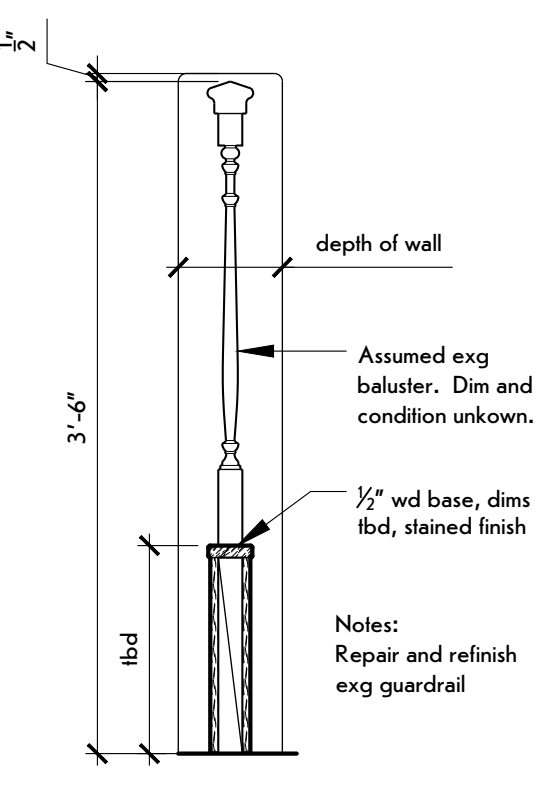


6 Guardrail Detail
SCALE: 1" = 1'-0"

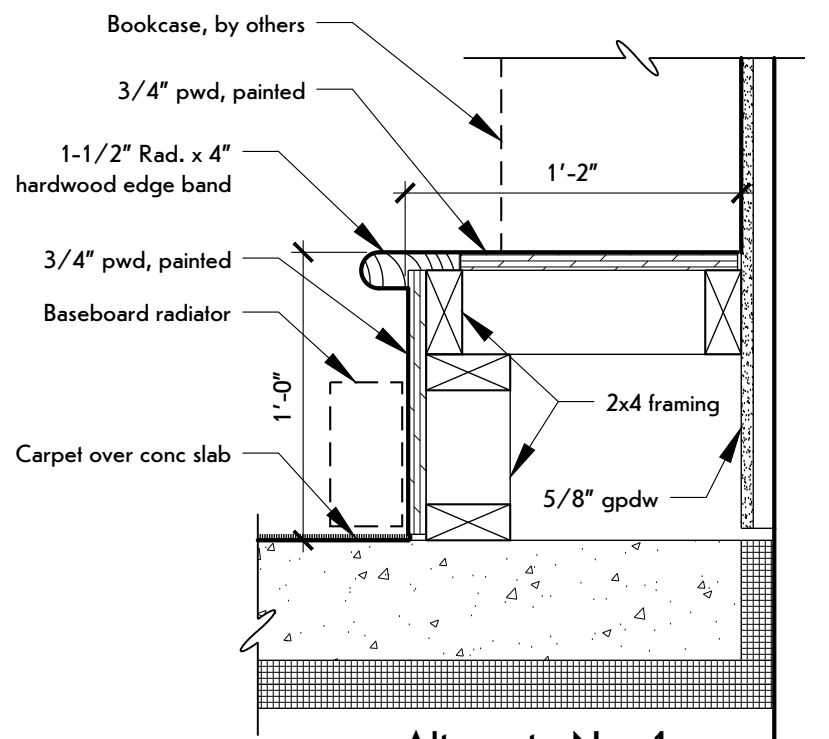


5 Alternate No. 1 Bookcase Ledge
SCALE: 1-1/2" = 1'-0"

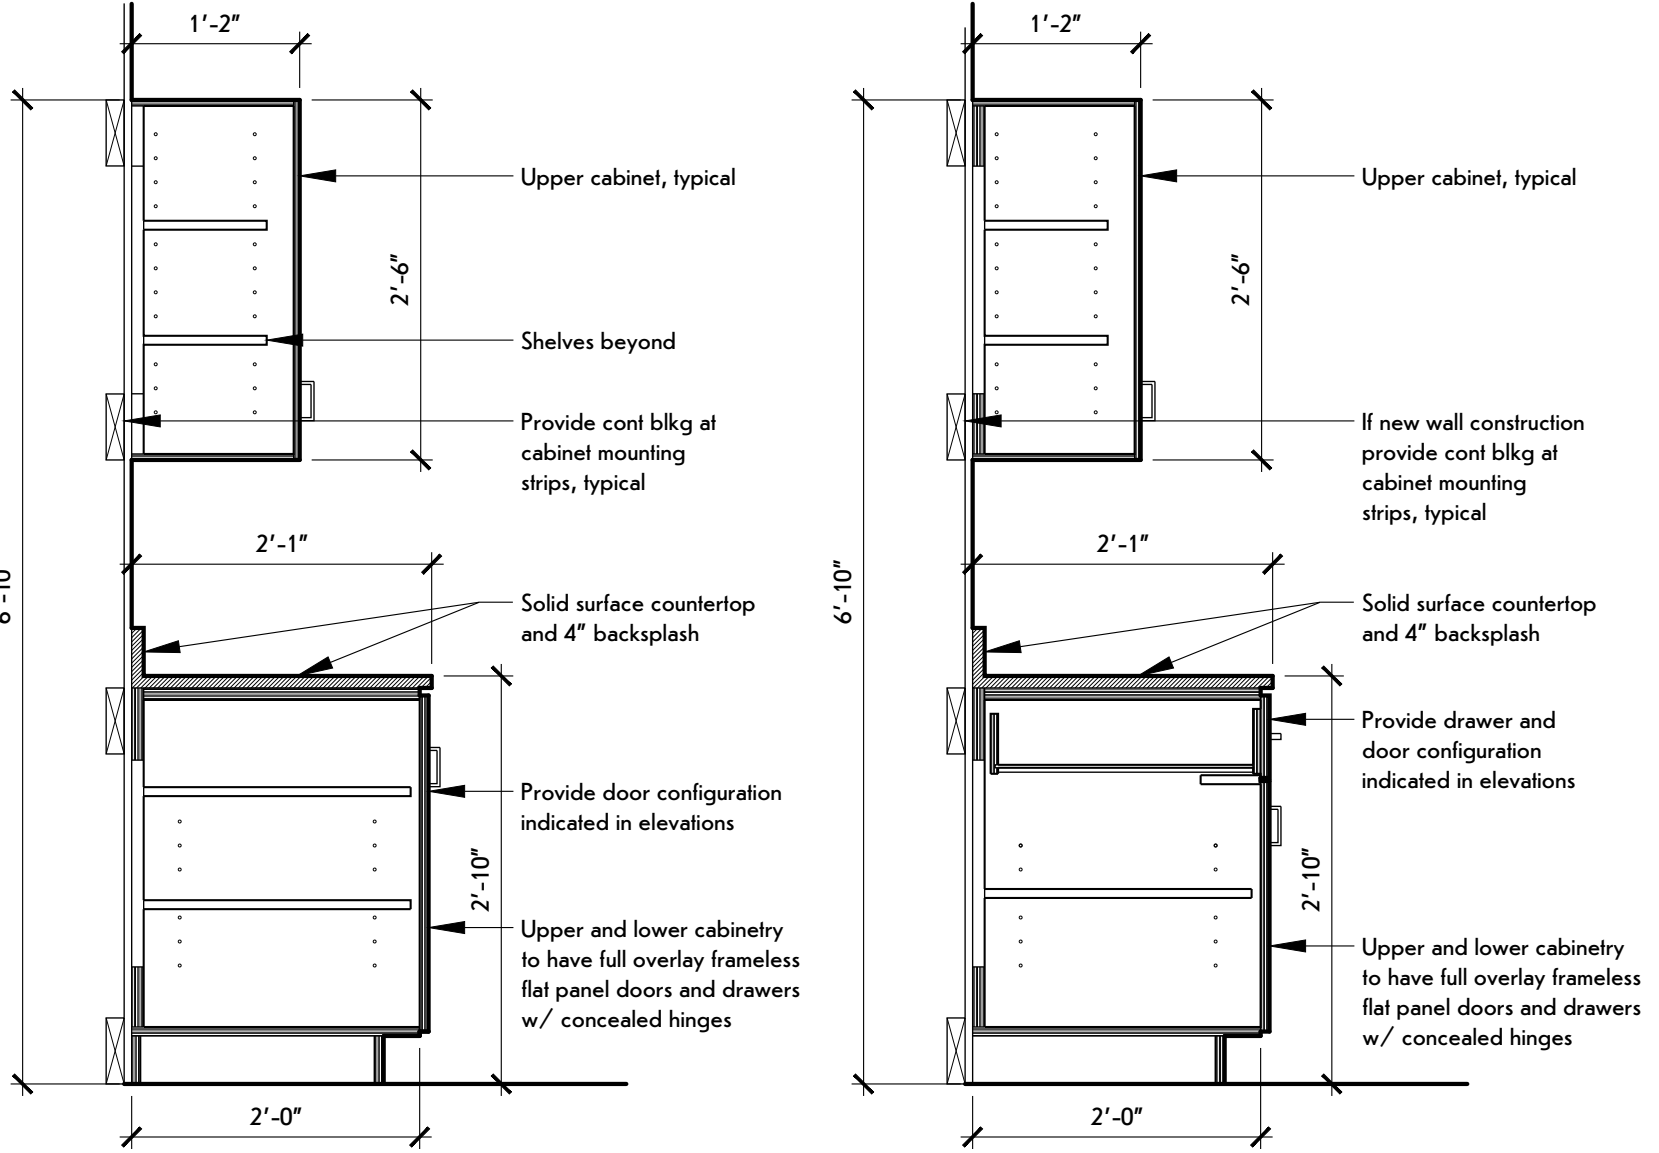


10 Workstation Section
SCALE: 1" = 1'-0"

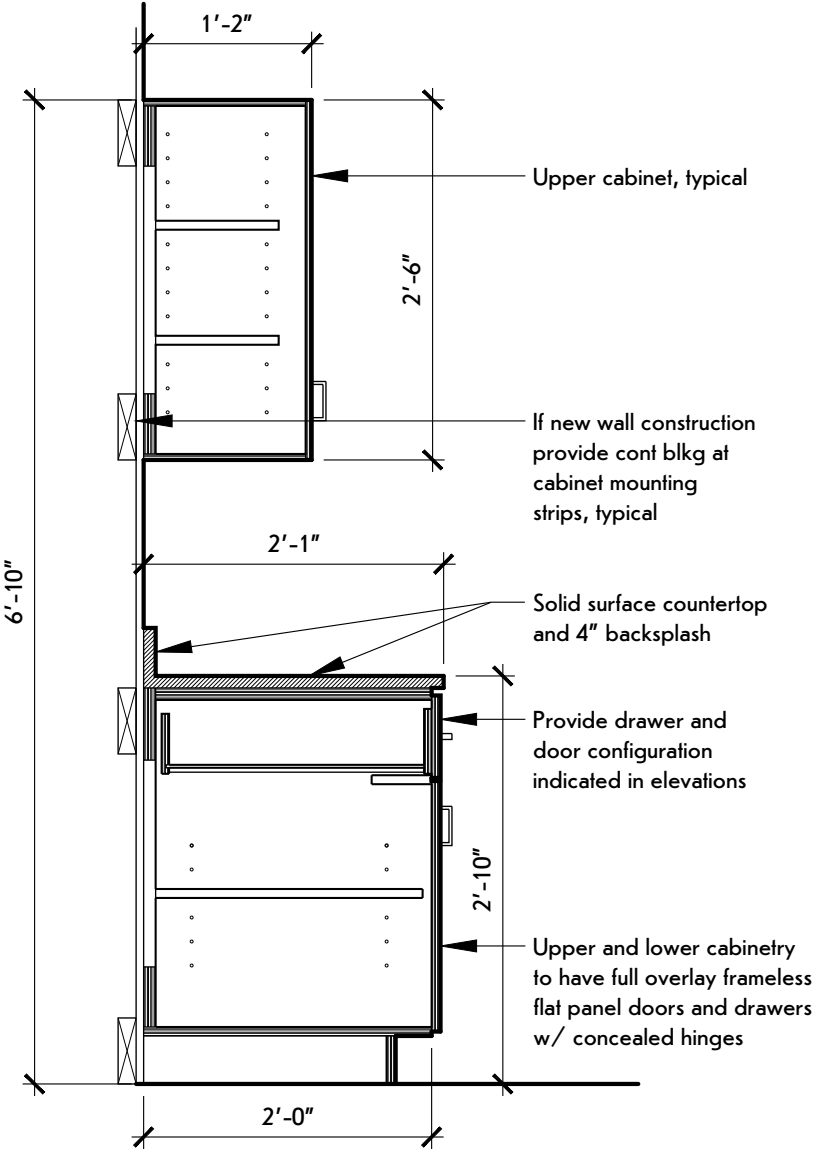


9 Typical Cabinet Section
SCALE: 3/4" = 1'-0"

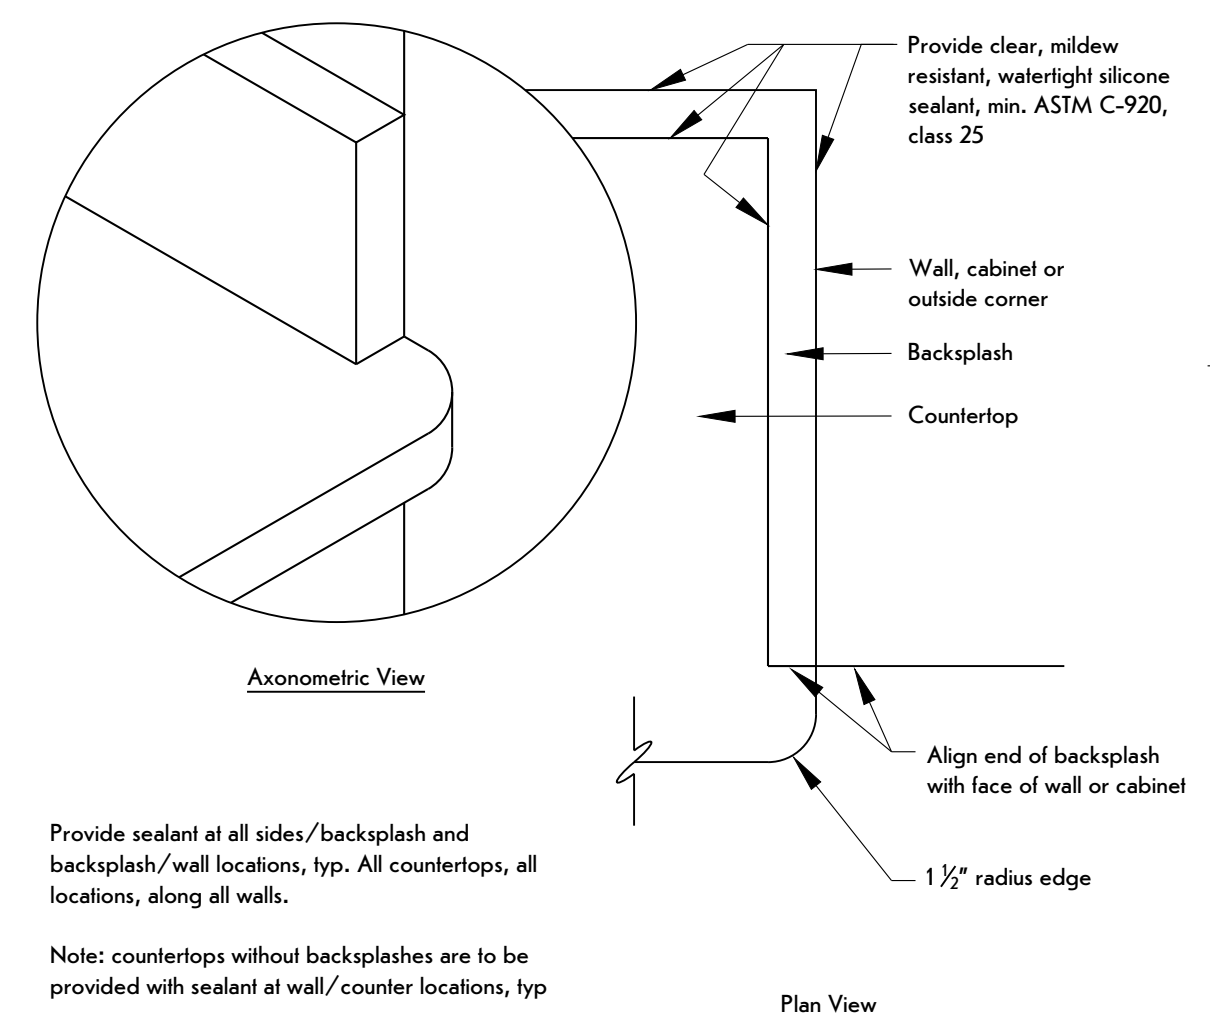


8 Solid Surface Countertop Corner Detail
SCALE: 3" = 1'-0"

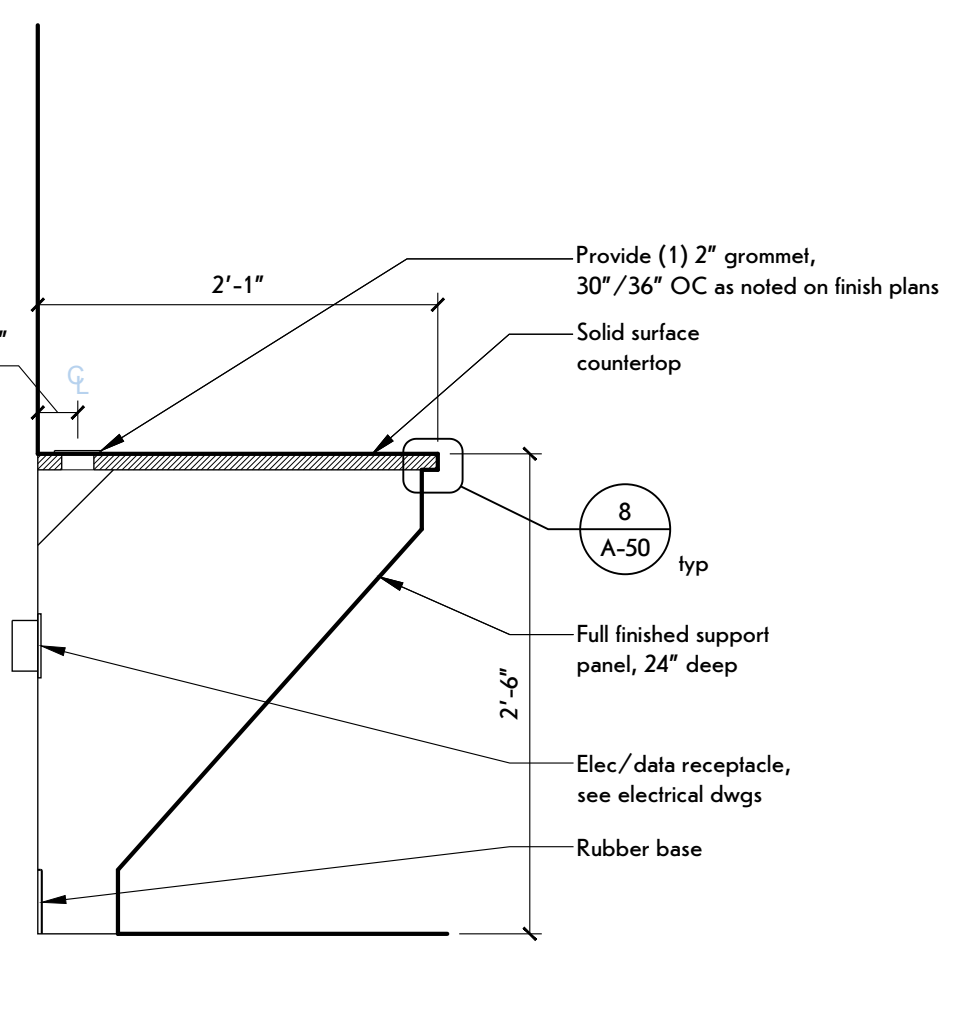


7 Workstation Section
SCALE: 1" = 1'-0"

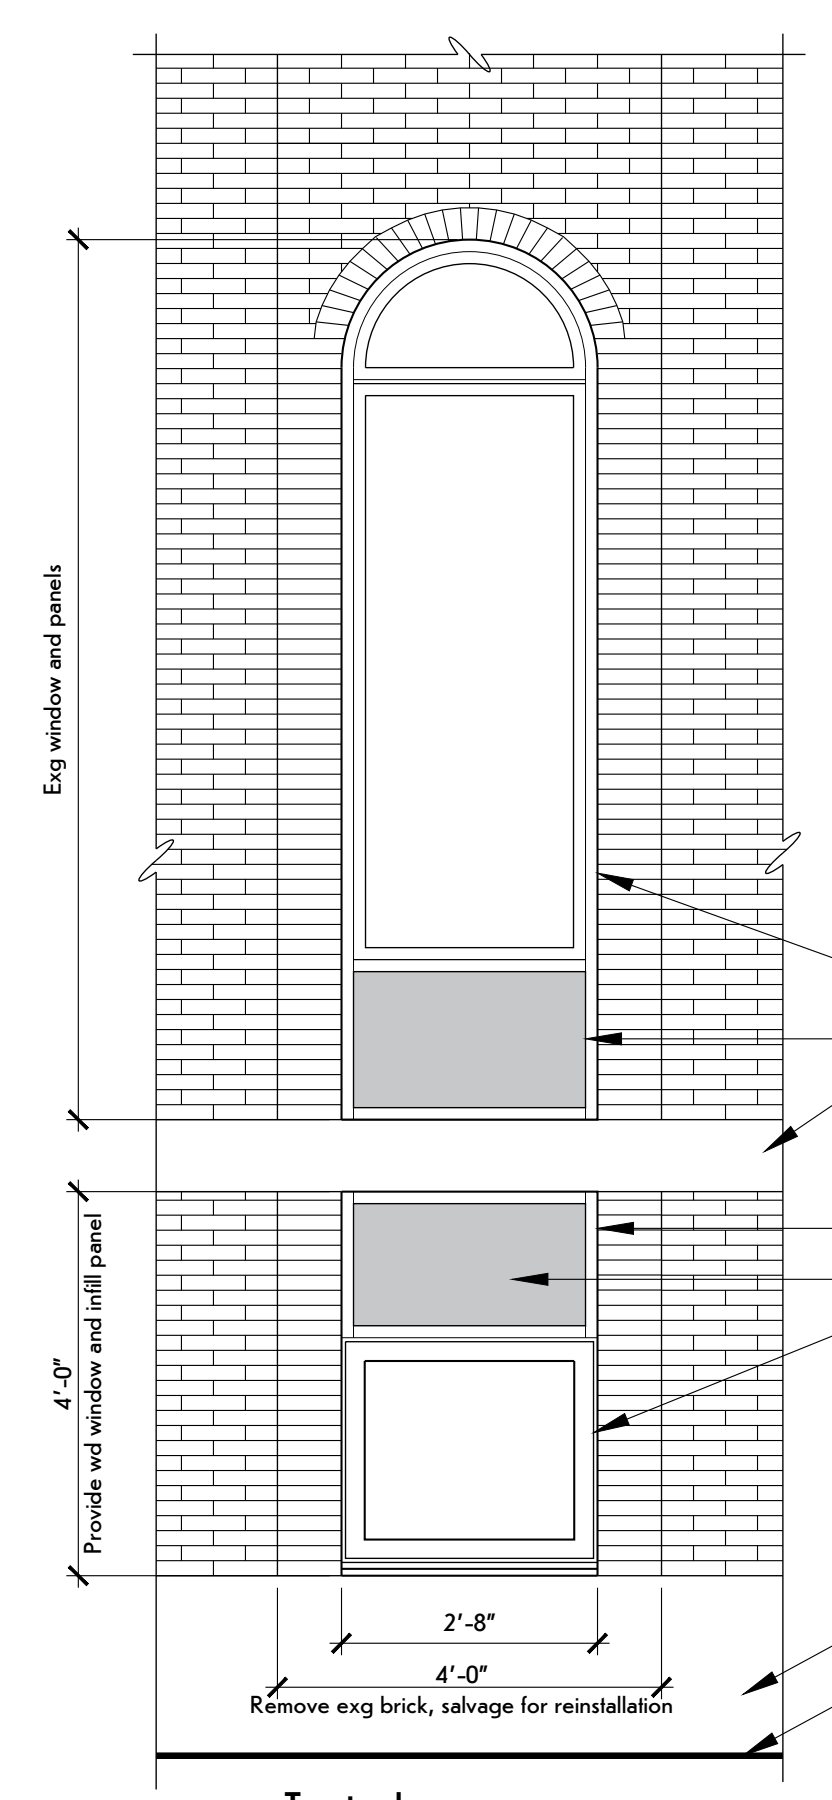


4 Typical Exterior Window Elevation
SCALE: 1/2" = 1'-0"

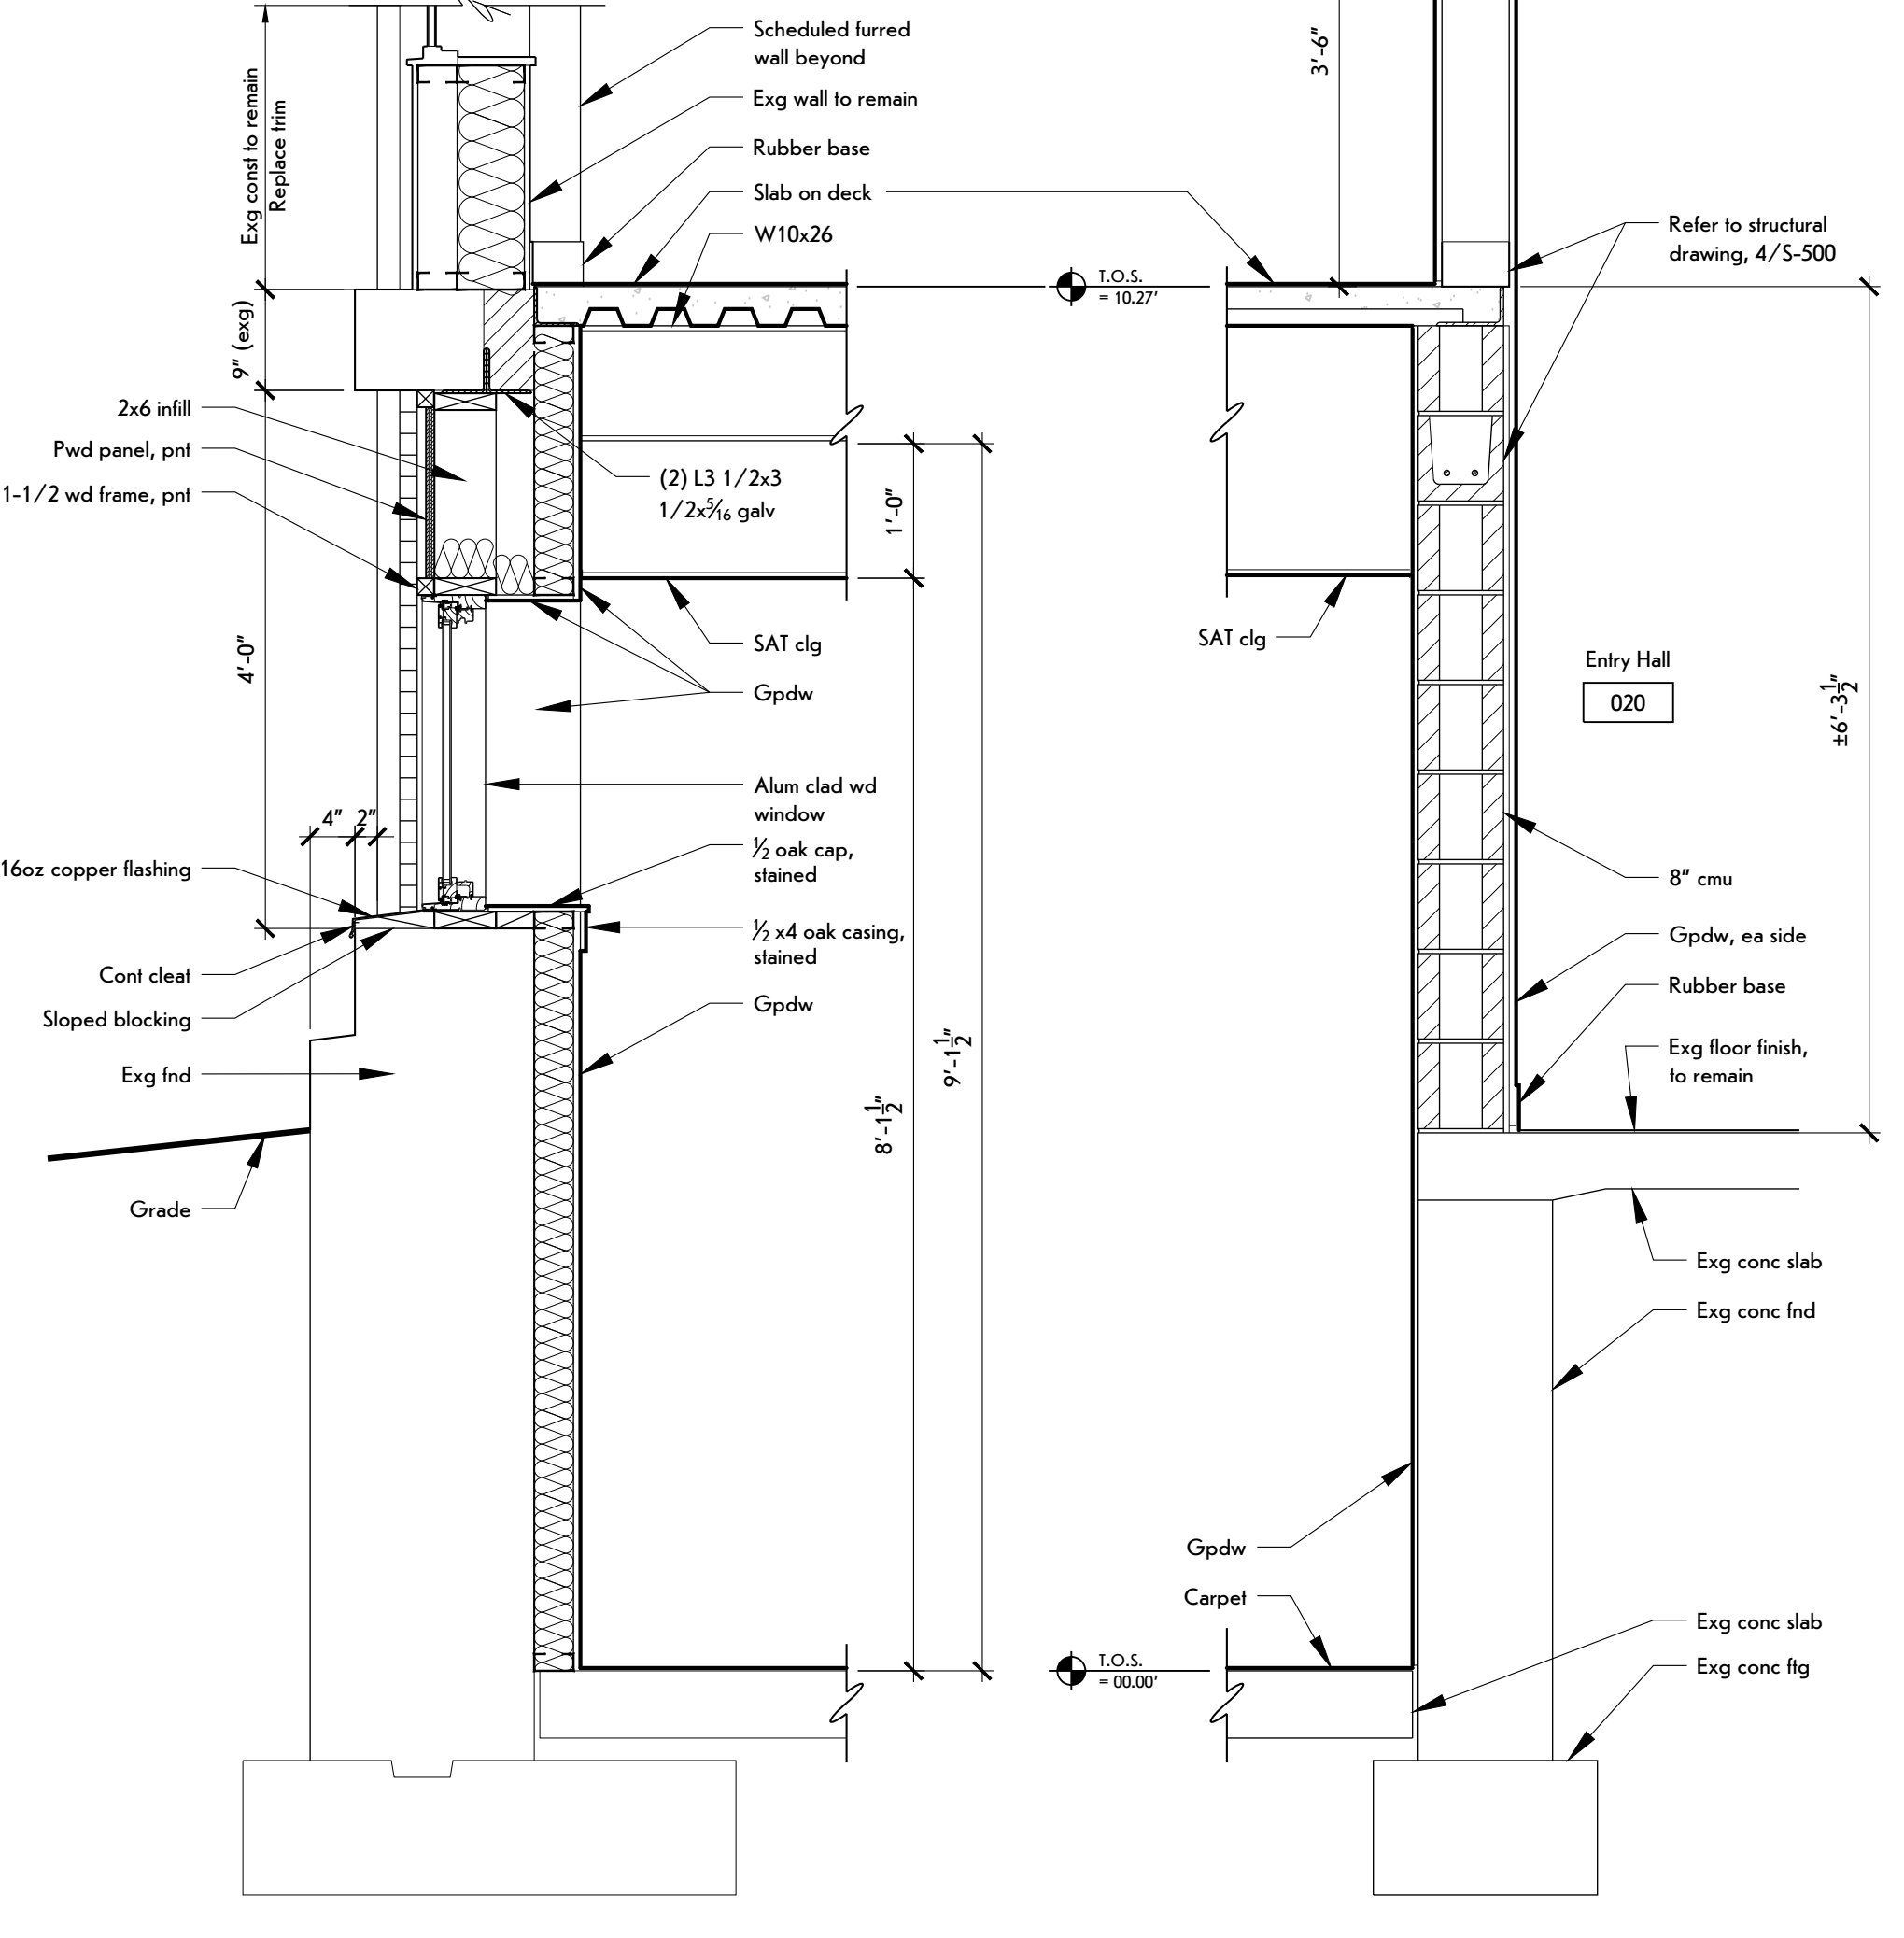

3 Typ Ext. Wall Section
SCALE: 3/4" = 1'-0"

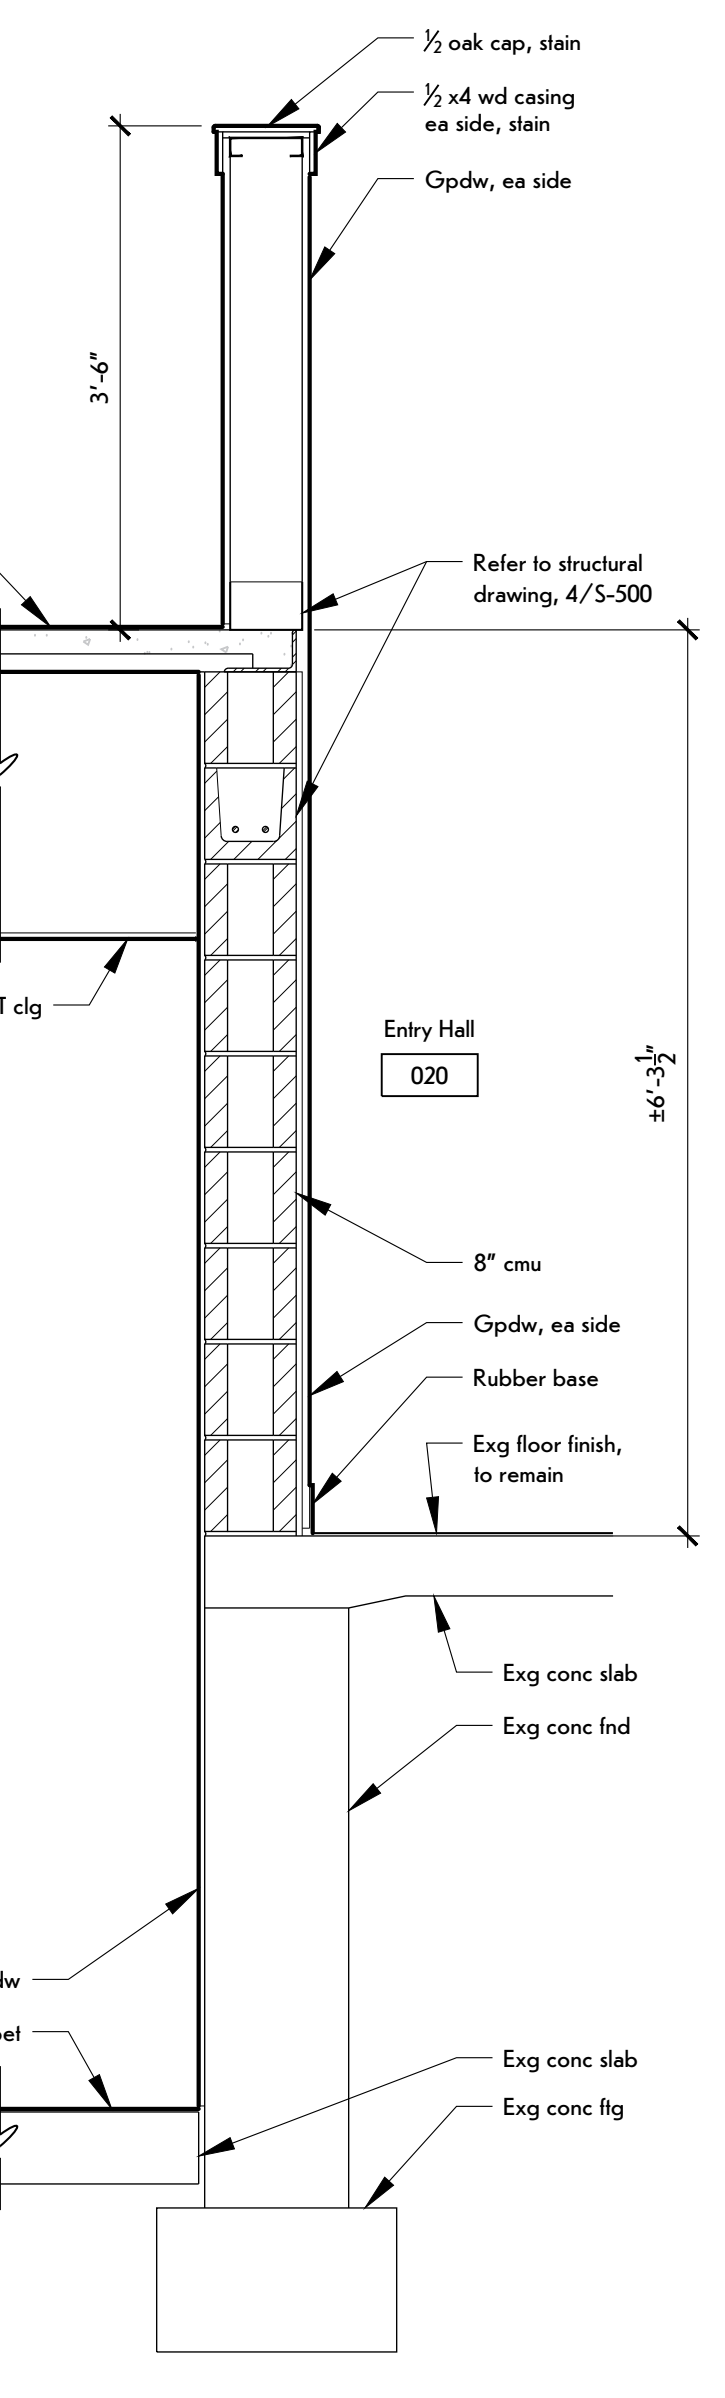

2 Wall Section
SCALE: 3/4" = 1'-0"

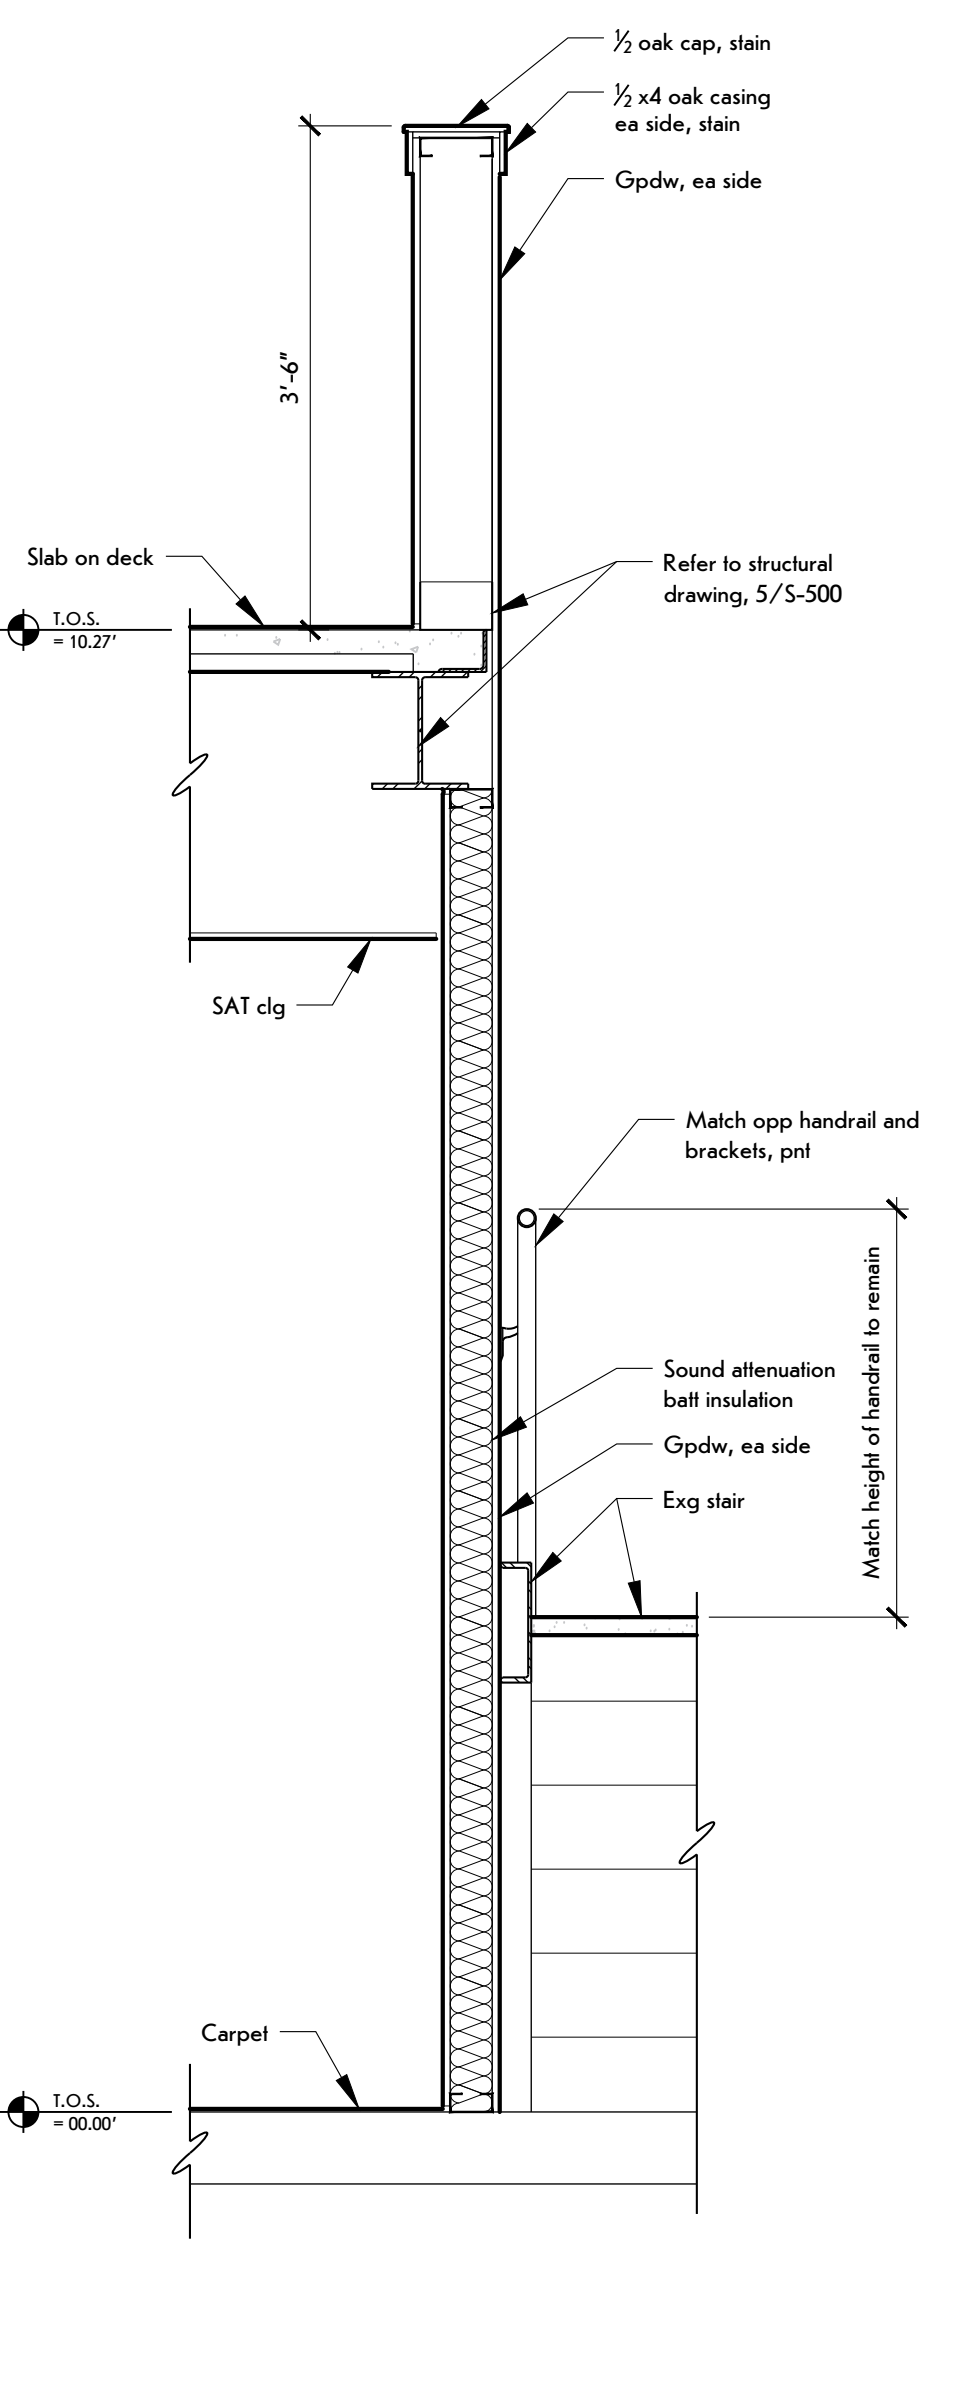

1 Wall Section
SCALE: 3/4" = 1'-0"



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REVISIONS:

#	Date	Description

CLIENT / OWNER:

Town of Warsaw
83 Center Street
Warsaw, NY 14569

PROJECT INFORMATION:
Expansion and Renovation
Warsaw Public Library
130 North Main Street, Warsaw, New York
PROJECT NUMBER: 22121
ISSUE DATE: February 25, 2025
DRAWN BY: LMY

SHEET TITLE:
Enlarged Plans & Details
SHEET NUMBER:
A-50



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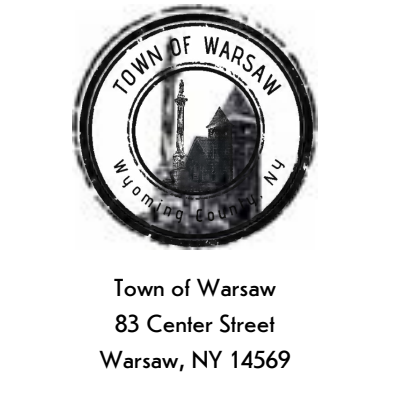
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130 North Main Street, Warsaw, New York

PROJECT NUMBER: 22121

ISSUE DATE: February 25, 2025

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SHEET TITLE:


Schedules & Details

SHEET NUMBER:

A-60


DOORS															
DOOR NO.	SIZE			MAT.	TYPE	FINISH	GLASS	RATING	FRAMES						
	W	H	T						MAT.	TYPE	FINISH	FRAME ANCHORAGE	WALL THK	HARD WARE	REMARKS/NOTES
001A	3'-0"	7'-0"	1-3/4'	hm	1	pnt	GL-1	--	hm	--	pnt	4/A-60	5 3/8"	SET A	
001B	3'-0"	7'-0"	1-3/4'	hm	1	pnt	GL-1	3/4 hr	hm	--	pnt	4/A-60	4 7/8"	SET A	
001C	3'-0"	7'-0"	1-3/4'	hm	2	pnt	--	--	hm	--	pnt	4/A-60	5 3/8"	SET B	
001D	3'-0"	7'-0"	1-3/4'	hm	Existing to remain				Existing to remain						
003	3'-2"	7'-0"	1-3/4'	hm	2	pnt	--	3/4 hr	hm	--	pnt	4/A-60	9"	SET B	
004	3'-0"	7'-0"	1-3/4'	hm	2	pnt	-	--	hm	--	pnt	4/A-60	4 7/8"	SET C	
008	2'-8"	7'-0"	1-3/4'	wd	Existing to remain				Existing to remain						
010	2'-8"	7'-0"	1-3/4'	wd	3	pnt	GL-1	--	wd	--	pnt	5/A-60	5"	SET C	Undercut 1"
011	3'-0"	7'-0"	1-3/4'	wd	Existing to remain				Existing to remain						
013	3'-0"	7'-0"	1-3/4'	hm	Existing to remain				Existing to remain						
102	3'-0"	7'-0"	1-3/4'	wd	Relocated Existing				Existing to remain						
104	3'-0"	7'-0"	1-3/4'	wd	4	stn	GL-1	--	wd	--	pnt	5/A-60	4 7/8"	SET C	Reinstall salvaged door

WINDOW SCHEDULE								
MARK	MAT	SIZE			OPERATION	GLASS/PANEL	FRAME ANCHORAGE	REMARKS
		W	H	SILL				
A	wd/alum	2'-8"	2'-4"	±5'-7"	fixed	--	3/A-50	
B	wd	Existing			fixed	GL-1	--	Glaze exg, historic windows
C	wd	2'-8"	4'-2"	2'-10"	fixed	GL-1	6/A-60	

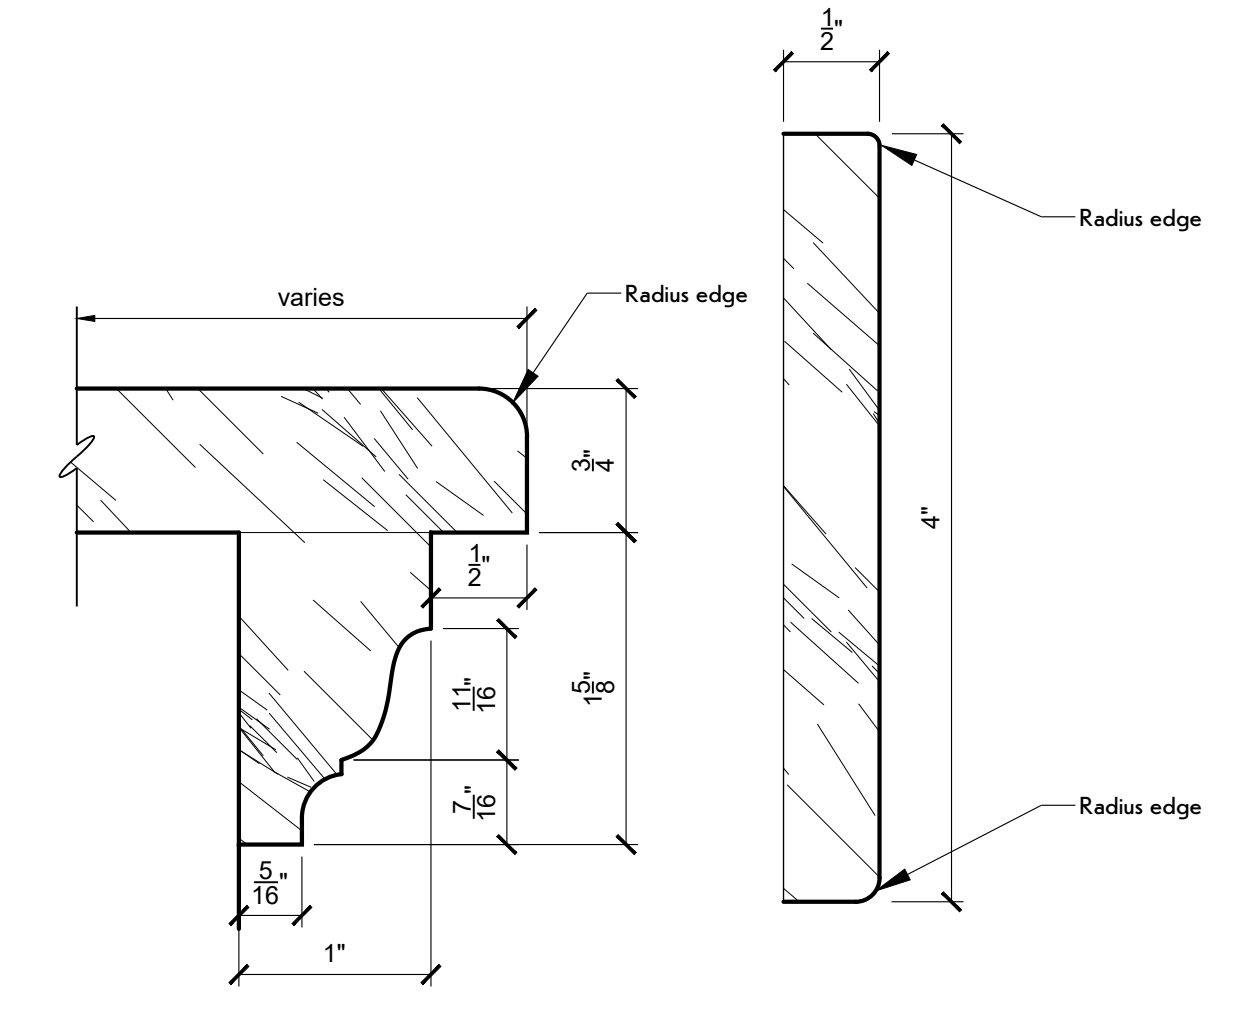


9 Wood Casing Detail
FULL SCALE
Basis of design, SAW 3380

8 Wood Casing Detail
FULL SCALE

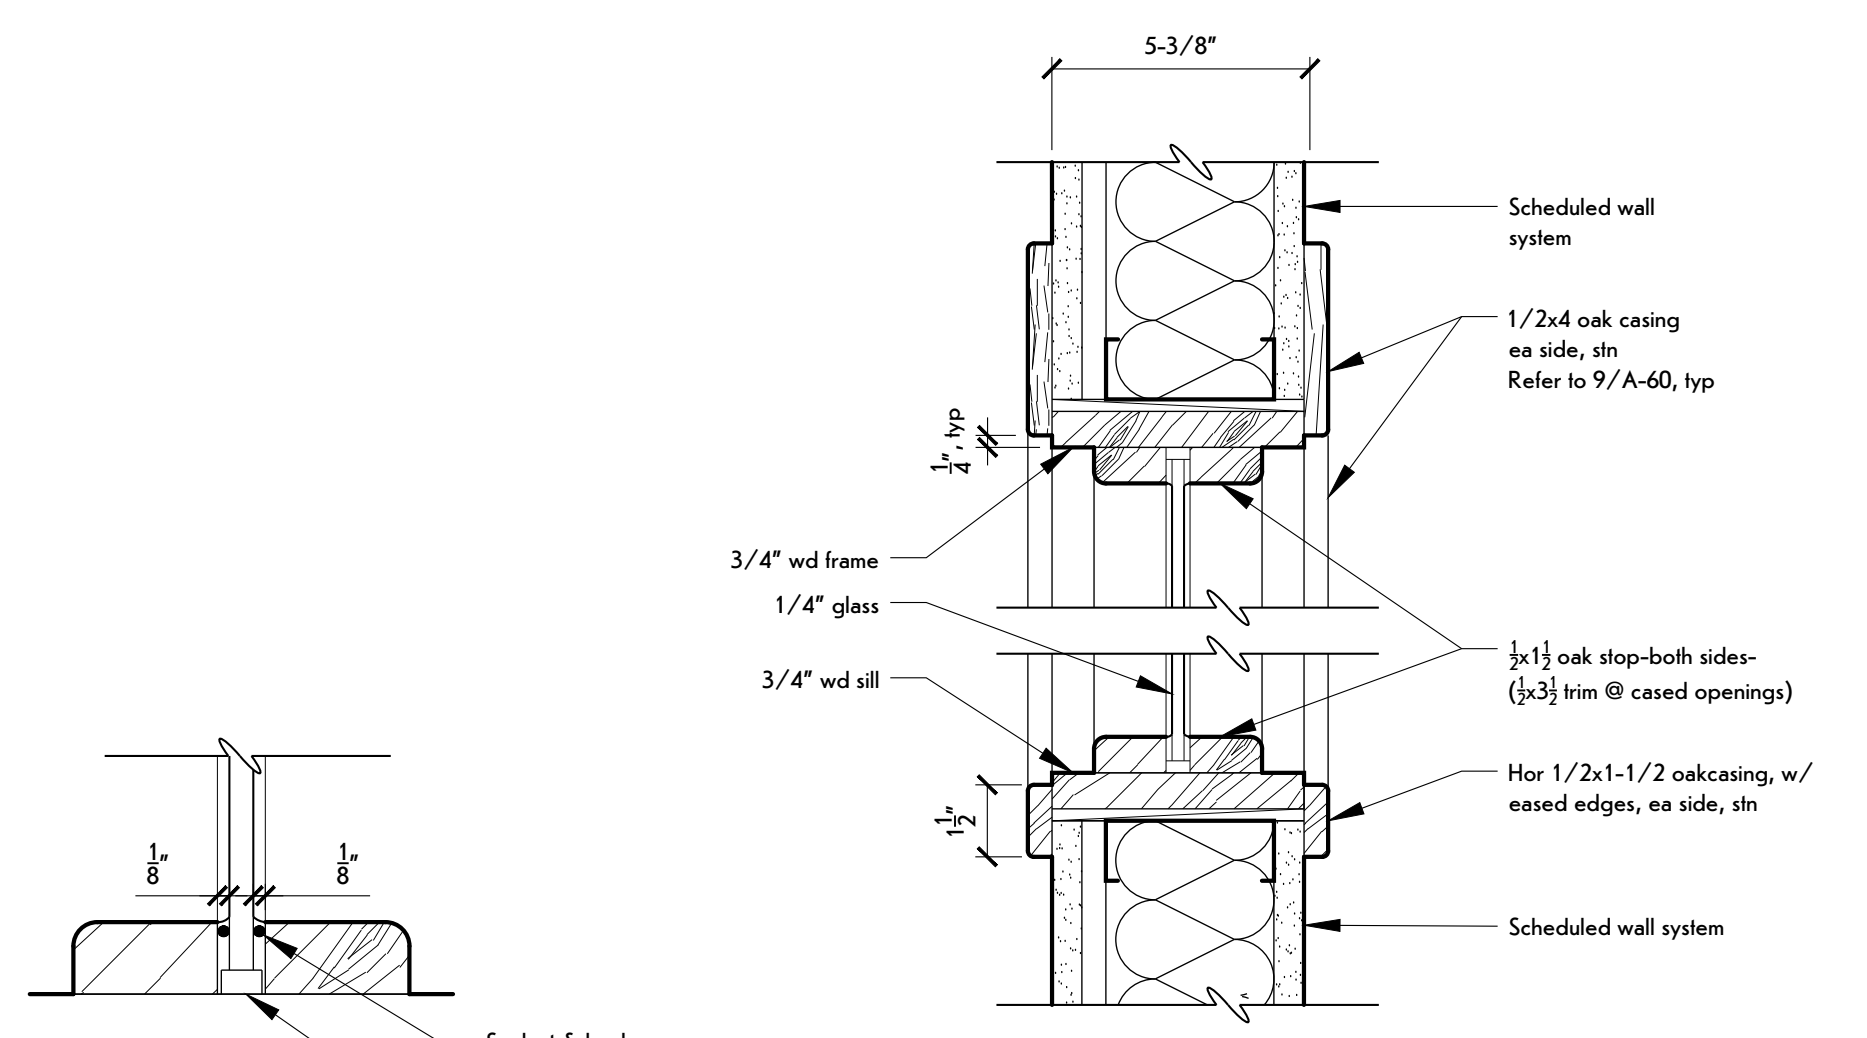


7 Glazing Detail
6"=1'-0"

6 Window Head/Jamb Detail
3"=1'-0"

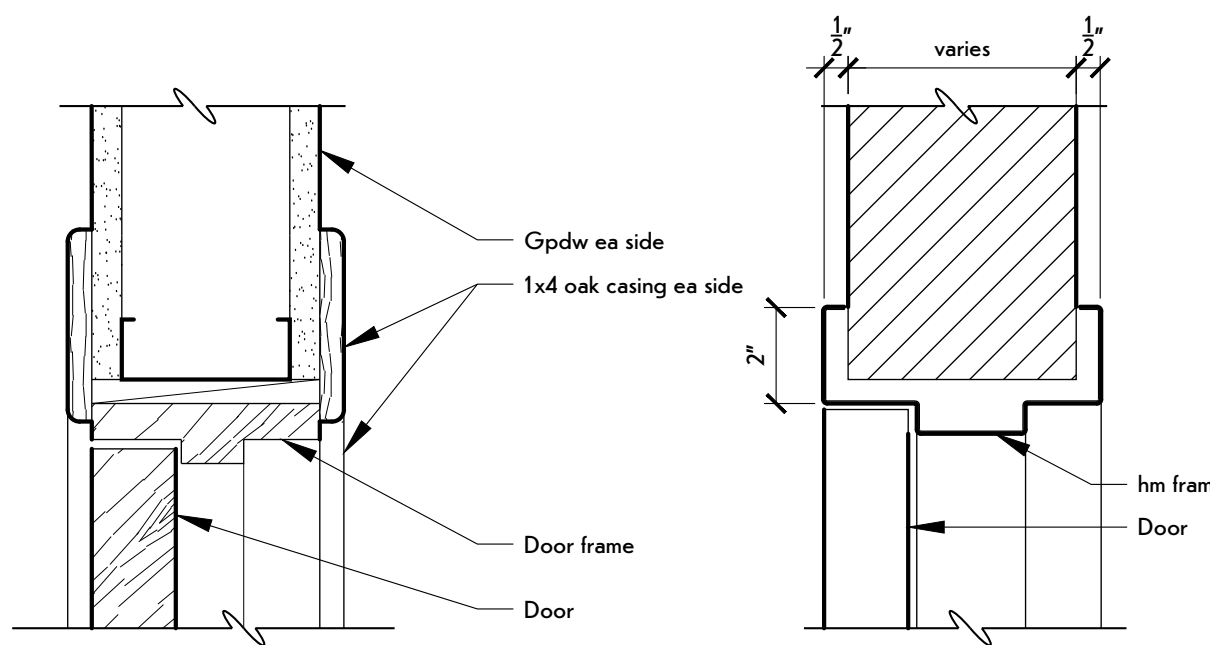


5 Door Head/Jamb
3"=1'-0"


4 Door Head/Jamb
3"=1'-0"

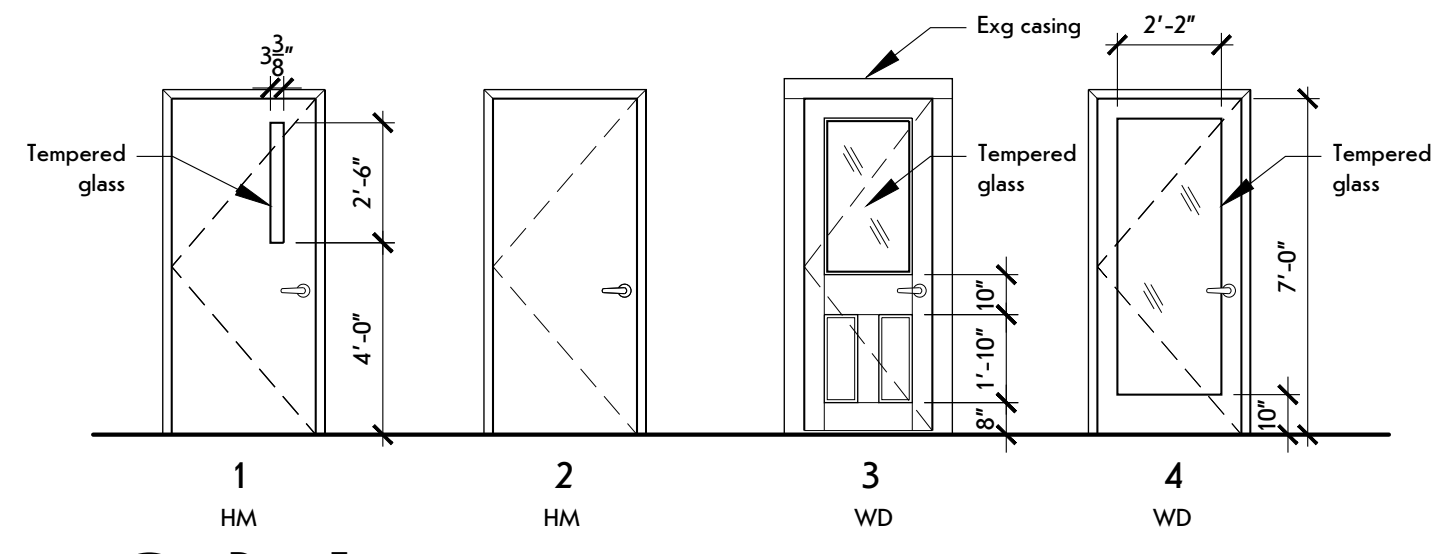

3 Door Types
Not to Scale

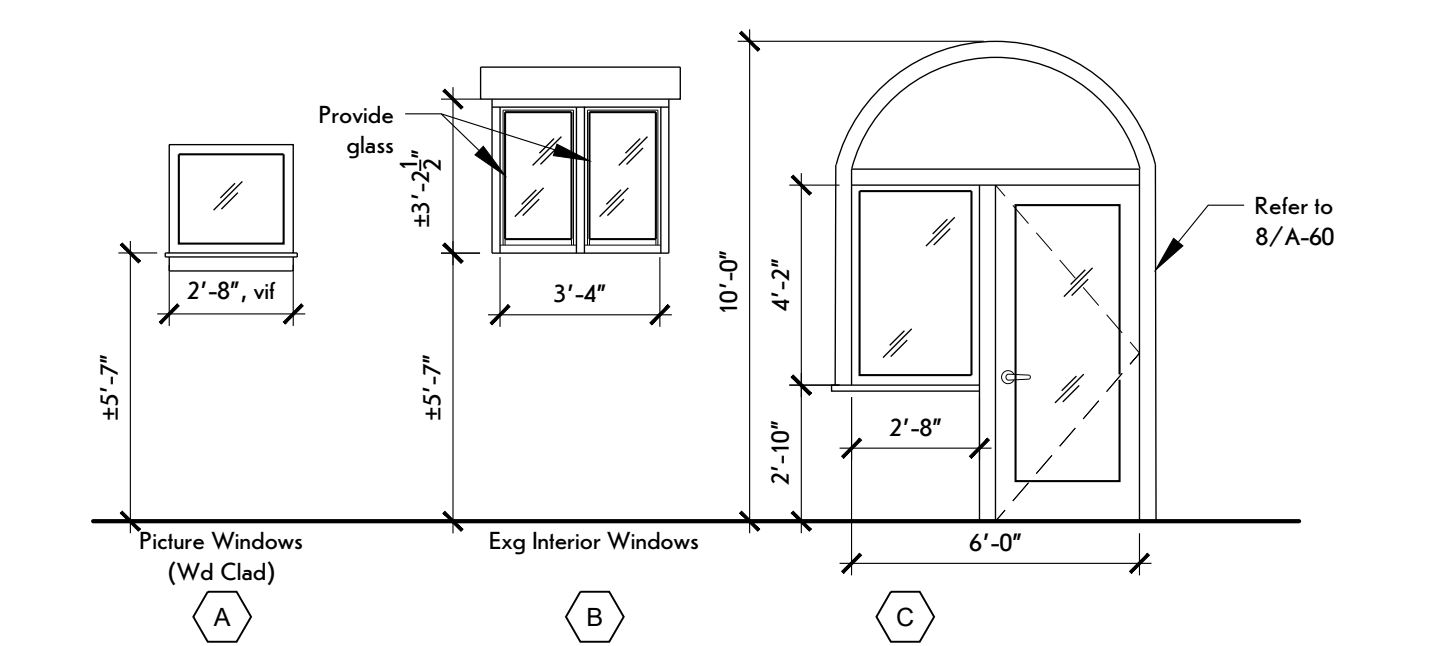

2 Window Types
Not to Scale

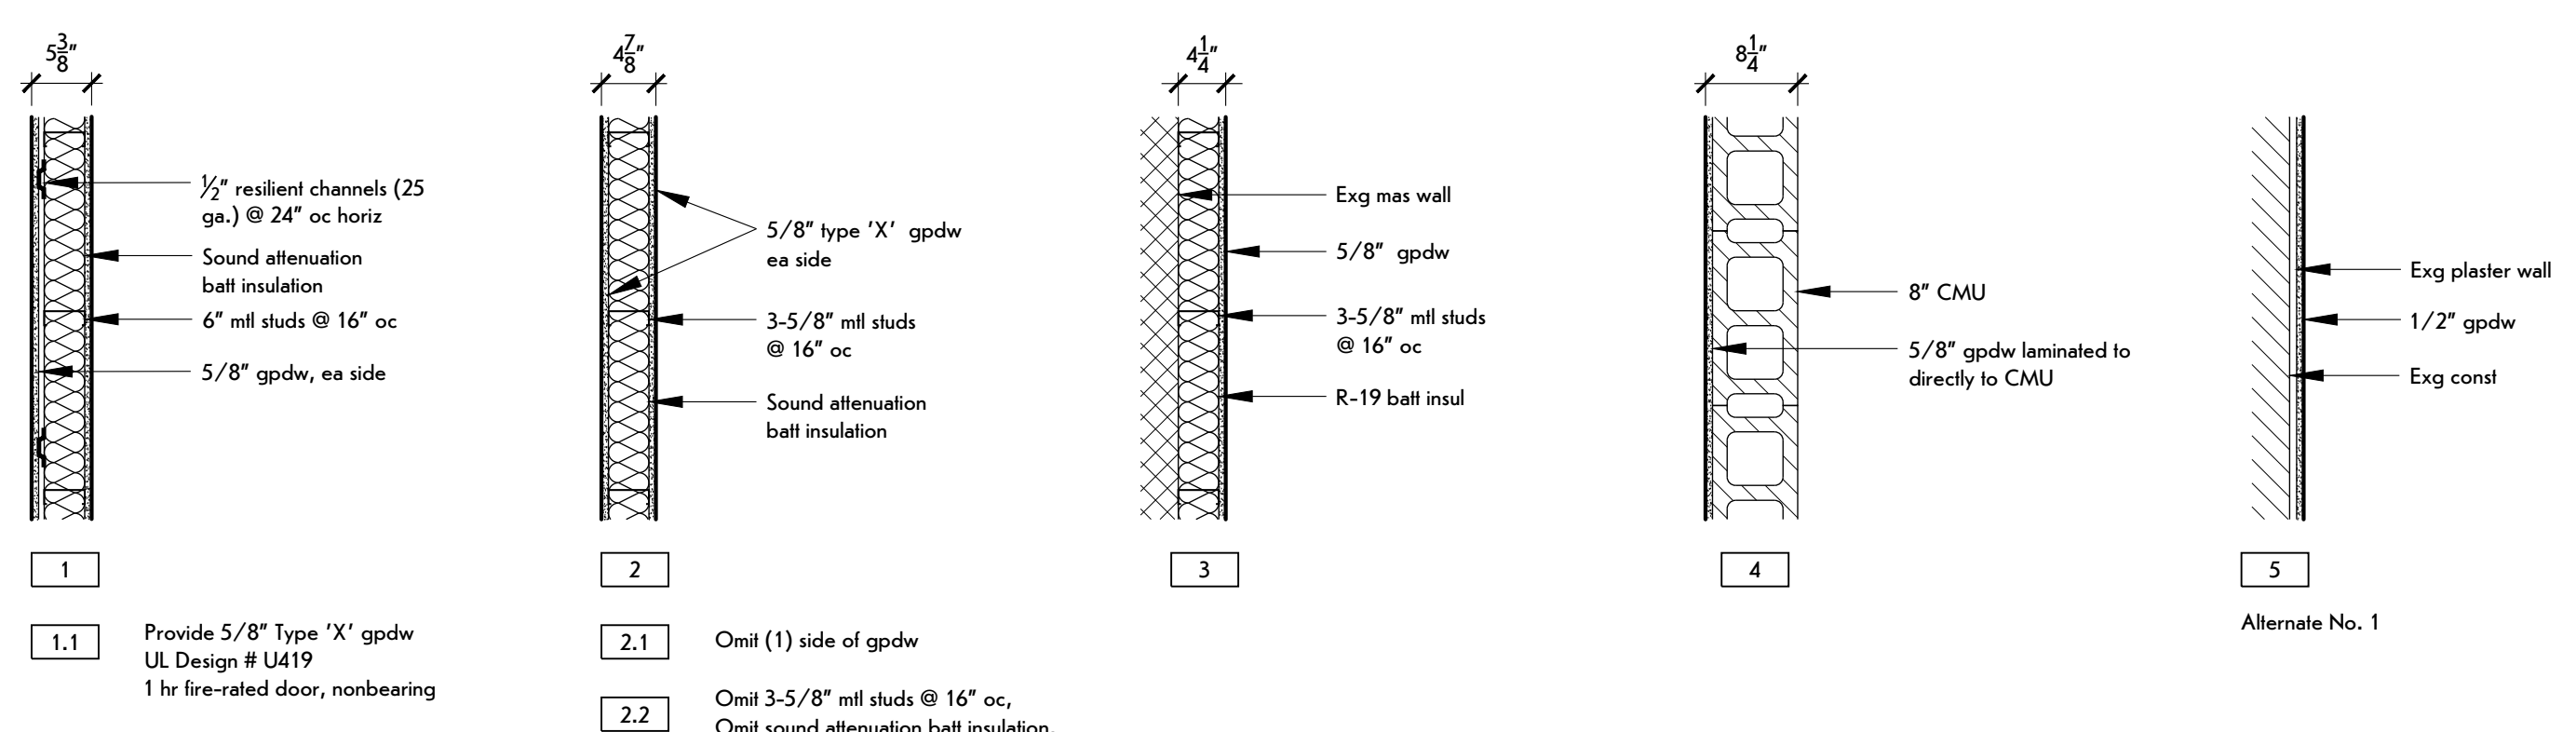

1 Wall Types
SCALE: 3/4" = 1'-0"
General Note:
- Provide deflection track at all partitions built to underside of new or existing slab
- Provide solid 2x blocking for wall mounted handrails

1.1 Provide 5/8" Type 'X' gpdw UL Design # U419 1 hr fire-rated door, nonbearing

2.1 Omit (1) side of gpdw

2.2 Omit 3-5/8" mill studs @ 16" oc, Omit sound attenuation batt insulation, Add 6" (600S162-54) mill studs @ 16" oc

5 Alternate No. 1



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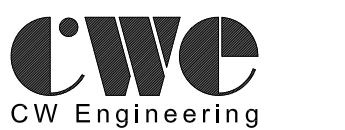
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REVISIONS:

#	Date	Description

CLIENT / OWNER:



Town of Warsaw
83 Center Street
Warsaw, NY 14569

PROJECT INFORMATION:

Design Development
Warsaw Public Library
130 North Main Street, Warsaw, New York

PROJECT NUMBER: 22120

ISSUE DATE: 2/21/2024

DRAWN BY: CWE

SHEET TITLE:

PLUMBING

SHEET NUMBER:

P-10

REMOVALS - PLUMBING



1. COORDINATE REMOVALS WITH NEW WORK.
2. WHERE FIXTURES ARE SHOWN TO BE REMOVED COORDINATE TERMINATIONS OF EXISTING PIPING WITH NEW WORK. REMOVE BRANCH PIPING TO THE MAINS AND CAP.
3. PATCH SURFACES TO MATCH EXISTING.

NOTES - PLUMBING

1. COORDINATE FIXTURES WITH THE ARCHITECTURAL PLANS. ACCESSIBLE FIXTURES TO COMPLY WITH ICC A117.1 STANDARDS. ACCESSIBLE SINKS - INSULATE OR PROTECT PIPING UNDER LAV PER A117.1.
2. PROVIDE ALL PIPING INCLUDING CONNECTIONS TO EQUIPMENT AND FIXTURES. INSTALL PIPING CONCEALED WHERE EVER POSSIBLE.
3. PROVIDE AND INSTALL MATERIALS IN ACCORDANCE WITH THE PLUMBING CODE.
4. INSULATE ALL NEW DOMESTIC COLD WATER AND HOT WATER PIPING.
5. PROVIDE COMPLETE SYSTEM IN ACCORDANCE WITH STATE AND LOCAL CODES. PAY ALL ASSOCIATED FEES AND OBTAIN ALL REQUIRED INSPECTIONS.
6. PROVIDE FIRE-STOPPING AT PIPE PENETRATION OF THE BOILER ROOM WALLS.
7. PROVIDE PLUMBING FOR FIXTURES. PROVIDE STOP VALVES FOR WATER CONNECTIONS.


SYMBOLS - PLUMBING

	BALL VALVE	
	COLD WATER	
	HOT WATER	
	SANITARY DRAINAGE (WASTE OR SOIL)	
	VENT	
	DECK PLATE CLEAN OUT (FLOOR)	
	CONNECT TO EXISTING	

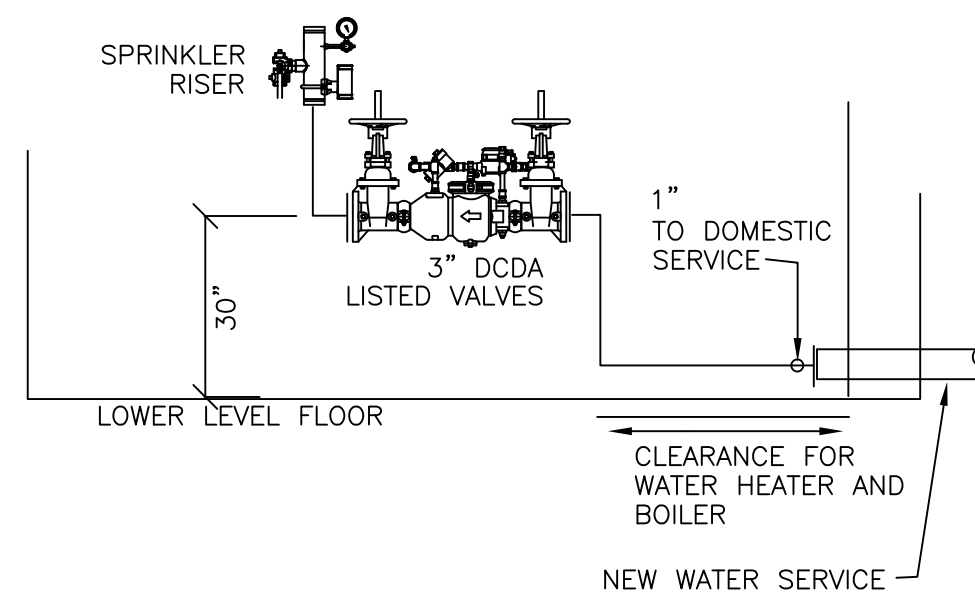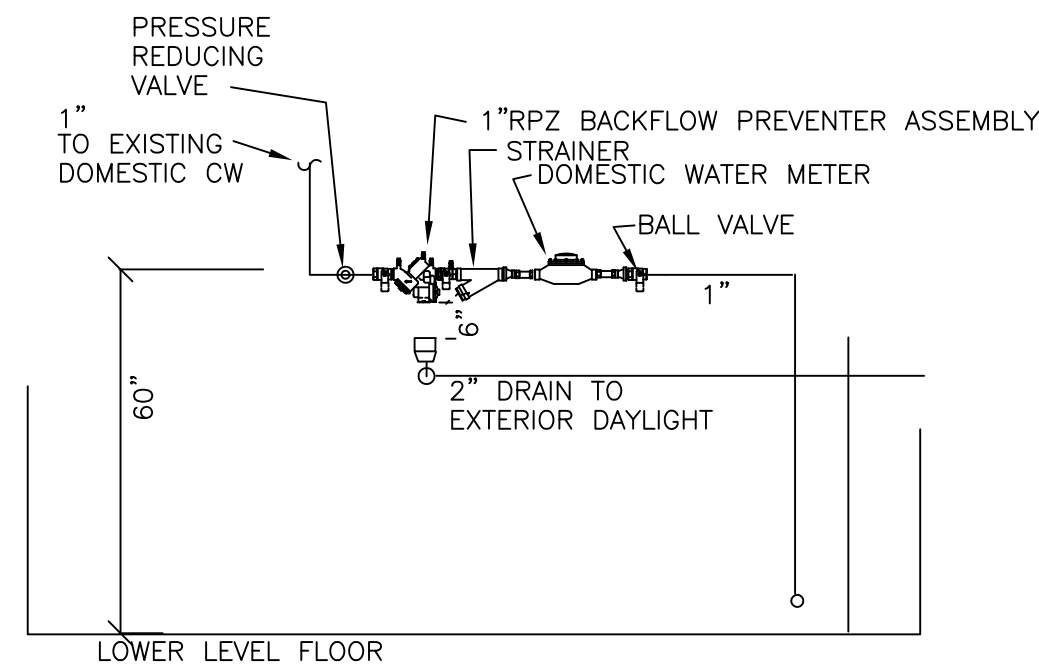


WATER SERVICE - ELEVATION

NOT TO SCALE
COORDINATE WITH EXISTING CONDITIONS

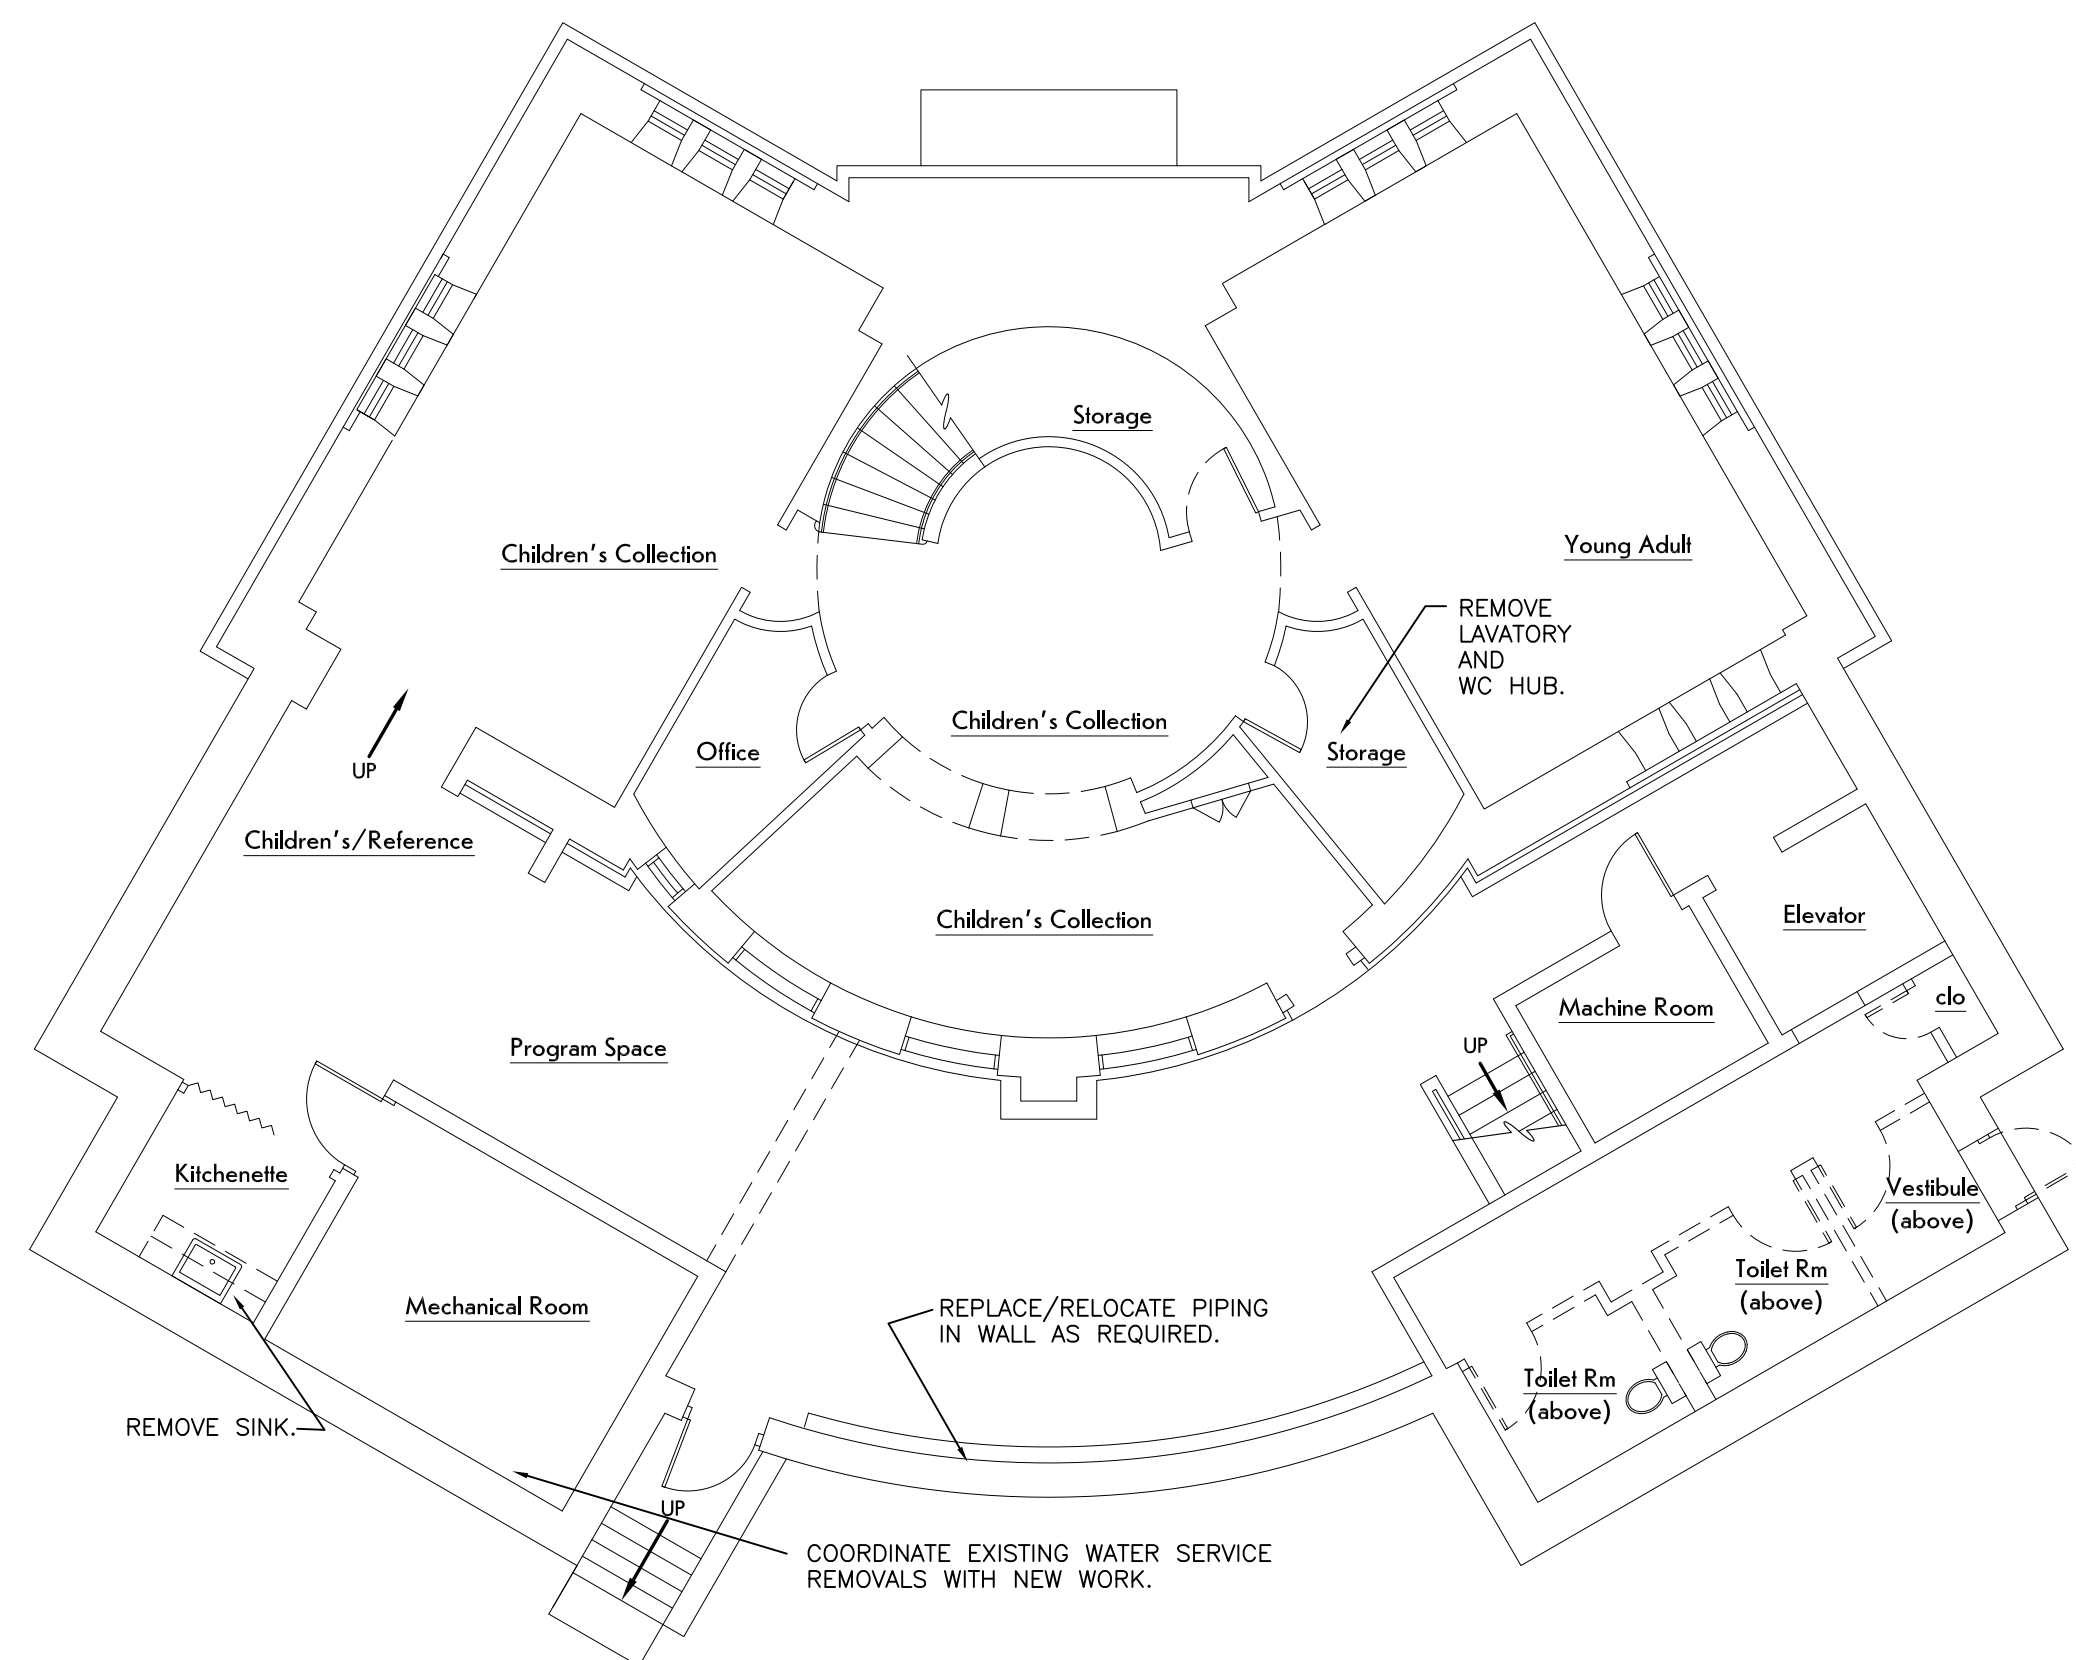


LOWER LEVEL FLOOR PLAN - REMOVALS

1/8" = 1'-0"

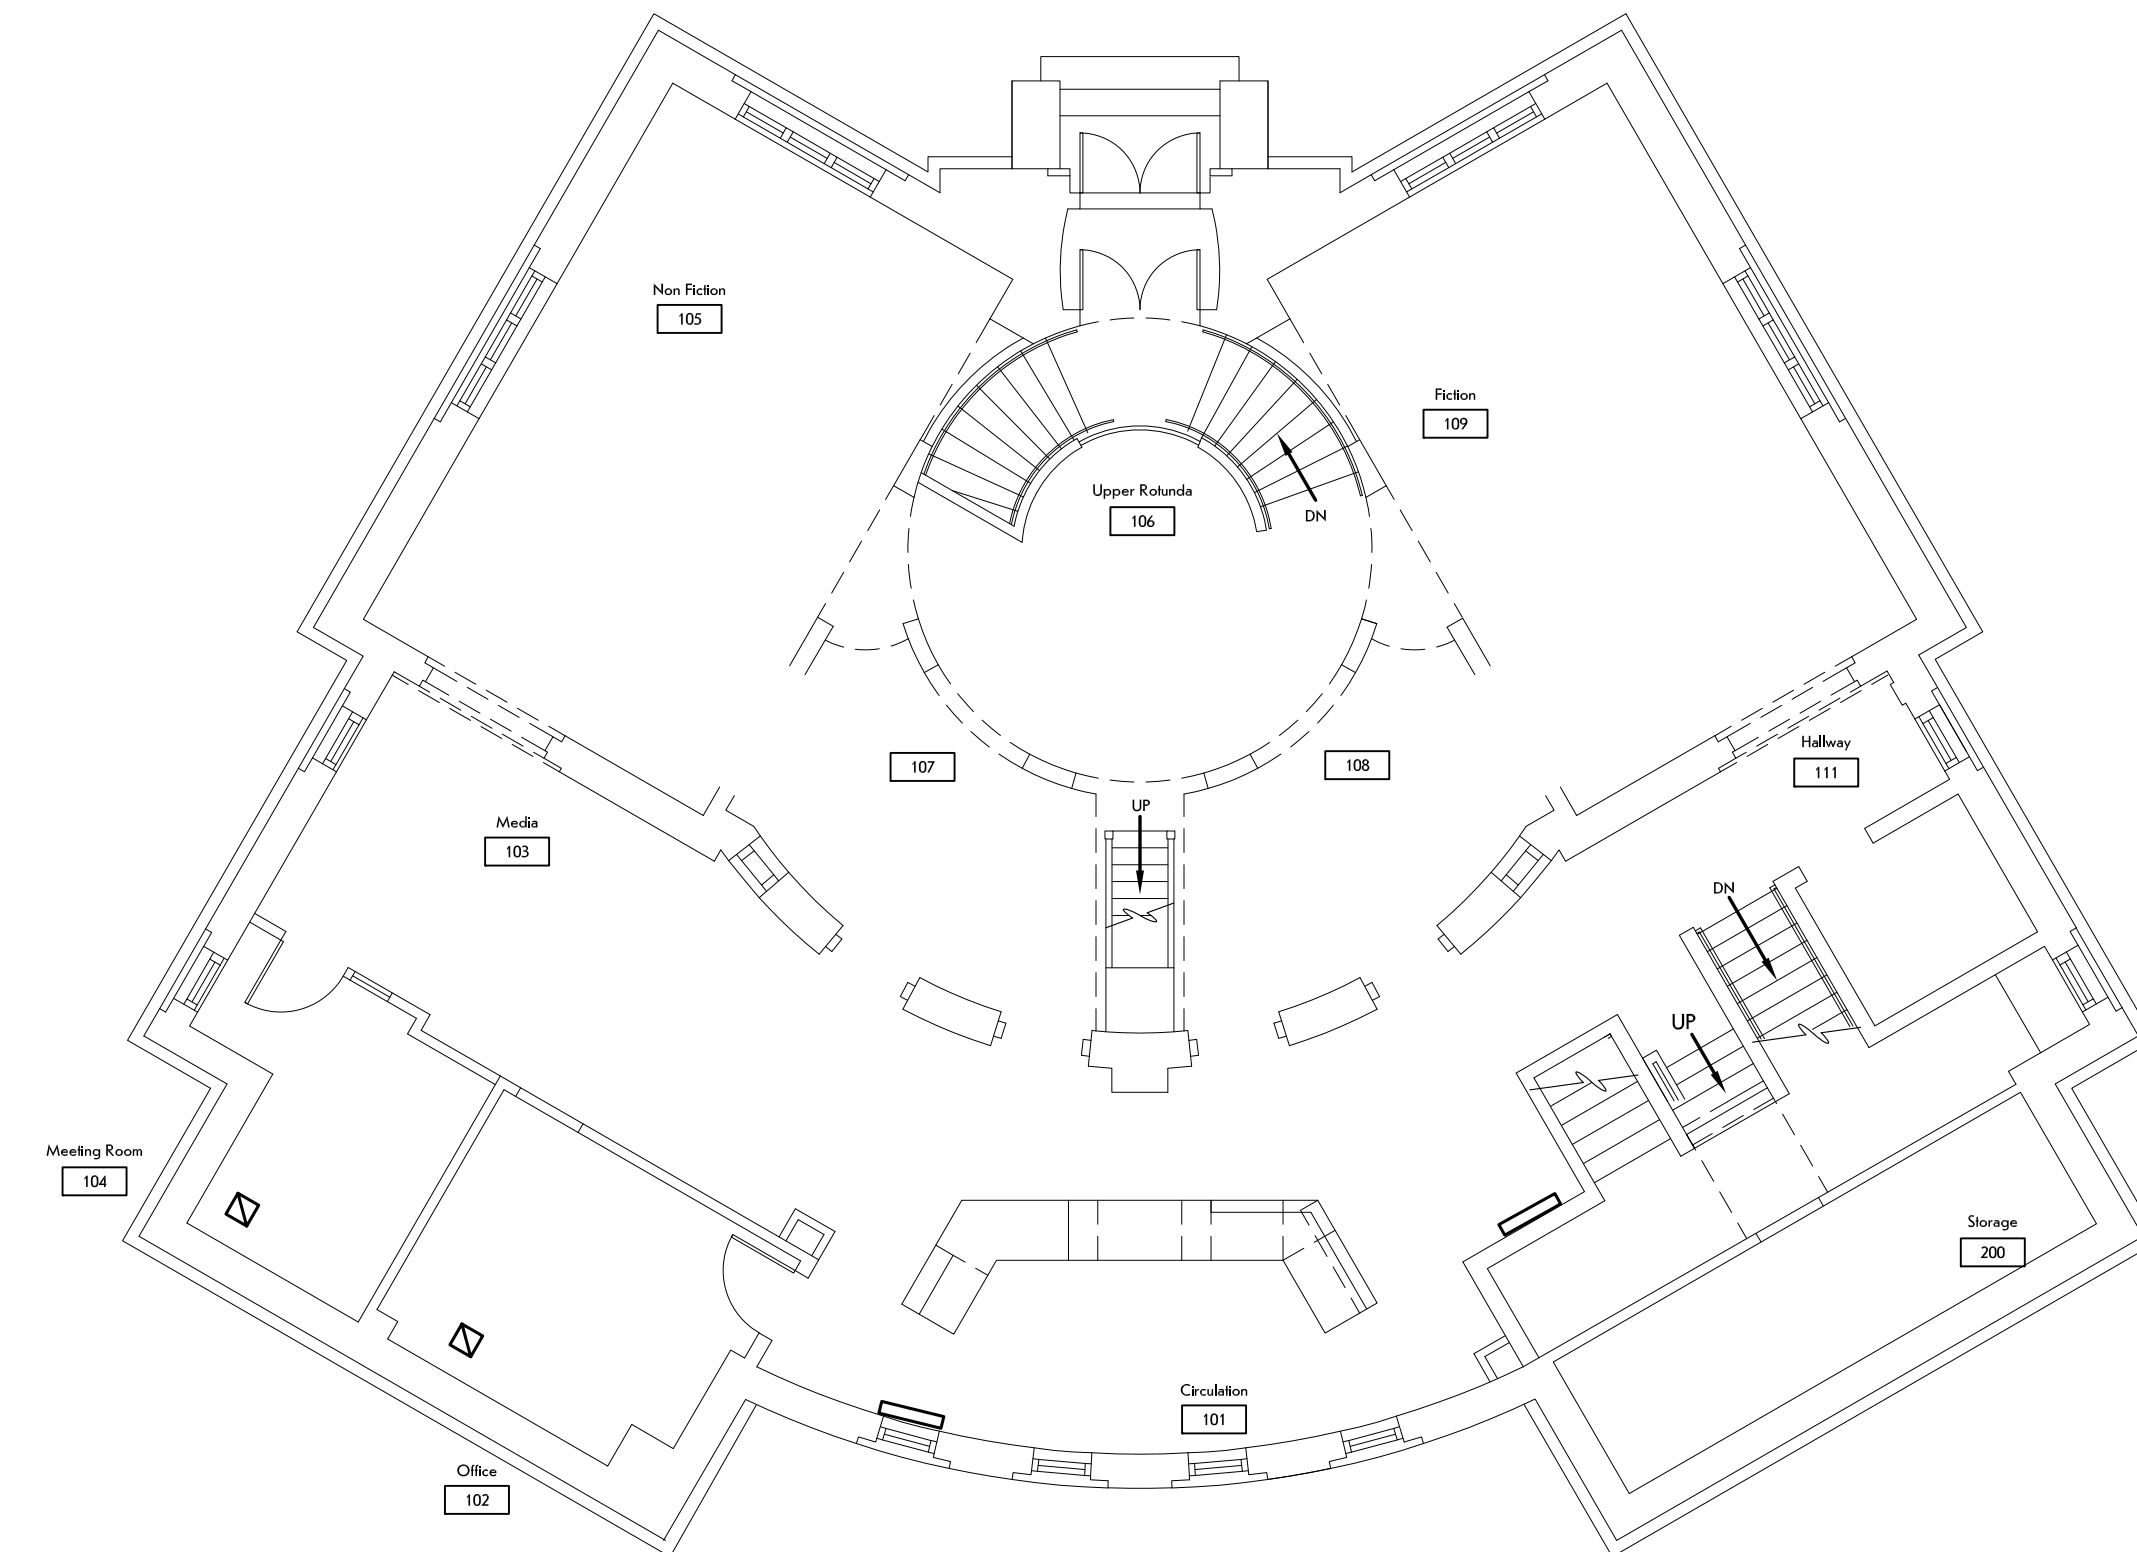

MAIN LEVEL FLOOR PLAN


1/8" = 1'-0"

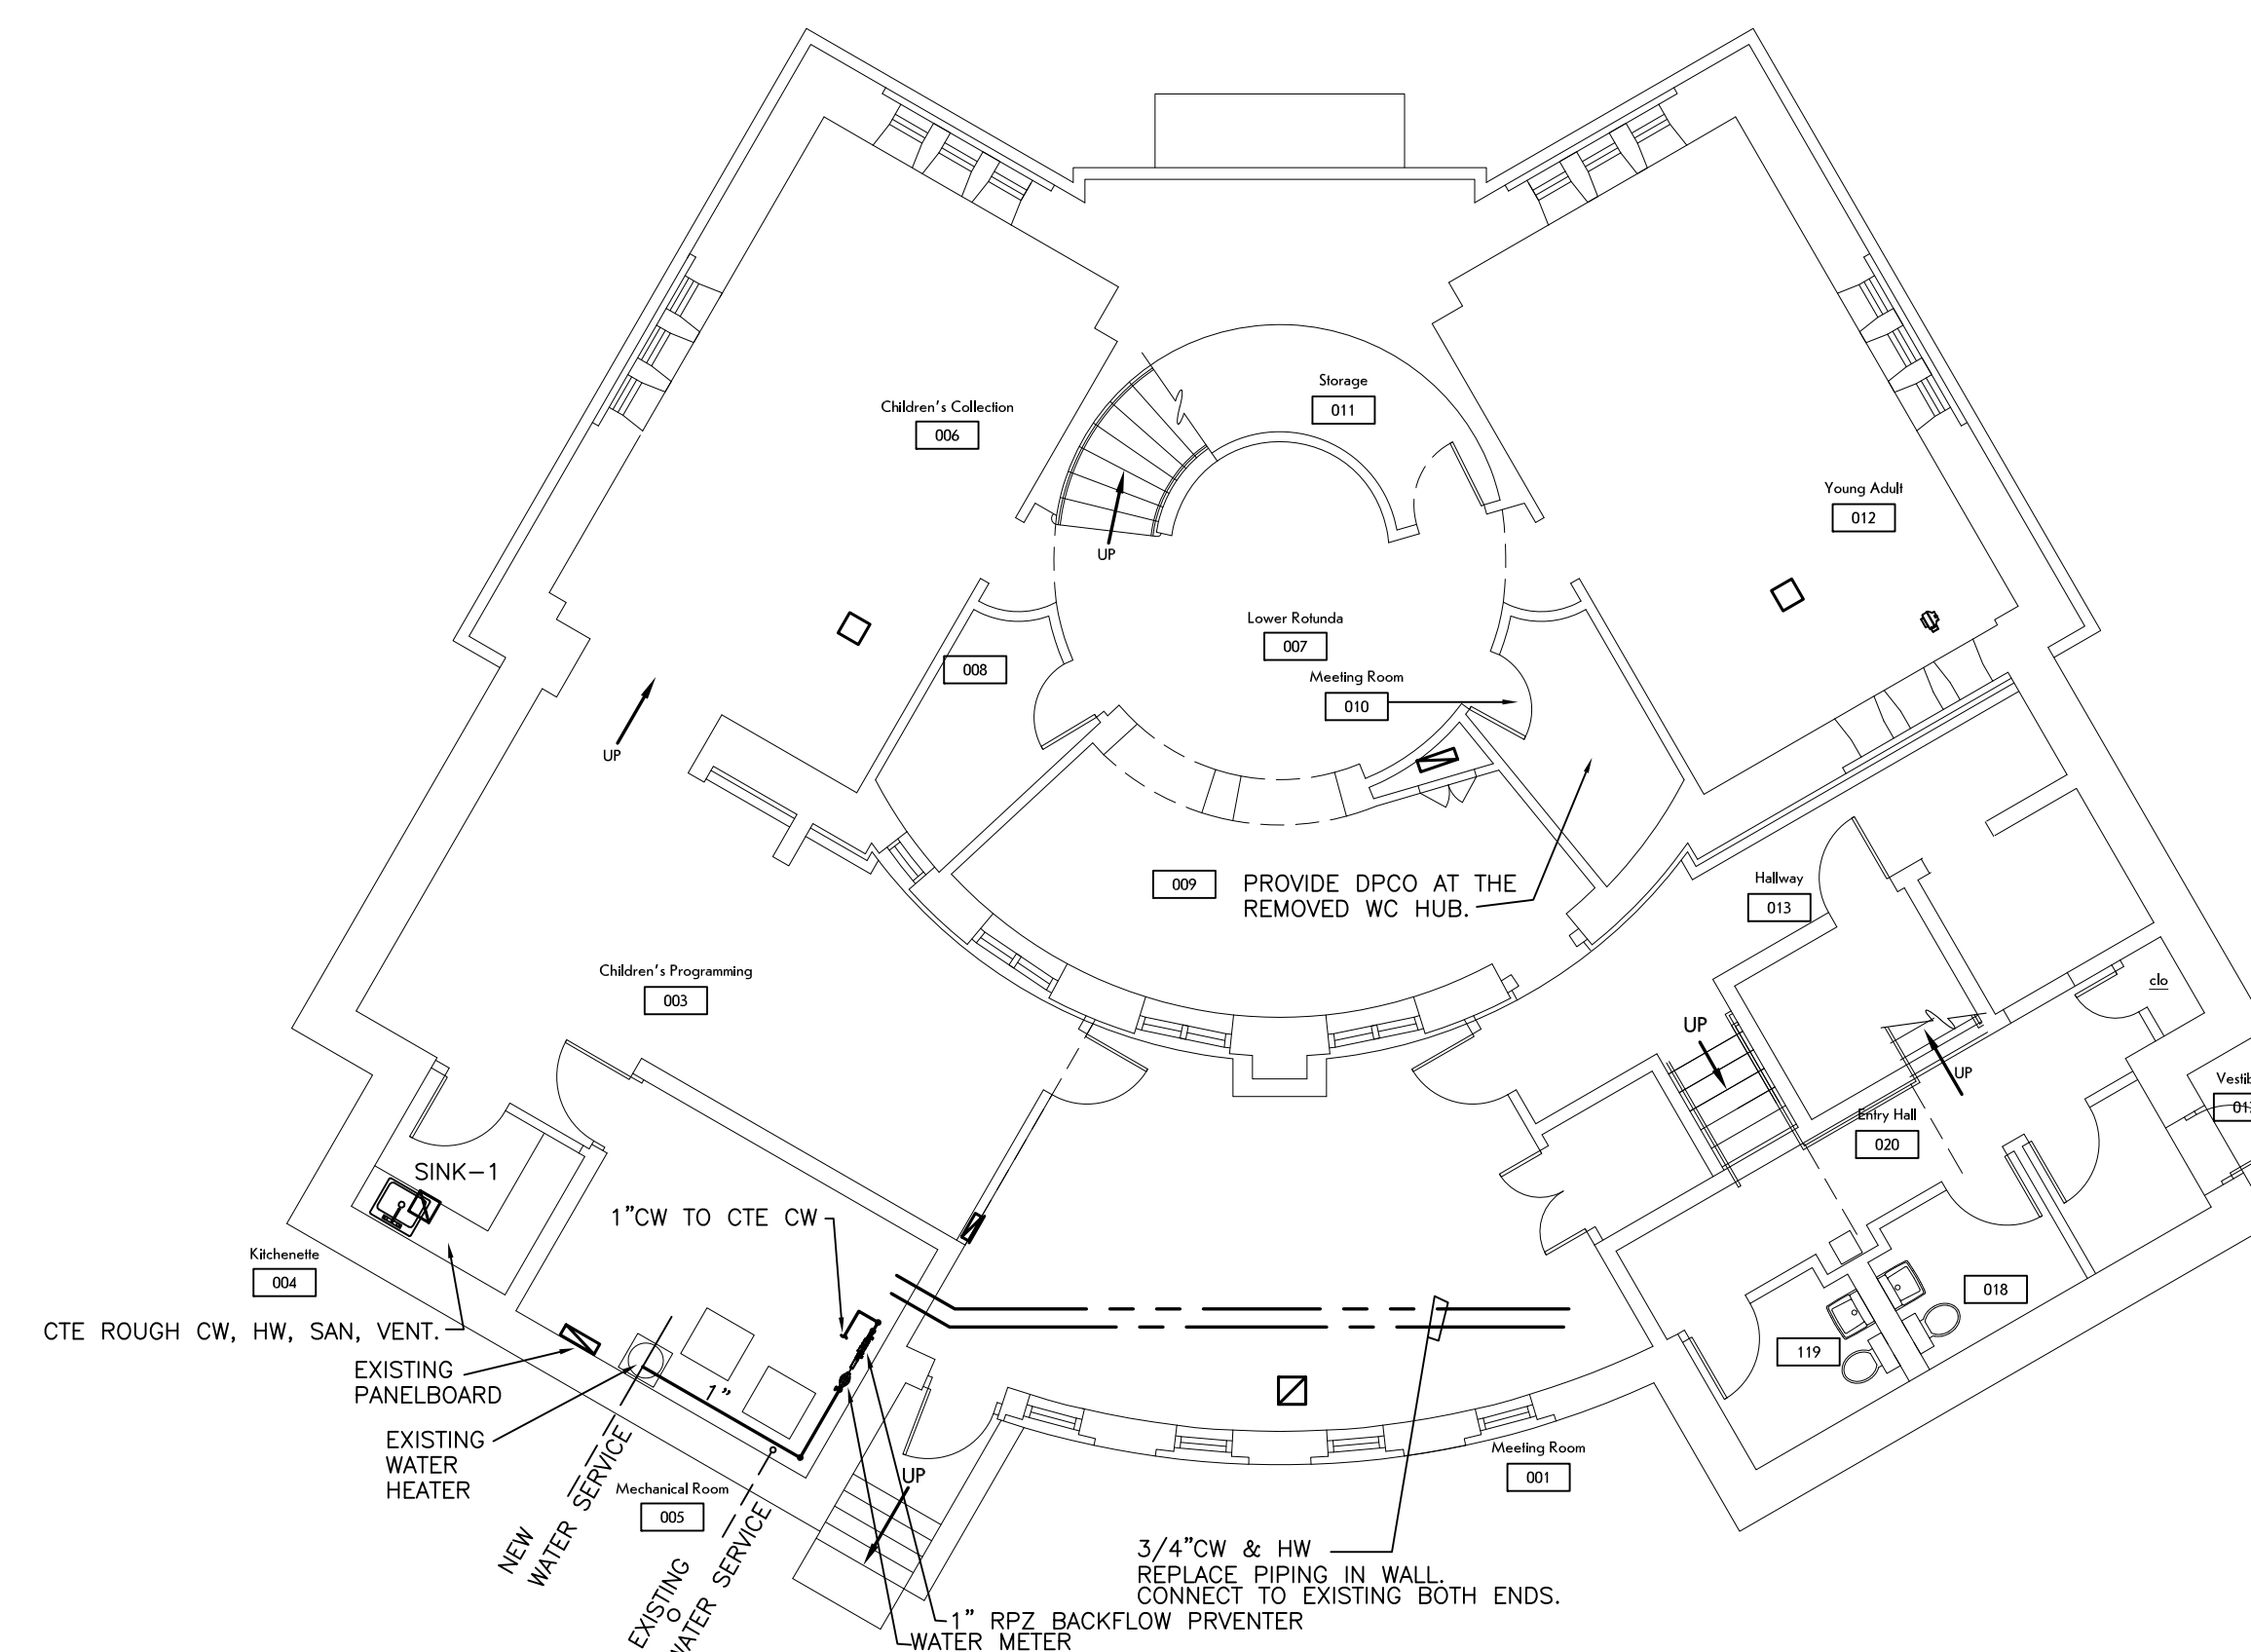

LOWER LEVEL FLOOR PLAN

1/8" = 1'-0"

SHEET SCALE 1" ←→

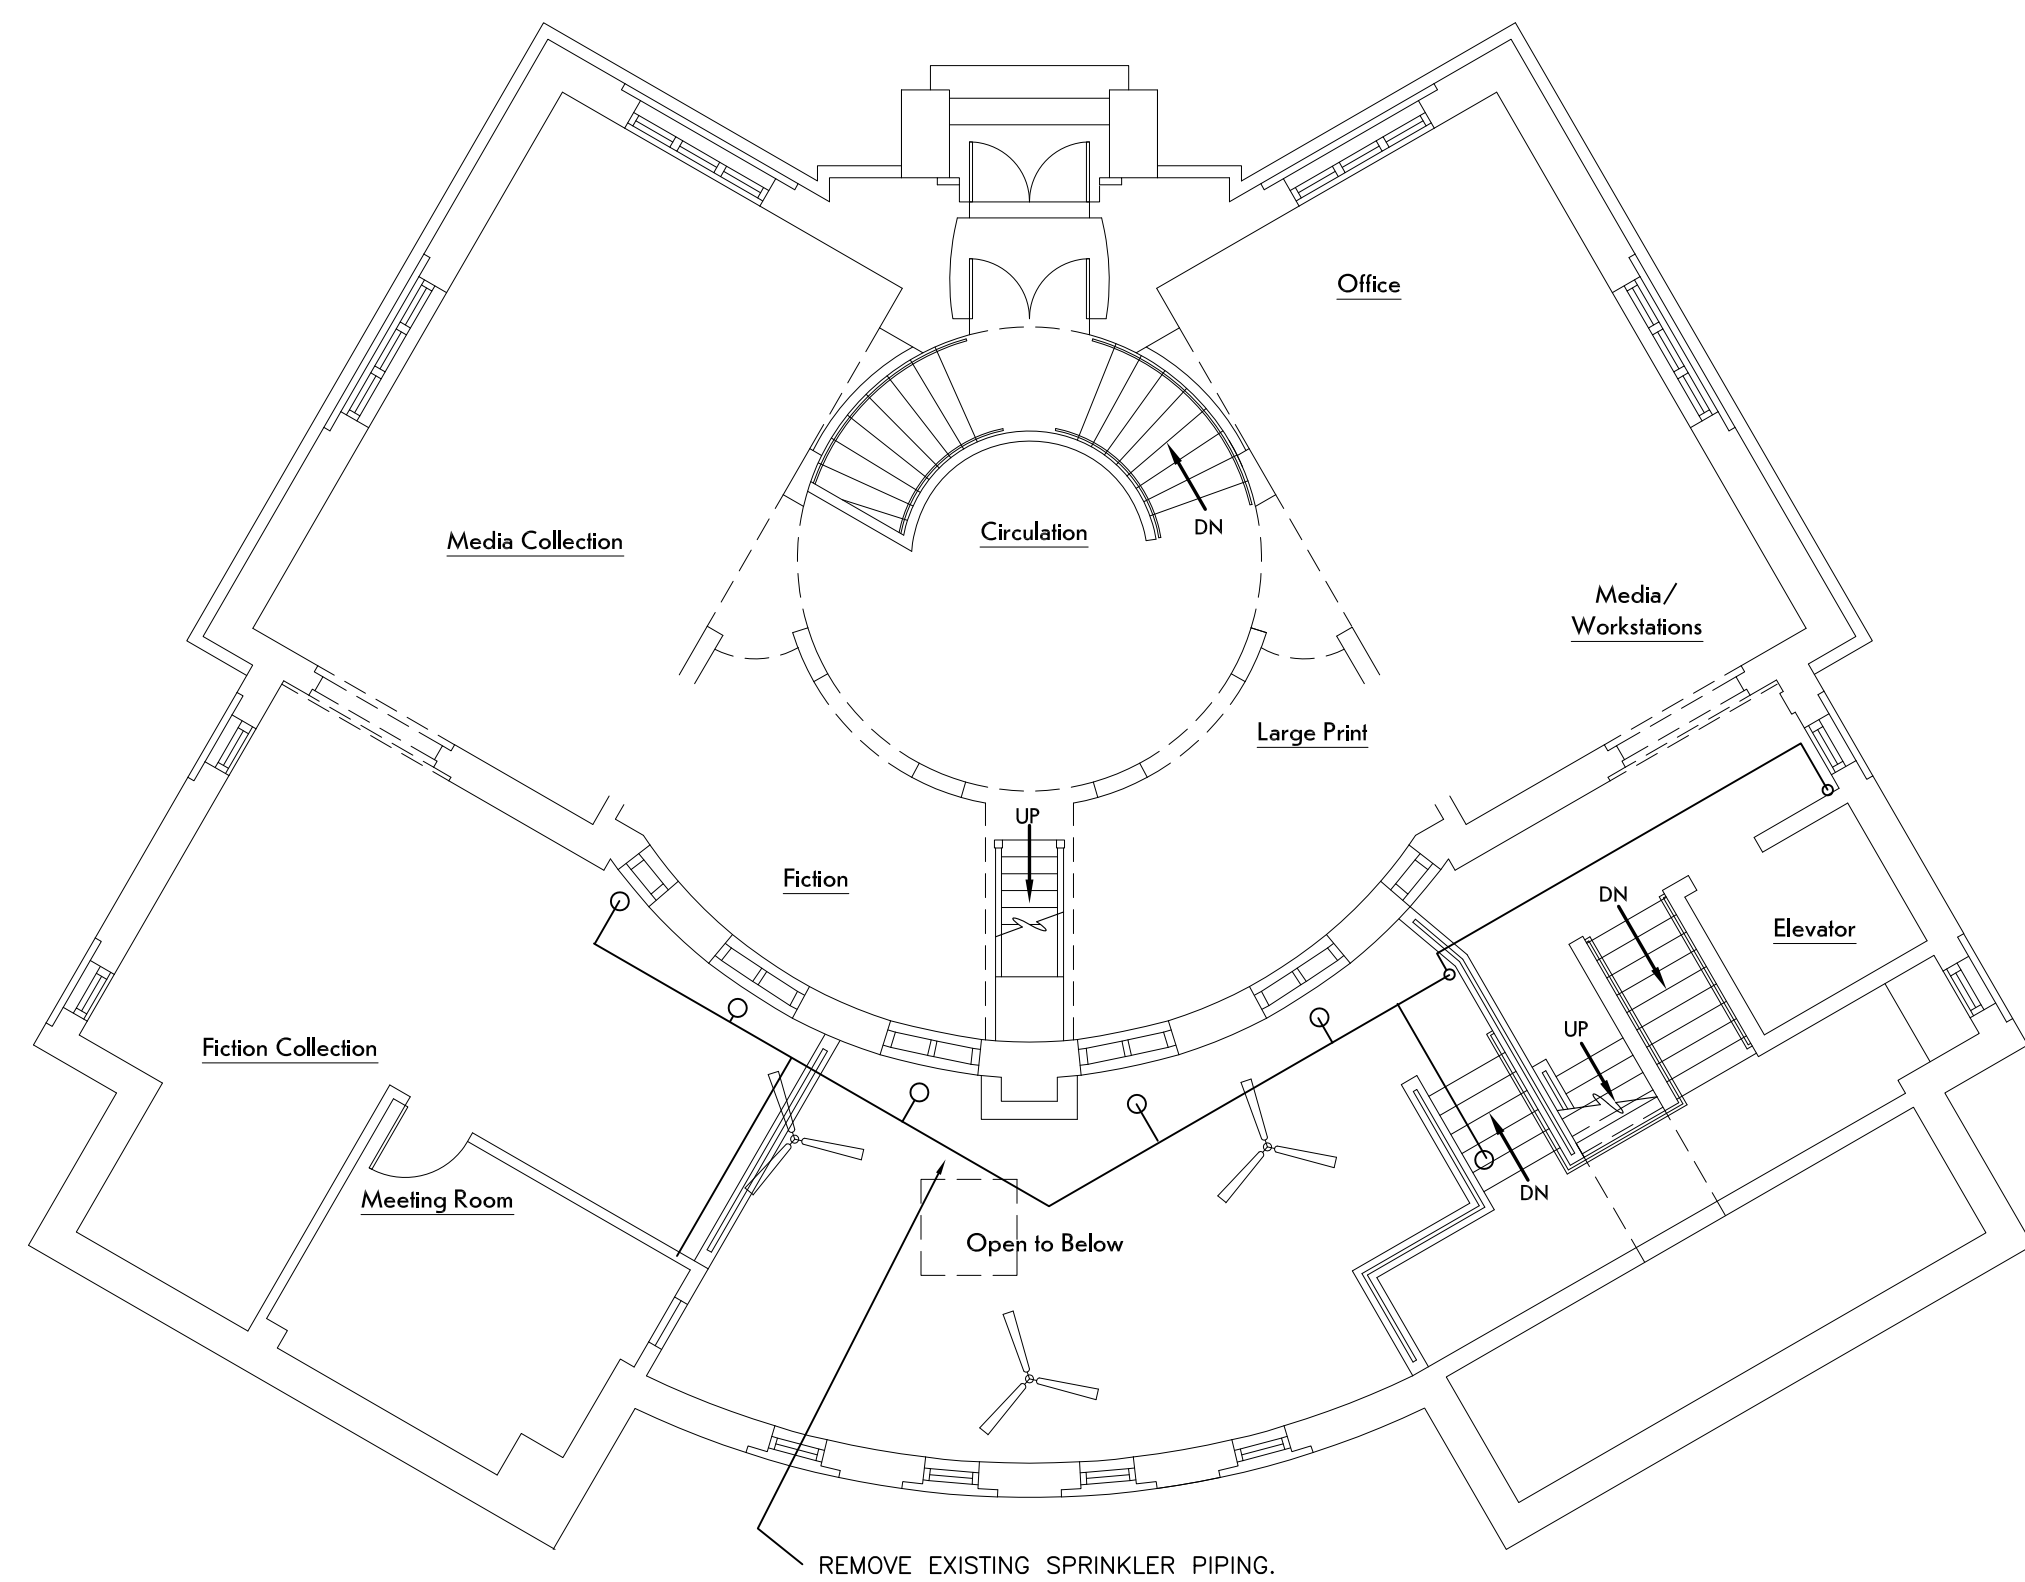

MAIN LEVEL FLOOR PLAN – REMOVALS
1/8" = 1'-0"

REMOVALS

REMOVE THE EXISTING SPRINKLER SYSTEM.

INCLUDES:

CONNECTION TO THE EXISTING WATER SERVICE RISER AND ALARM VALVE
SPRINKLERS AND PIPING (EXISTING SYSTEM WAS INTENDED TO PROTECT THE OPENINGS BETWEEN THE EXISTING BUILDING AND THE 1988 ADDITION.)
TEST CONNECTION

FIRE PROTECTION SPRINKLER

THE NEW SPRINKLER SYSTEM IS FOR THE ADDITION (ADDED FLOOR AREA) INCLUDING THE FLOOR AND EXITS.
THE EXISTING FLOOR AREA UNDER THE ADDITION WILL ALSO BE SPRINKLERED.

BID DRAWINGS ARE INTENDED TO SHOW THE GENERAL SCOPE OF WORK AND ANY SPECIFIC AESTHETIC REQUIREMENTS. THE CONTRACTOR SHALL PROVIDE A COMPLETE WORKING SYSTEM. THE CONTRACTOR SHALL BASE PIPE SIZES ON THE CONTRACTOR HYDRAULIC CALCULATIONS. THE CONTRACTOR SHALL BASE SPRINKLER LAYOUT ON THE ARCHITECTURAL AND STRUCTURAL BUILDING PLANS AND DETAILS. PROVIDE COMPLETE SYSTEMS PER NFPA 13 AND AS REQUIRED BY THE BUILDING CODE OF NEW YORK STATE.

SIZE THE PIPING AND SPRINKLERS AS REQUIRED BY THE AVAILABLE WATER PRESSURE AND FLOW.

LIGHT HAZARD (ANY BOOK SHELVES <math>\leq 8\text{ FT}>, > 30''\text{ APART}>)

CONTRACTOR SHALL PREPARE SHOP DRAWINGS. DRAWINGS TO MEET NFPA 13 DEFINITION OF WORKING DRAWINGS FOR SUBMISSION TO THE AHJ.

THE CONTRACTOR SHALL PROVIDE ALL INFORMATION FOR THE PERMIT. CERTIFICATION (PE STAMP OR OTHERWISE) OF THE SHOP DRAWINGS AS REQUIRED BY THE AHJ SHALL BE THE RESPONSIBILITY OF THE CONTRACTOR.


1. PROVIDE COMPLETE HYDRAULICALLY DESIGNED SYSTEM INCLUDING ALL ACCESSORIES REQUIRED BY NFPA 13.
2. COORDINATE WITH OTHER TRADES. PROVIDE PIPING AND SPRINKLERS TO AVOID BUILDING COMPONENTS. PROVIDE ADDITIONAL SPRINKLERS TO COVER AROUND OBSTRUCTIONS. REFER TO ALL THE BUILDING DRAWINGS.
3. PIPING SIZE TO BE 1" MINIMUM OR SAME AS PIPE DOWN-STREAM UNLESS OTHERWISE NOTED. PROVIDE 1" CONNECTIONS TO SPRINKLER HEADS (UNLESS OTHERWISE NOTED) INCLUDING SPRINKLER HEADS UNDER OBSTRUCTIONS.
4. ALL COMPONENTS SHALL BE LISTED.
5. PROVIDE FIRE-STOPPING AT PIPE PENETRATION OF FLOORS, MASONRY WALLS, DRYWALL CEILINGS, AND RATED WALLS AND PARTITIONS.
6. PROVIDE FLOW SWITCHES. PROVIDE TAMPER SWITCHES ON VALVES. PROVIDE AUDIO-VISUAL EXTERIOR ALARM.
7. PROVIDE DCDA BACKFLOW PREVENTER ASSEMBLY. COORDINATE THE WATER SERVICE.
8. PROVIDE MEANS FOR FORWARD TEST OF THE BACKFLOW PREVENTER SIZED FOR THE DESIGN FLOW. PROVIDE VALVE AND HOSE CONNECTION FOR THIS.
9. PROVIDE FIRE DEPARTMENT CONNECTION AS REQUIRED BY THE LOCAL FIRE DEPARTMENT. PROVIDE SIGN DESIGNATING THE AREA SERVED.

ALTERNATES


F2 PROVIDE SPRINKLERS IN CEILING CLOUDS (ALTERNATE CEILING OVER THE NEW RECEPTION DESK).

KEY NOTES

- A SPRINKLER FOR CEILING BETWEEN STACKS BELOW MEZZANINE FLOOR. RUN PIPING IN MEZZANINE AS UNOBTRUSIVELY AS POSSIBLE. PROVIDE PROTECTIVE CAGES ON SPRINKLERS.
- B ACCESS TO ATTIC – LEAVE CLEAR.

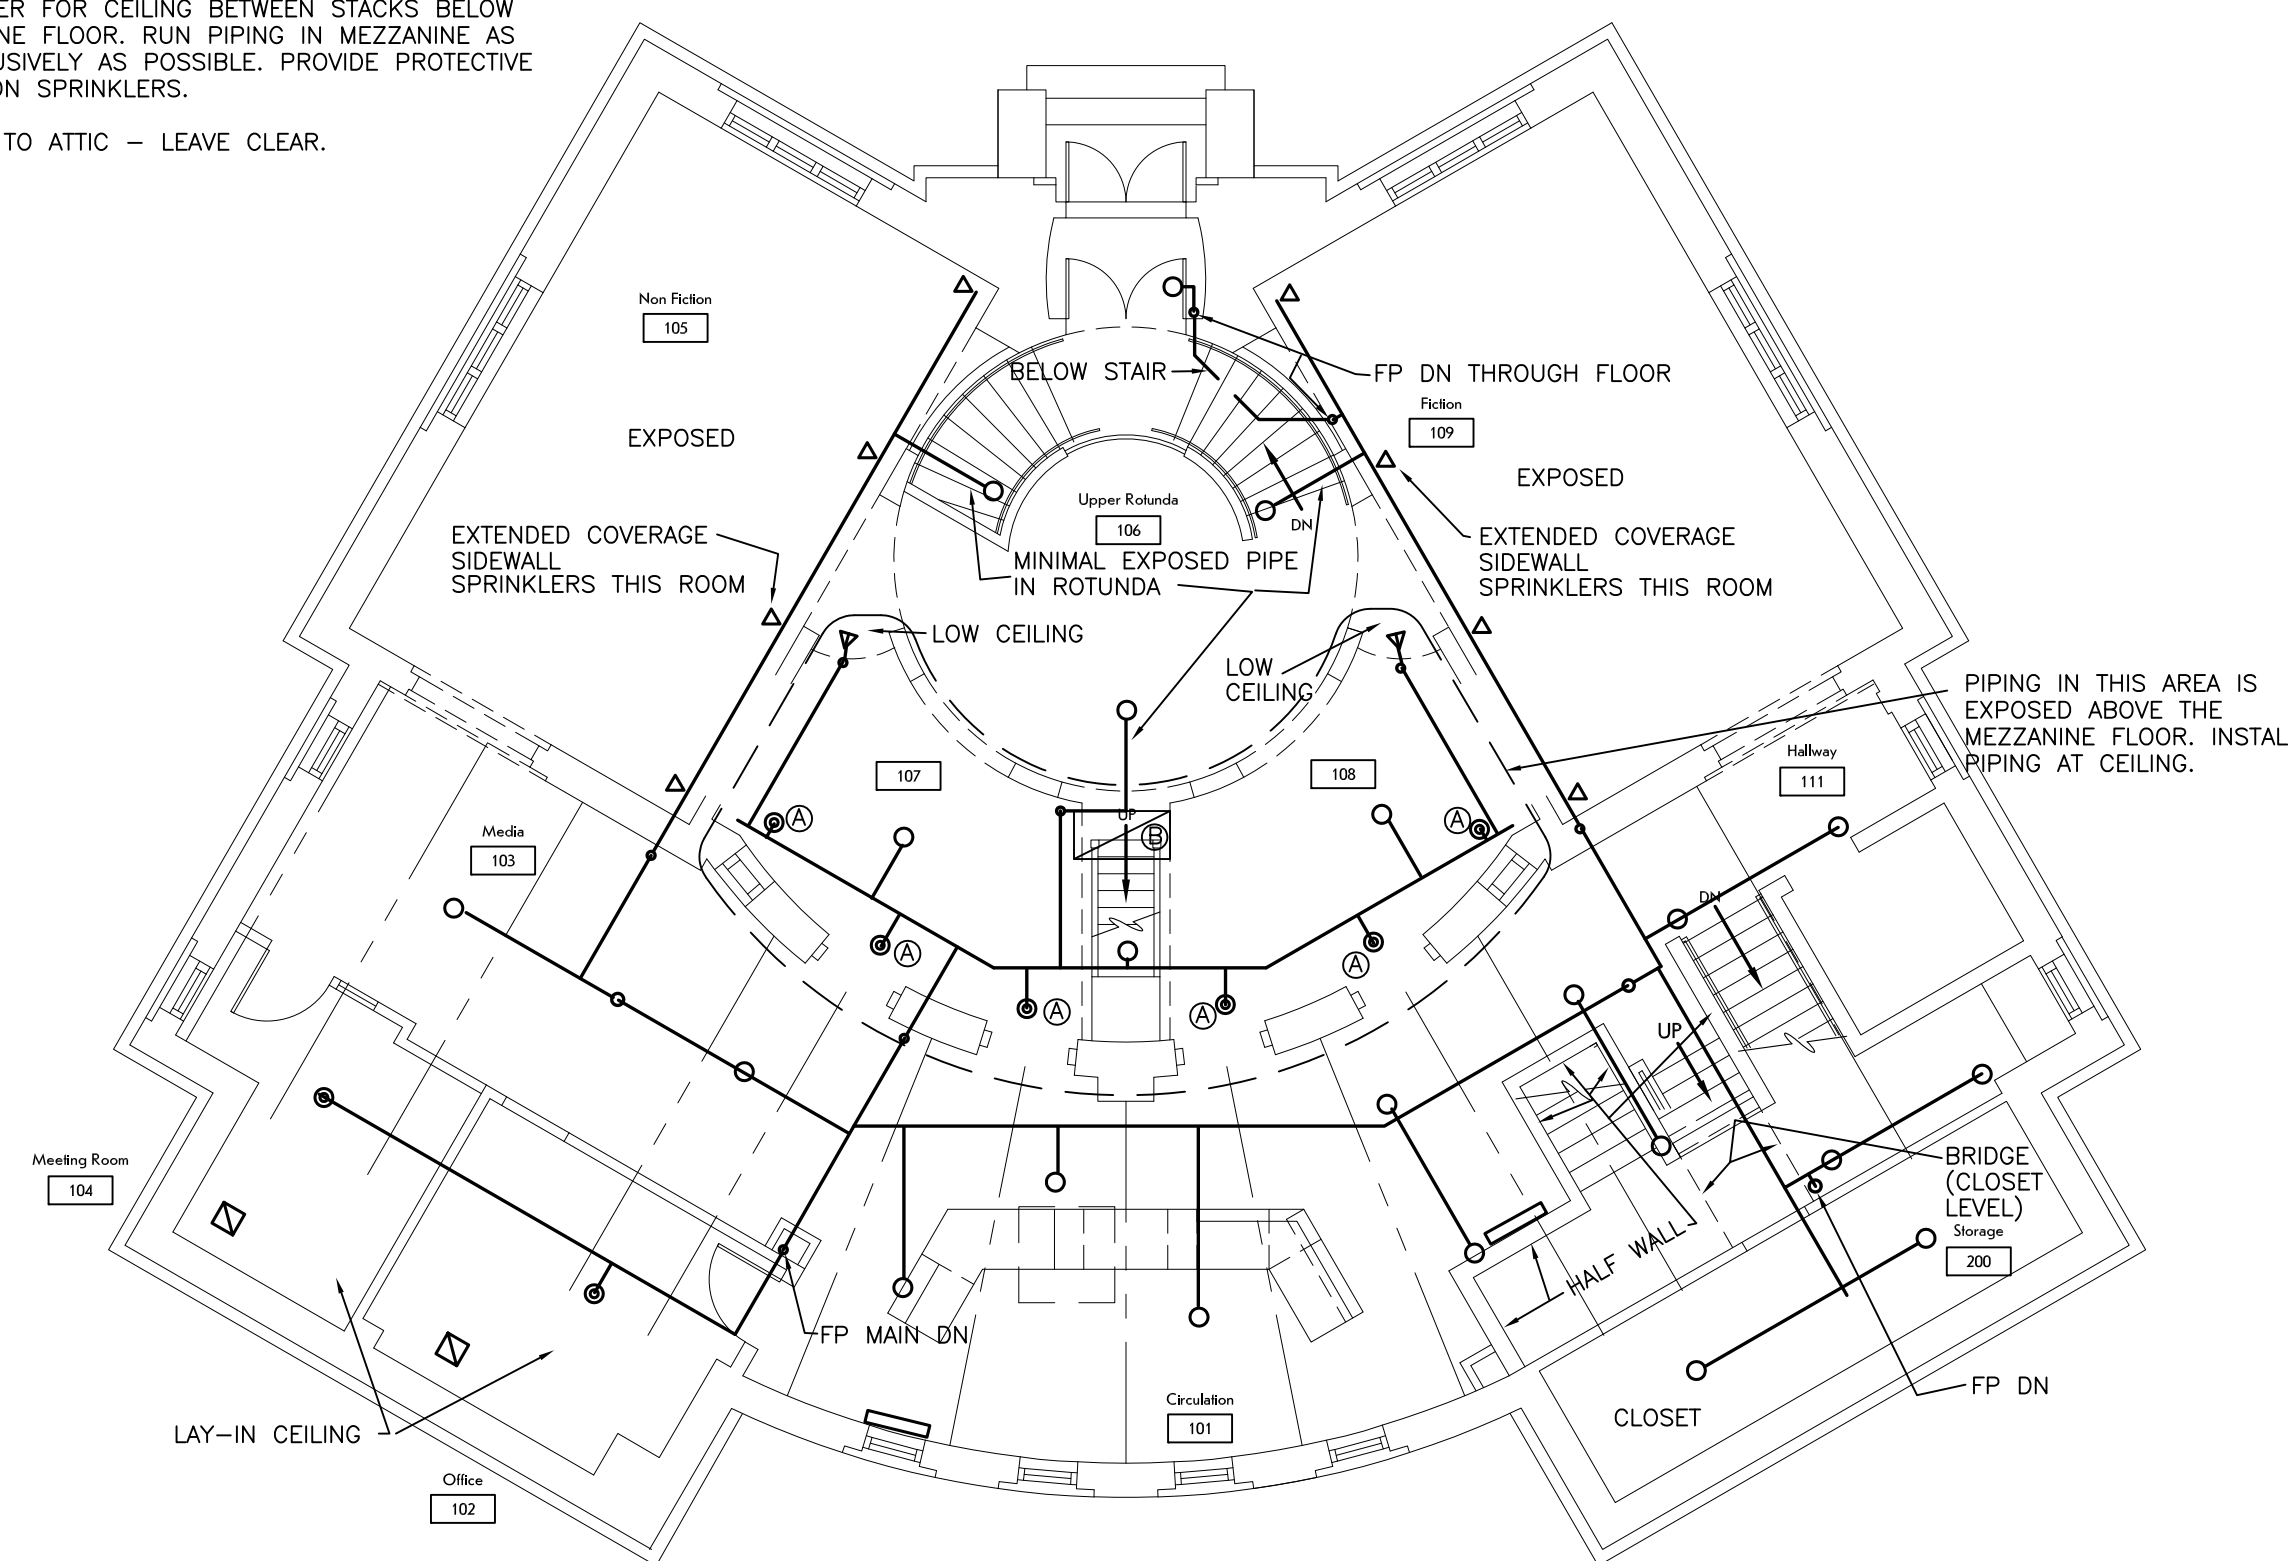

MAIN LEVEL FLOOR PLAN
1/8" = 1'-0"

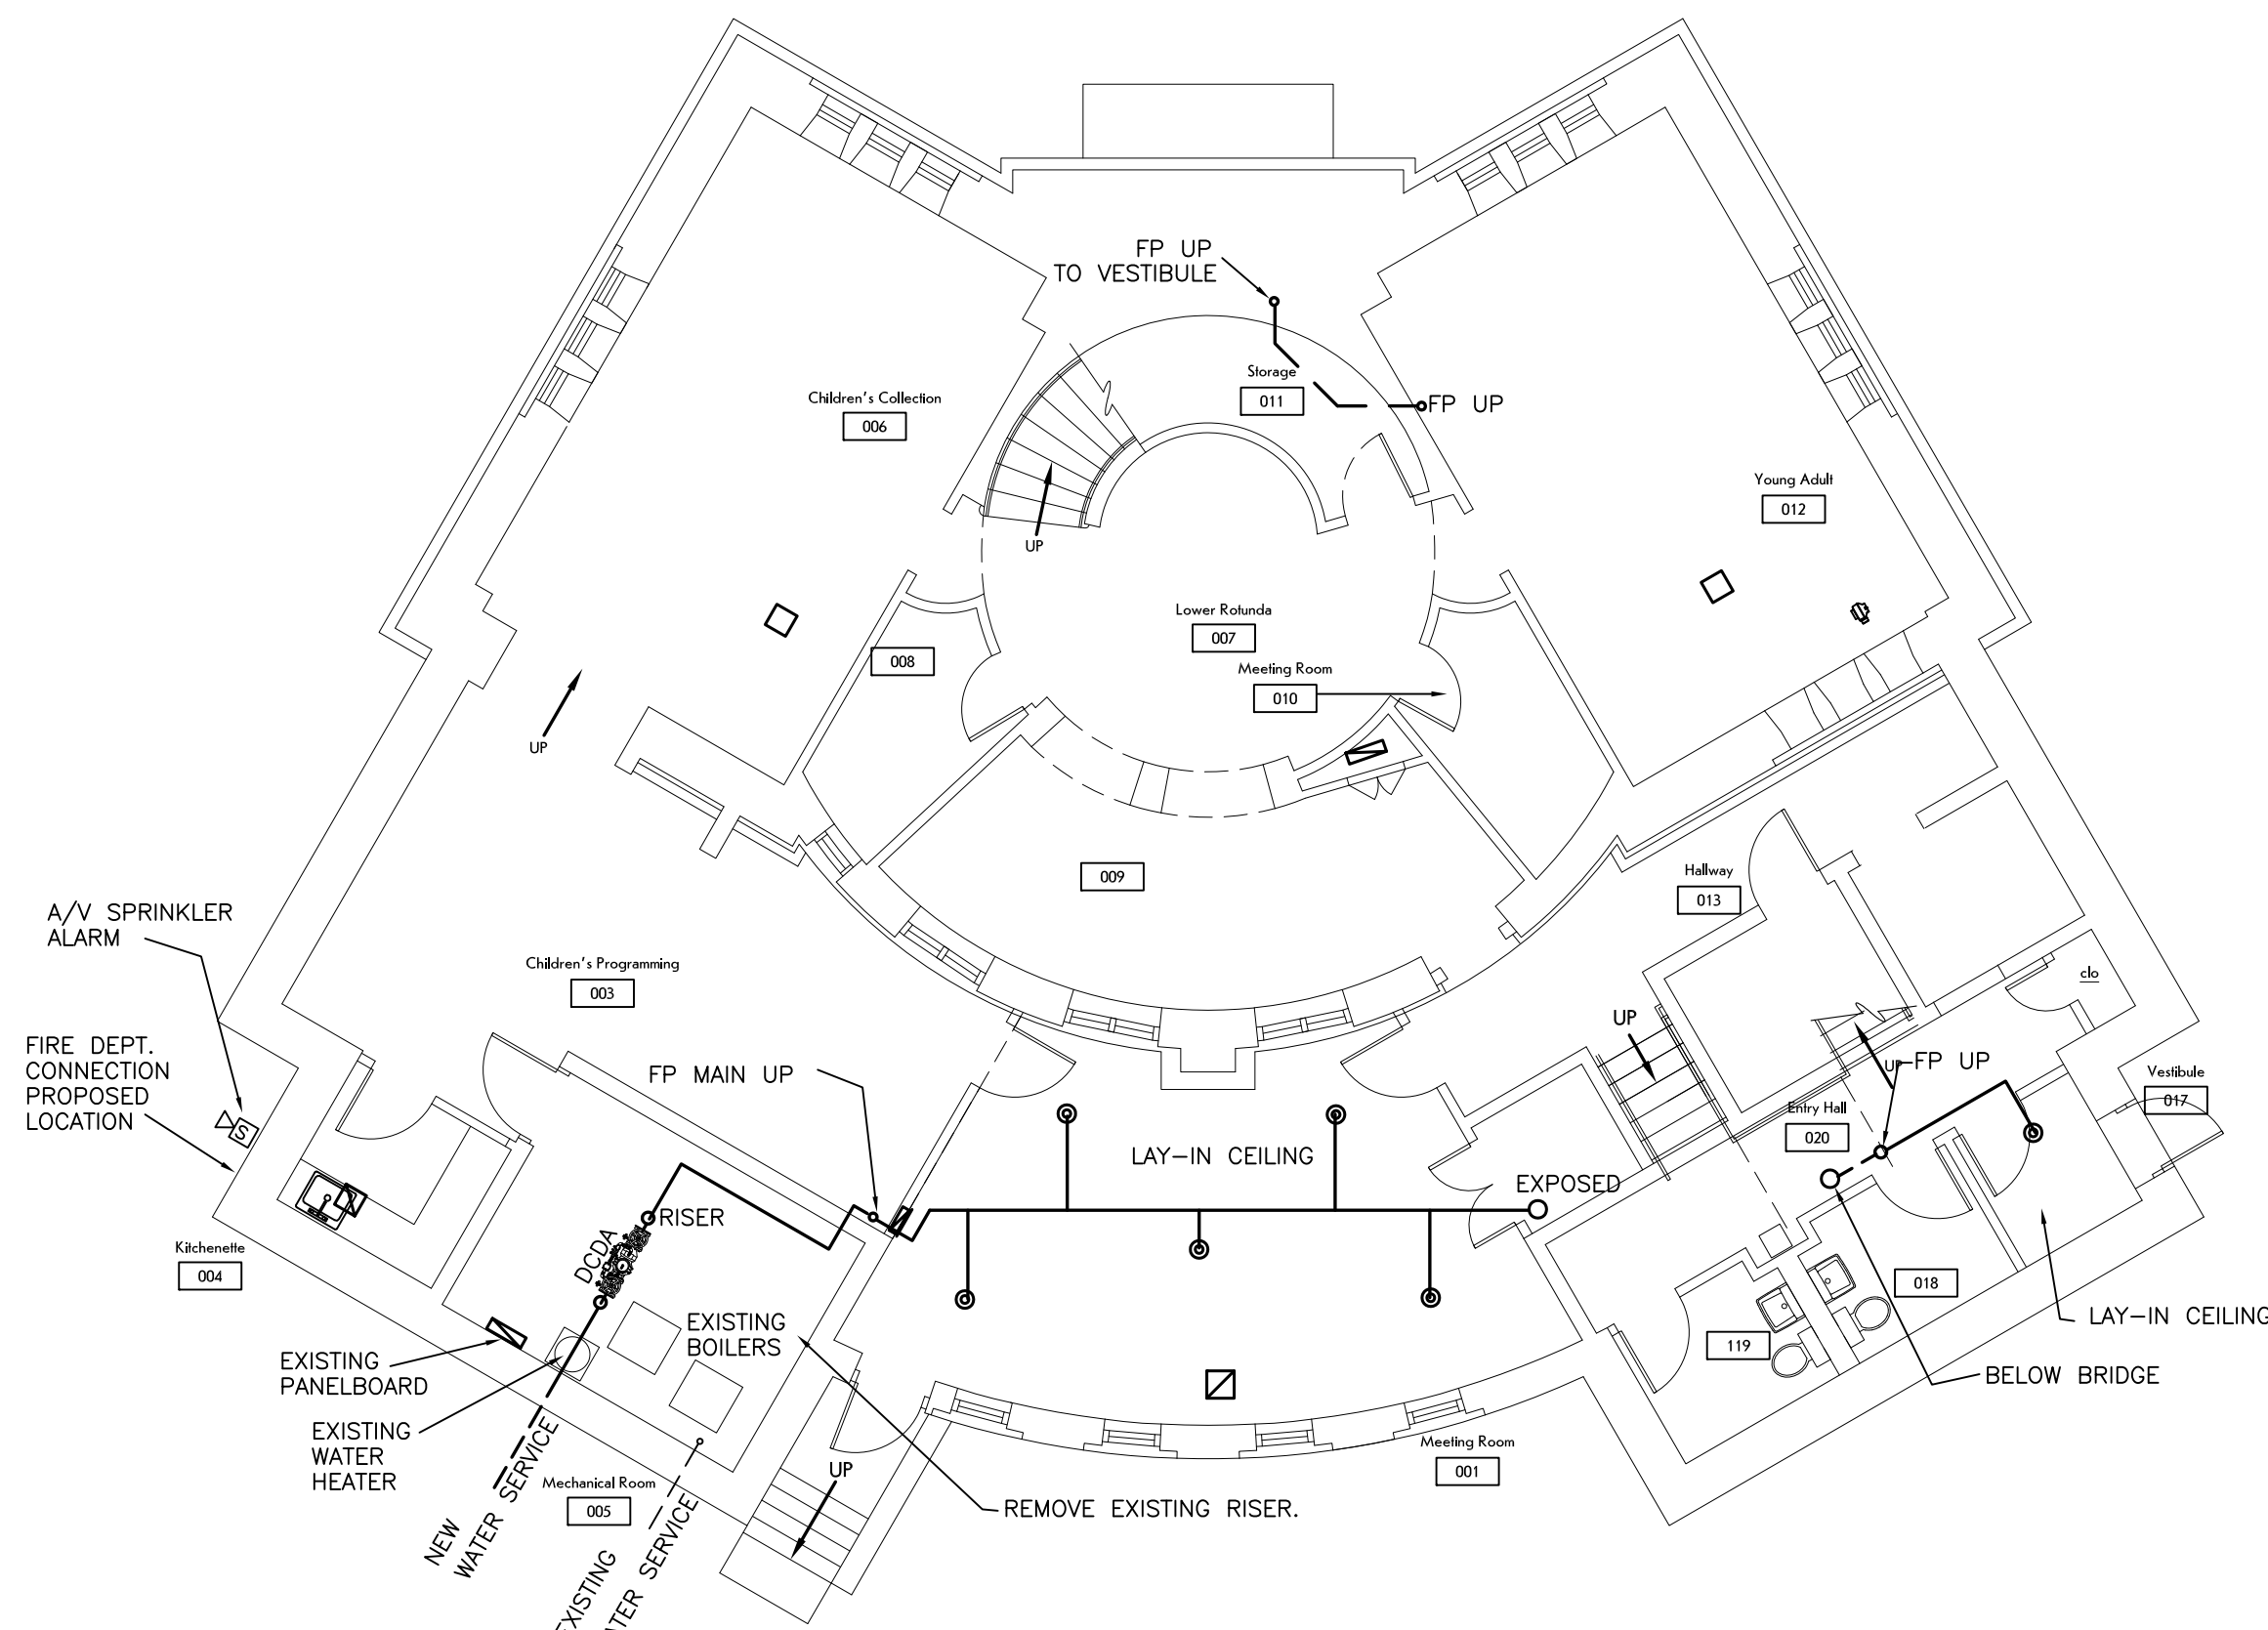

LOWER LEVEL FLOOR PLAN
1/8" = 1'-0"

SHEET SCALE 1" ← →



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83 Center Street
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Design Development
Warsaw Public Library
130 North Main Street, Warsaw, New York

PROJECT NUMBER: 22120

ISSUE DATE: 2/21/2024


DRAWN BY: CWE

SHEET TITLE:

FIRE PROTECTION
SPRINKLER

SHEET NUMBER:

F-10

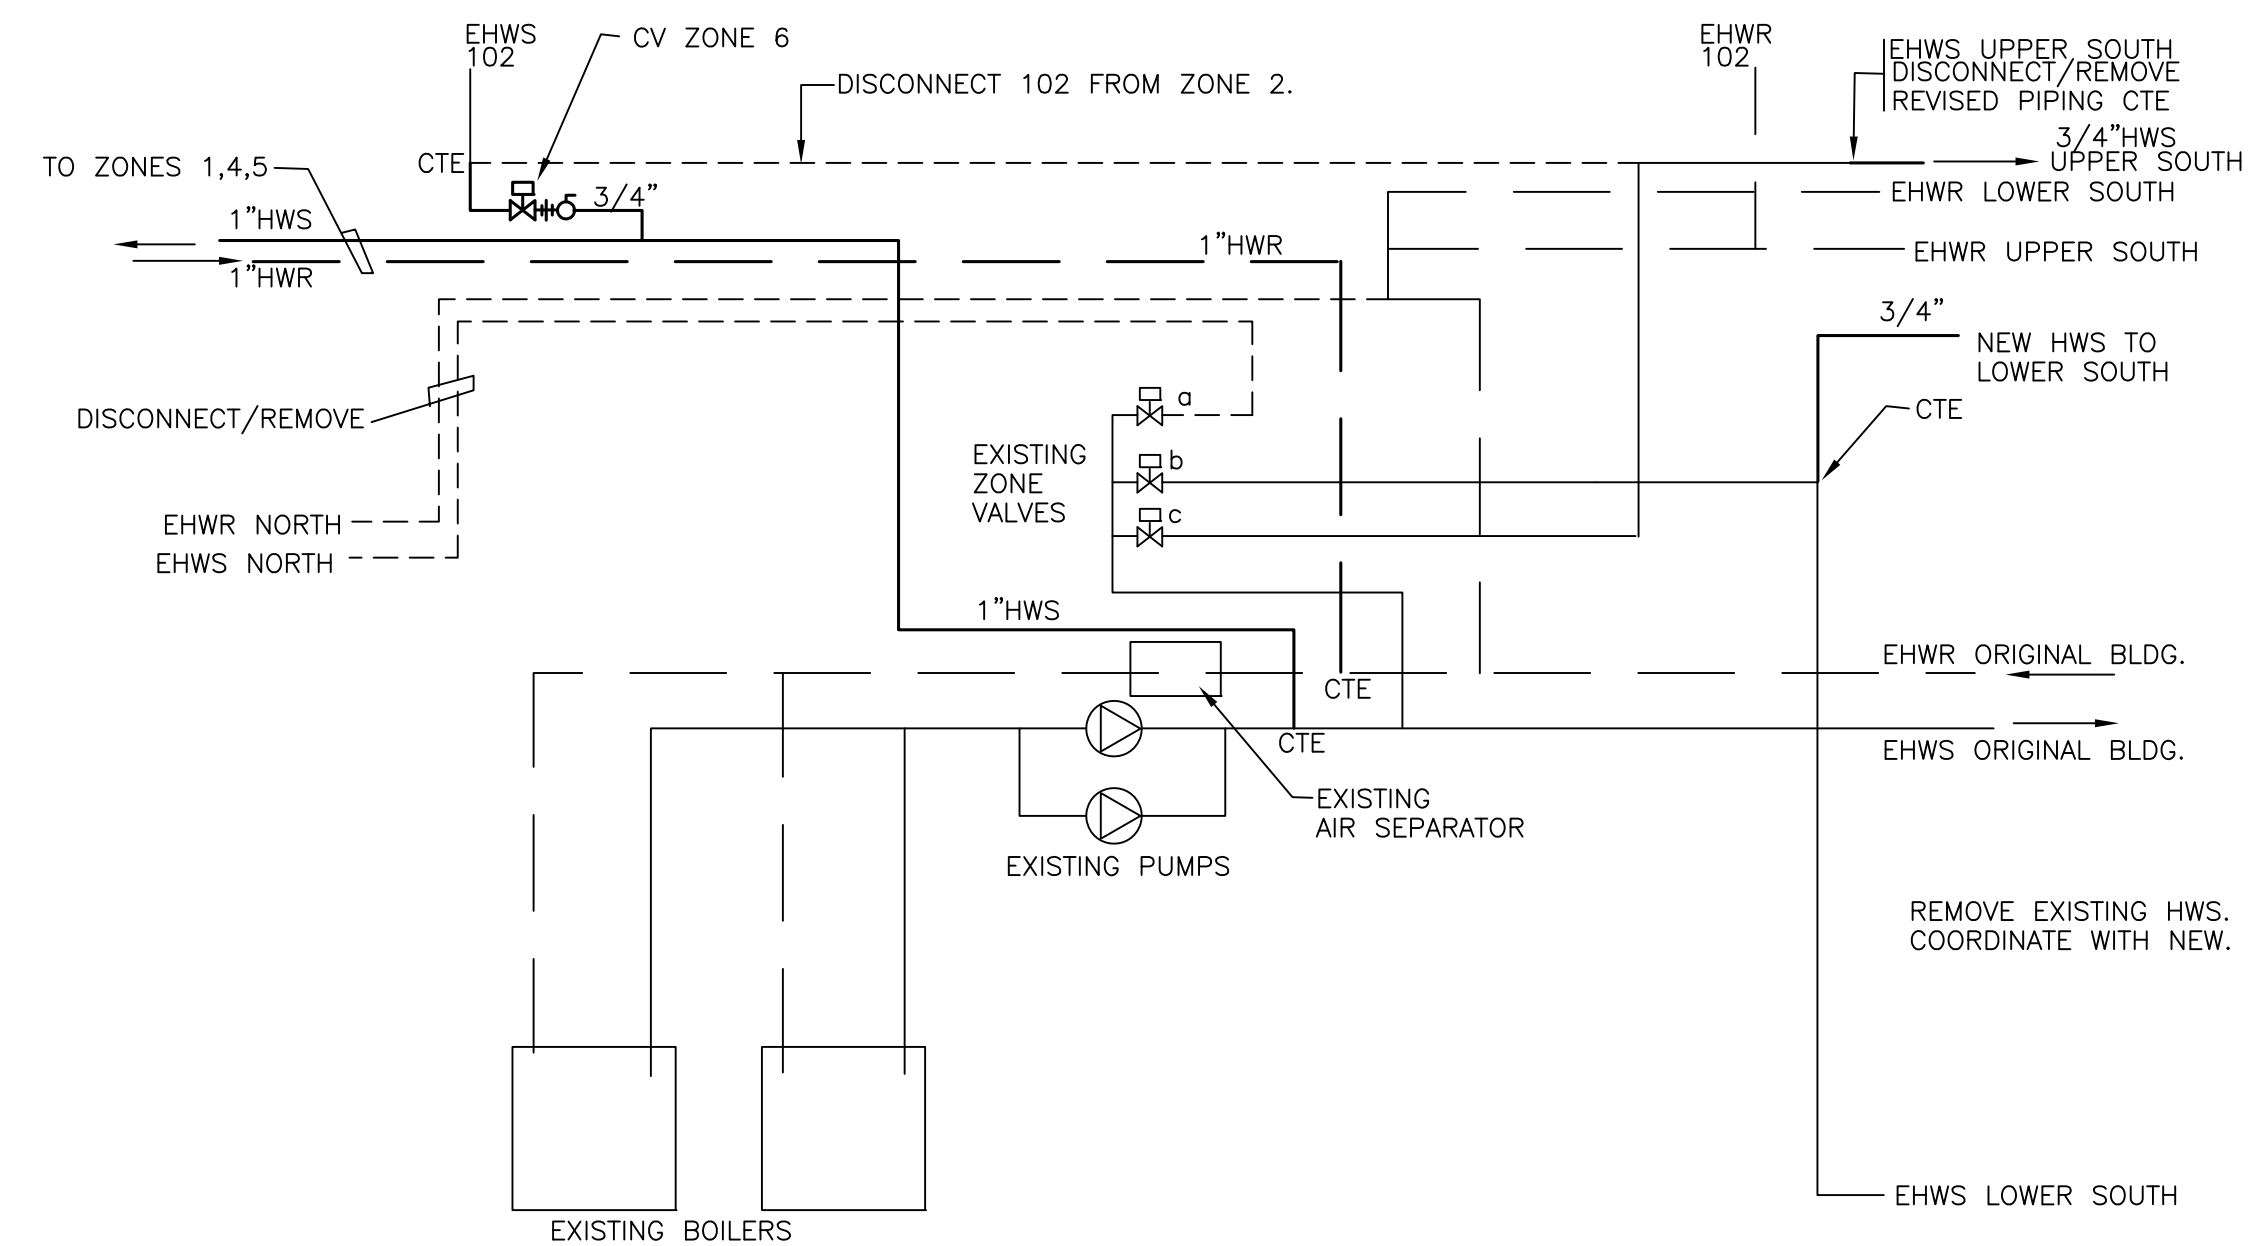

BOILER ROOM PIPING SCHEMATIC

NOT TO SCALE.
 VERIFY PIPING IN FIELD. - THE EXISTING ZONE VALVES MAY BE MIS-LABELED
 EHWS - EXISTING HOT WATER SUPPLY
 EHRW - EXISTING HOT WATER RETURN

- a ZONE 1 - REMOVE
- b ZONE 3 - SOUTH LOWER
- c ZONE 2 - SOUTH UPPER

NOTES - HVAC

- INSULATE NEW SUPPLY AIR DUCT. EXCEPTION - EXPOSED ROUND DUCT IN CONDITIONED SPACE. INSULATE NEW HEATING WATER PIPING. EXCEPTION EXPOSED PIPING IN FINISHED SPACES AND PIPING IN FINTEUBE ENCLOSURES.
- BALANCE AIR SYSTEMS. BALANCE HVAC WATER SYSTEM. SUBMIT COPIES OF START UP AND BALANCE REPORTS TO THE OWNER.
- PROVIDE OPERATION AND MAINTENANCE INFORMATION TO THE OWNER. PROVIDE AS-BUILT DOCUMENTATION TO THE OWNER.
- PROVIDE AND INSTALL EQUIPMENT AND DUCT IN ACCORDANCE WITH NEW YORK STATE ENERGY CODE AND MECHANICAL CODE.
- PROVIDE LISTED FIRE STOP SYSTEM AT PENETRATIONS OF RATED PARTITIONS AND CEILING ASSEMBLIES.
- INSTALL ALL EQUIPMENT IN ACCORDANCE WITH THE MANUFACTURER'S INSTRUCTIONS.
- PROVIDE OPERATING AND MAINTENANCE LABELS IN ACCORDANCE WITH THE ENERGY CODE.

DUCTWORK

DUCTWORK SHALL BE GALVANIZED STEEL CONSTRUCTED IN ACCORDANCE WITH SMACNA 2" PRESSURE CLASS AND C SEAL CLASS. IN ADDITION ALL SEAMS AND JOINTS SHALL BE SEALED IN ACCORDANCE WITH THE ENERGY CODE.

ROUND DUCT SHALL BE SPIRAL.

PROVIDE RADIUS DUCT ELBOWS. IF USED, PROVIDE TURNING VANES IN ALL MITERED ELBOWS (EXCEPTION - ELBOWS AT RETURN AND TRANSFER GRILLES). PROVIDE A VOLUME DAMPER IN EACH BRANCH TO DIFFUSERS (EXCEPT WHERE DAMPERS ARE SHOWN AT THE DIFFUSERS. ALL DUCT BRANCHES SHALL BE 45 DEG. TAP TYPE. BRANCHES TO DIFFUSERS AND GRILLES SHALL BE THE SIZE OF THE DIFFUSER NECK UNLESS OTHERWISE NOTED.

FLEX DUCT CONNECTIONS FOR CONNECTIONS TO DIFFUSERS IN SUSPENDED CEILINGS SHALL BE LINED & INSULATED AND MAXIMUM 6 FEET.

WHERE ACOUSTICAL INSULATION DUCT LINING IS USED, DIMENSIONS SHOWN ARE INSIDE NET CLEAR.

EXPOSED DUCT WHICH WILL BE PAINTED SHALL BE PREPARED FOR PAINTING.

FIELD MEASURE DUCTWORK. COORDINATE DUCTWORK WITH OTHER TRADES PRIOR TO INSTALLATION. PROVIDE OFFSETS AND TRANSITIONS.

ALTERNATES

M1 006 & 012 - RENOVATION WORK:
 REMOVE EXISTING TRANSFER DUCTS, FANS, GRILLES AND DIFFUSERS.
 REPLACE BASEBOARD HEATERS. REVISE HEATER PIPING.
 006 ONLY - PROVIDE TRANSFER FAN FOR 008.
 REMOVE EXISTING THERMOSTATS AND REINSTALL ON THE NEW WALL SURFACE.
 (NOTE THAT THE WORK ASSOCIATED WITH 010 IS IN THE BASE BID.)

M4 006 & 012 - WORK ASSOCIATED WITH PROVIDING DUCTED AIR FROM RTU-N TO 006 & 012.

SYMBOLS

- FD FIRE DAMPER
- AD DUCT ACCESS DOOR
- VOLUME DAMPER
- BALL VALVE
- || UNION
- ⊗ BALANCE VALVE
- ⊠ CONTROL VALVE
- CV CONTROL VALVE
- BV BALANCE VALVE
- ⊞ THERMOSTAT
- CRD CEILING RADIATION DAMPER
- ✓ CHECK VALVE
- CTE CONNECT TO EXISTING
- FT FINTEUBE
- BB BASEBOARD HEATER


THE EXISTING CONDITIONS SHOWN ARE BASED ON AS-BUILT DRAWINGS AND FIELD OBSERVATIONS. ACTUAL CONDITIONS MAY VARY. ACCOUNT FOR POSSIBLE VARIATIONS. NOTE EXISTING CONDITIONS DURING REMOVALS AND INCLUDE THE CONDITIONS ON THE FIELD AS-BUILT DRAWINGS.

PRIOR TO REMOVALS


- TEST EXISTING THERMOSTATS. INCLUDING ALL HEATING THERMOSTATS AND BOTH ROOFTOP THERMOSTATS. REPORT RESULTS TO THE ENGINEER.

REMOVALS

- COORDINATE REMOVALS WITH NEW WORK.
- REMOVE EXISTING CONTROL DEVICES NOTED. REMOVE WIRING.
- DISCONNECT AND REMOVE PIPING IN THE EAST EXTERIOR WALL (RADIUS WALL) WHERE REQUIRED FOR INSTALLATION OF WINDOWS. THIS PIPING WILL BE REPLACED. LOCATION CONNECTIONS AT EACH END DURING REMOVALS AND COORDINATE CONNECTIONS WITH NEW WORK.

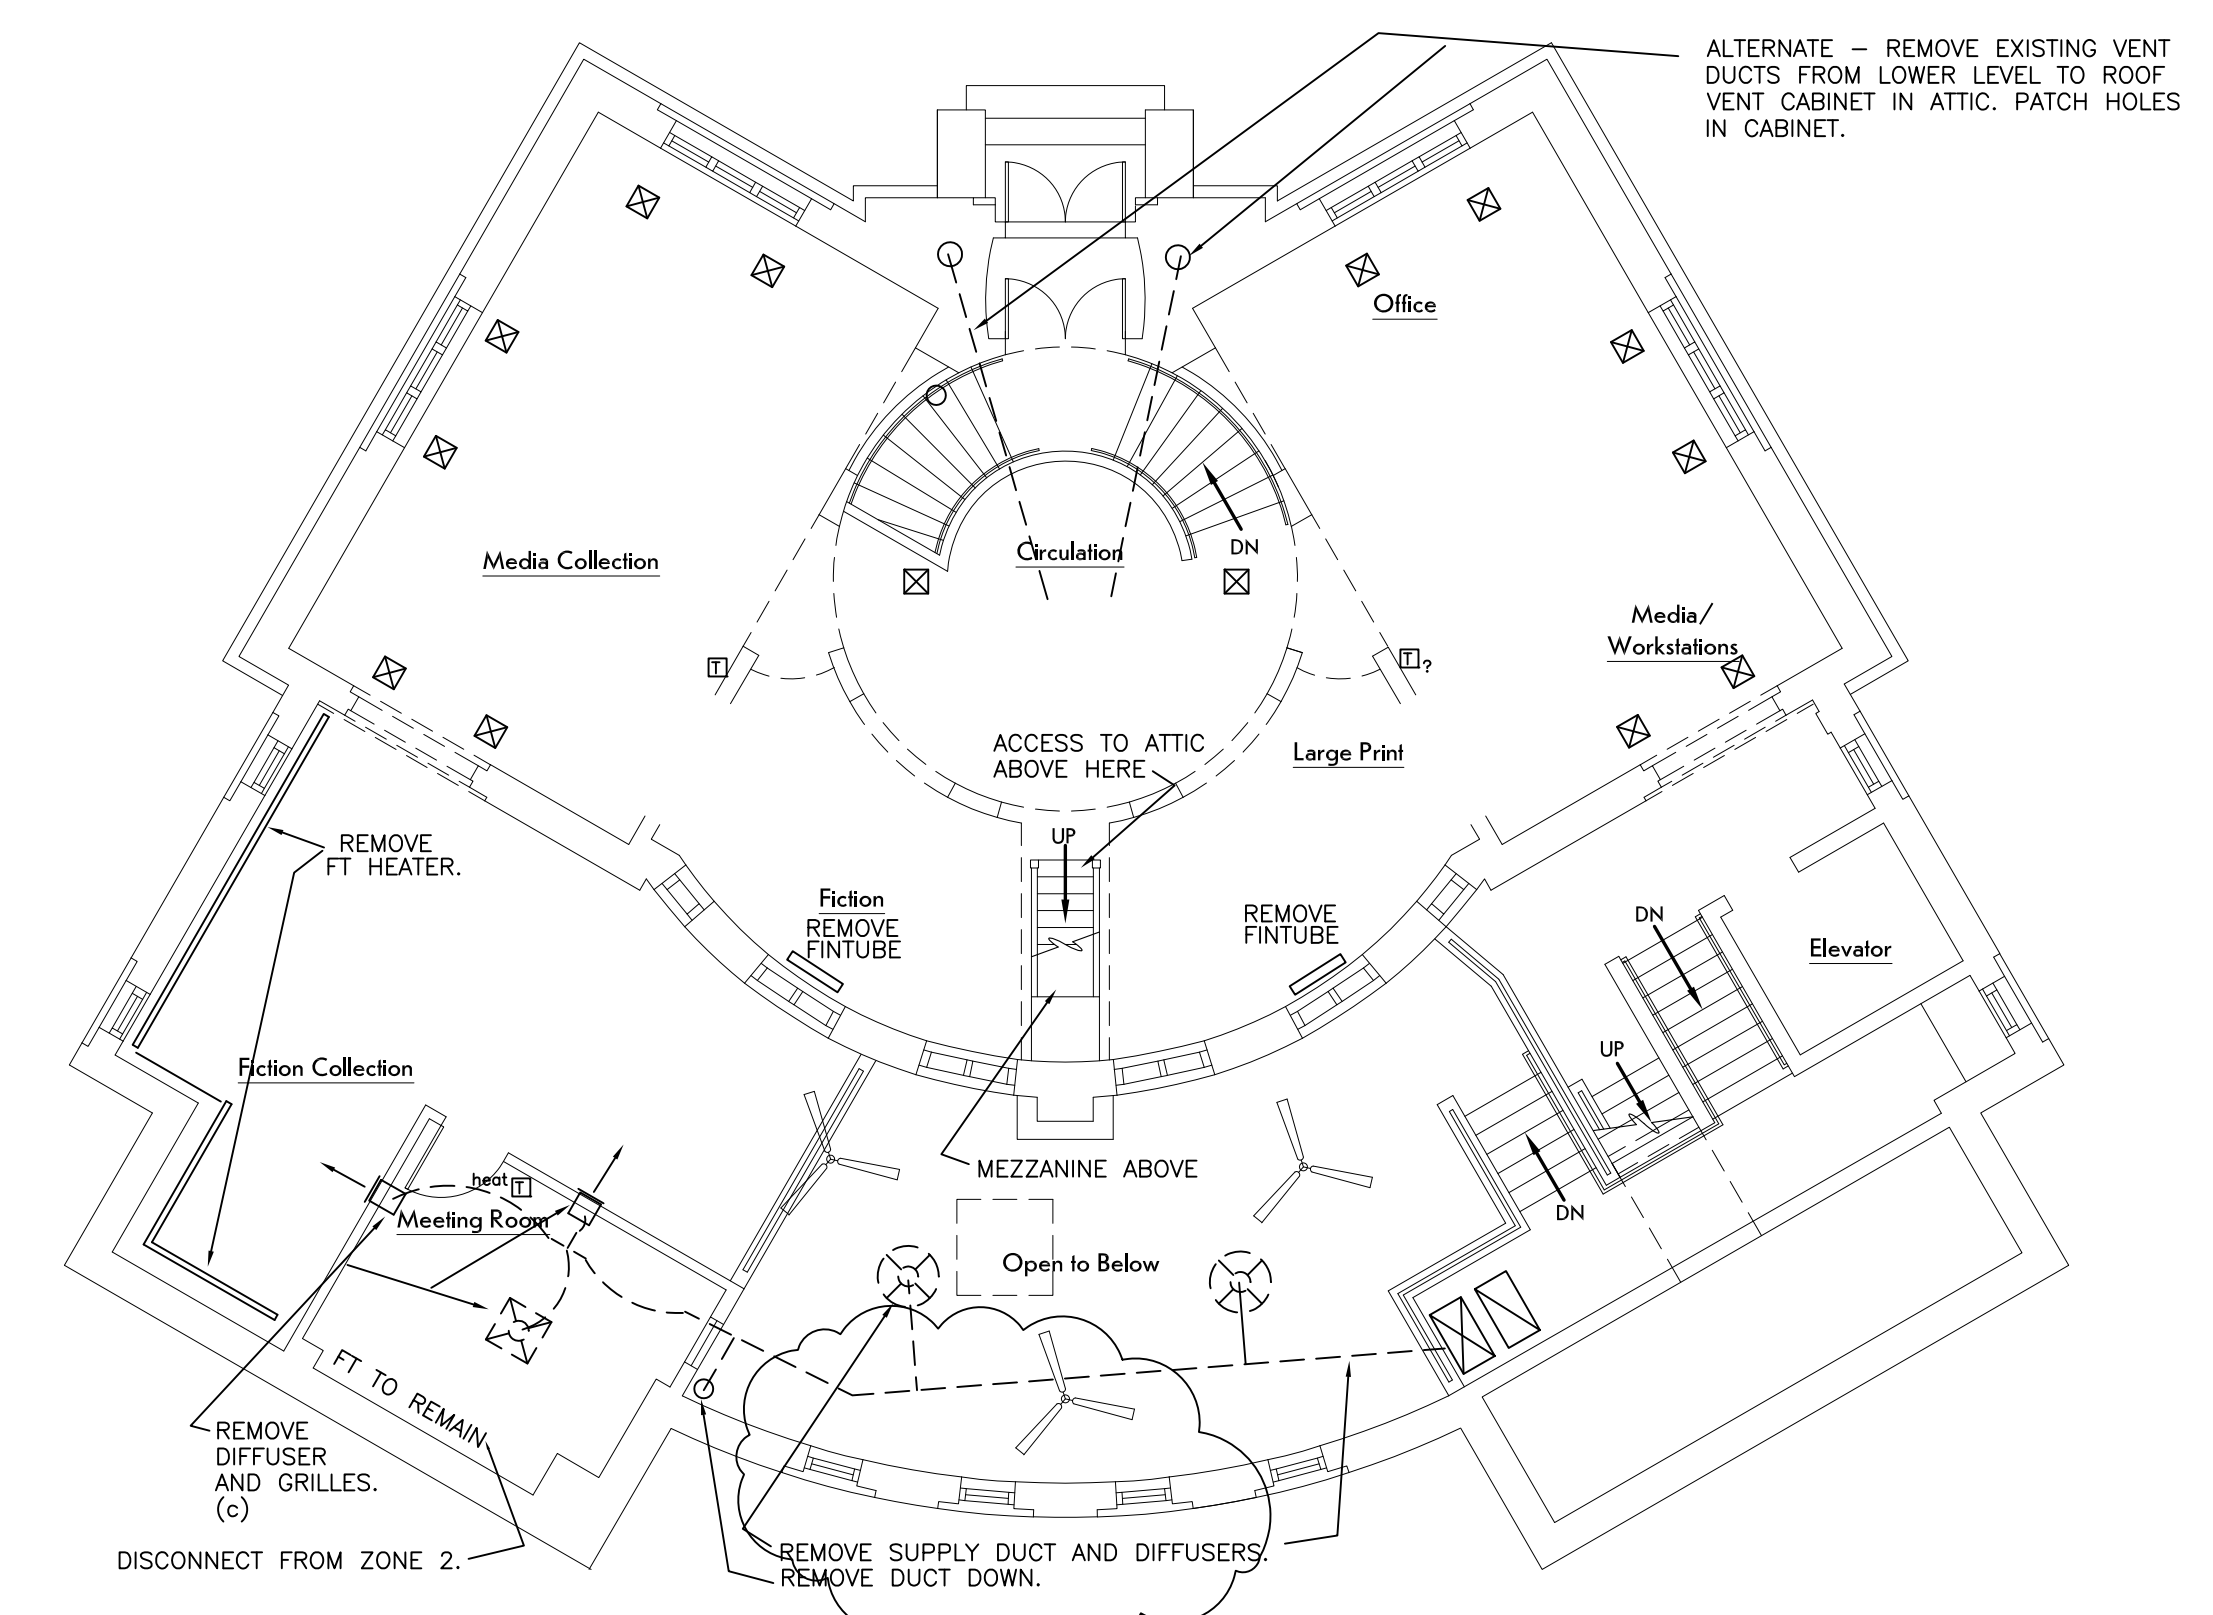

MAIN LEVEL FLOOR PLAN
 1/8" = 1'-0"

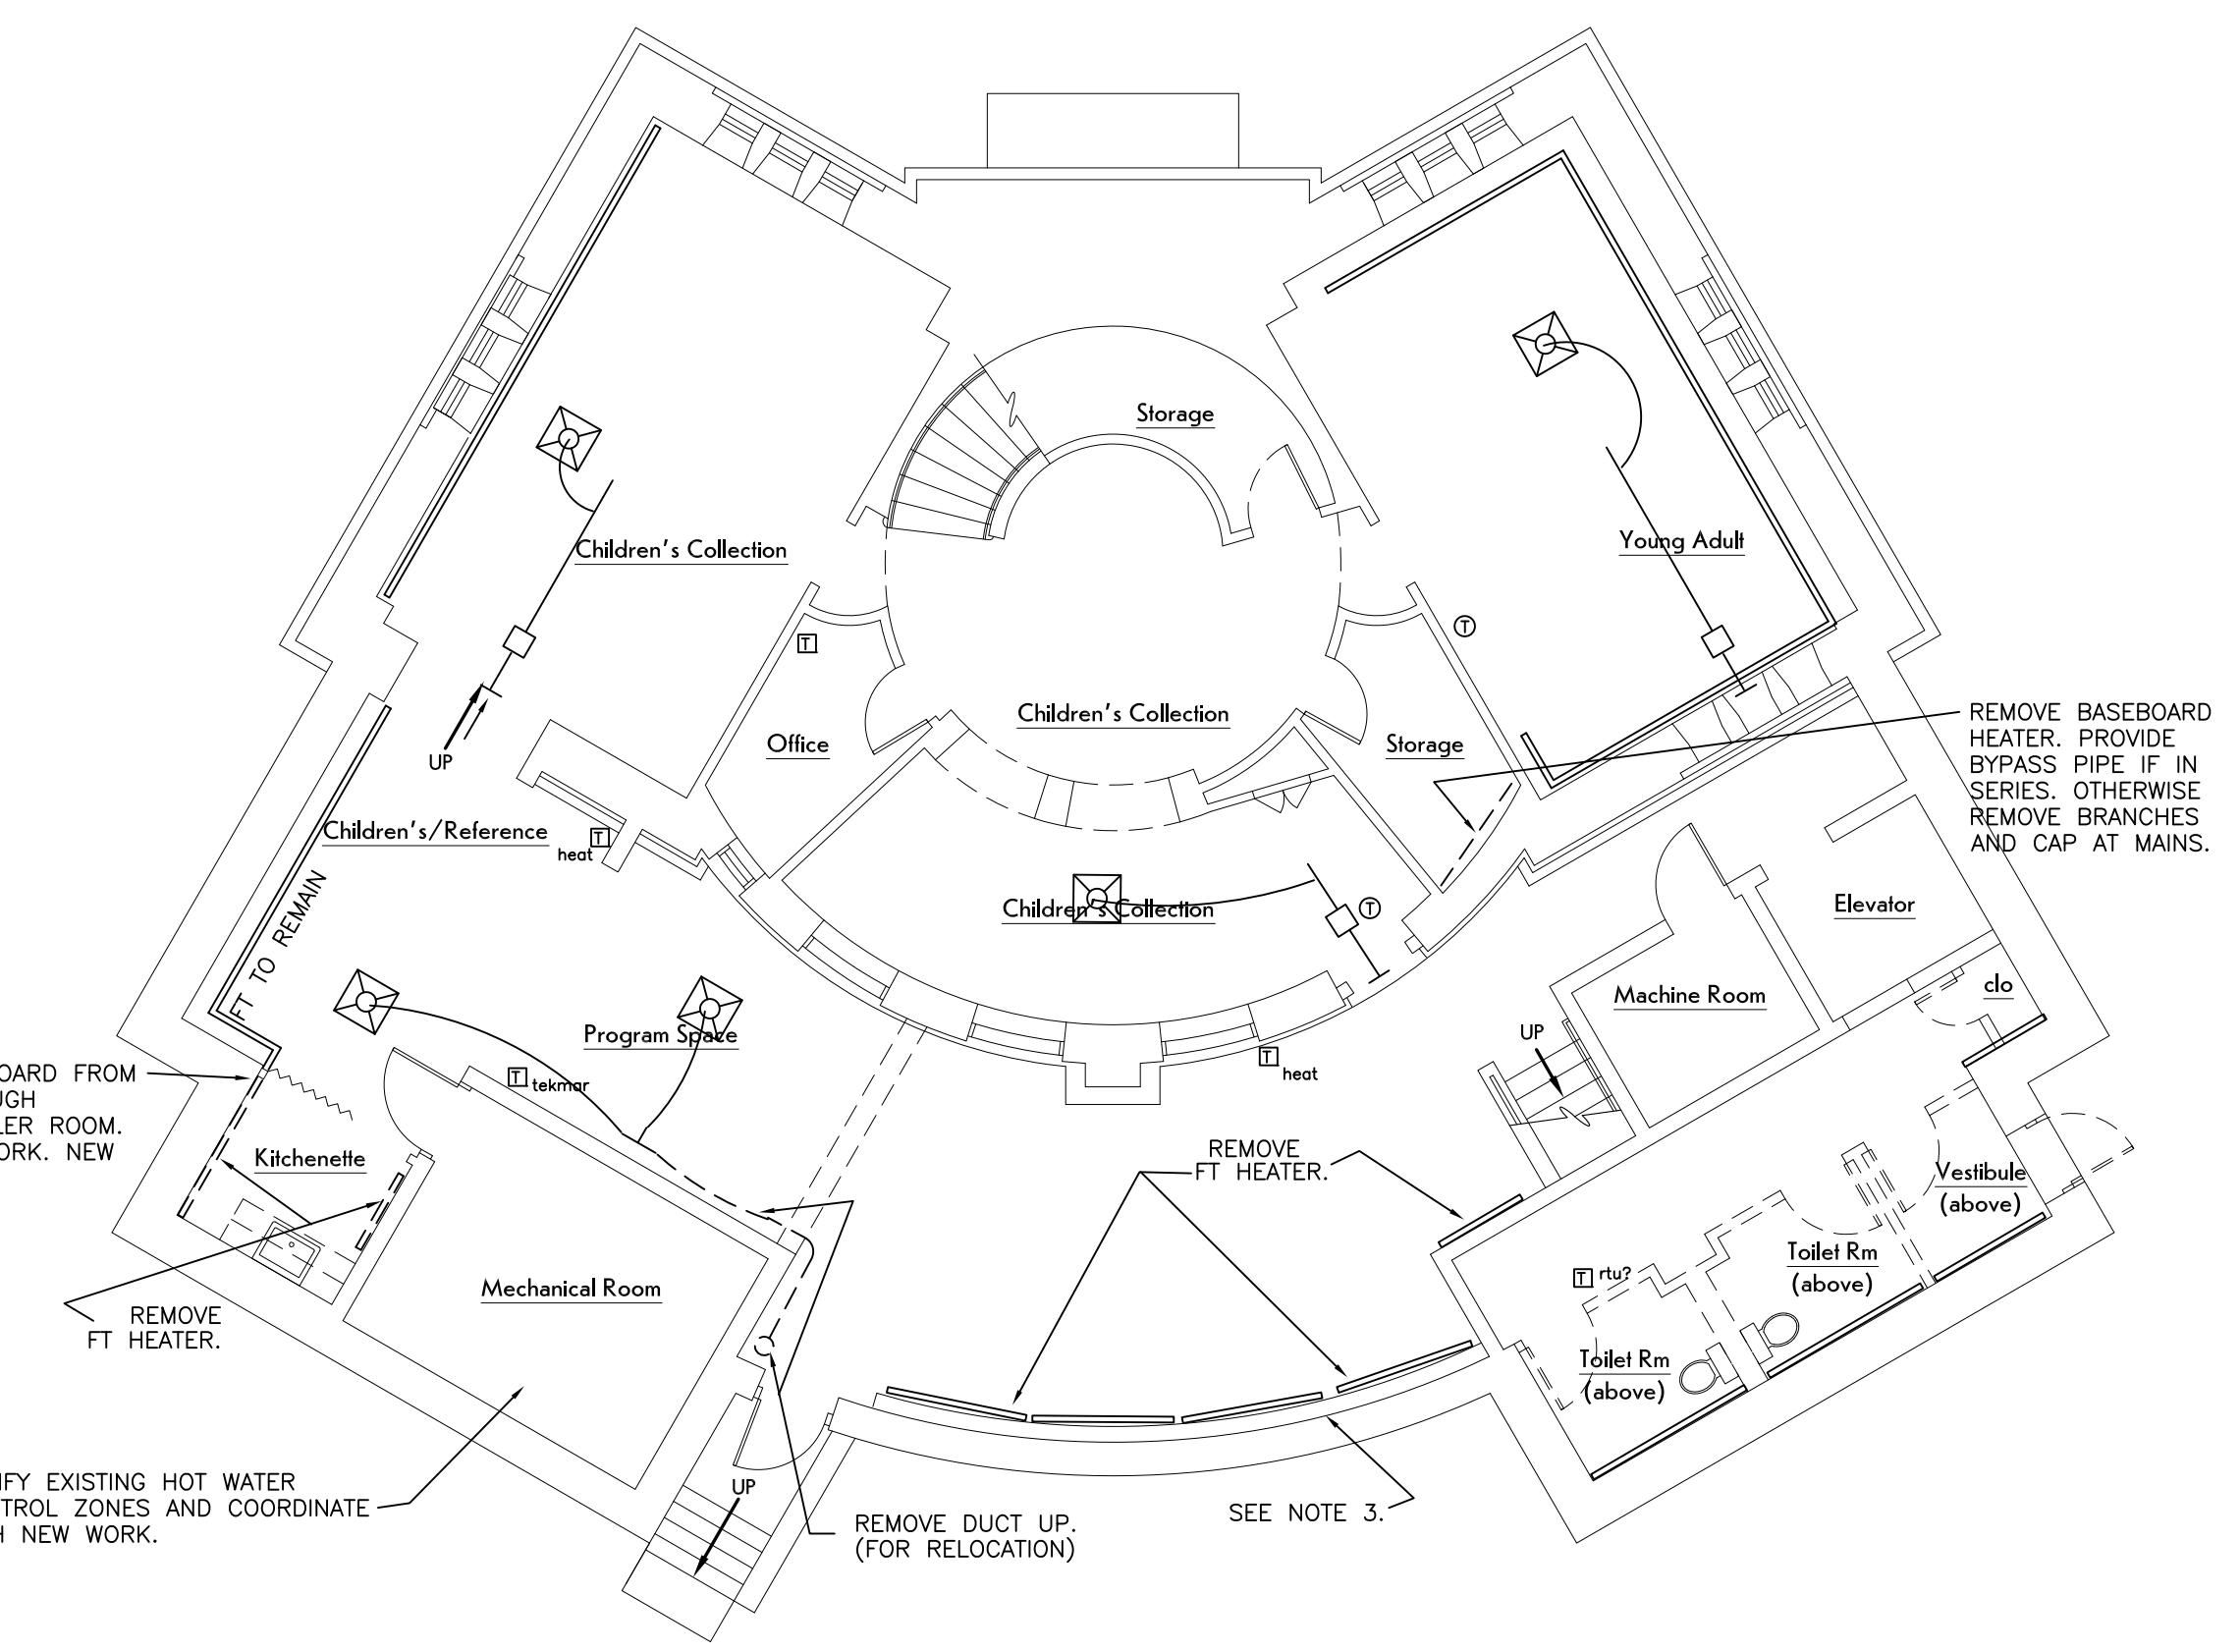

LOWER LEVEL FLOOR PLAN
 1/8" = 1'-0"




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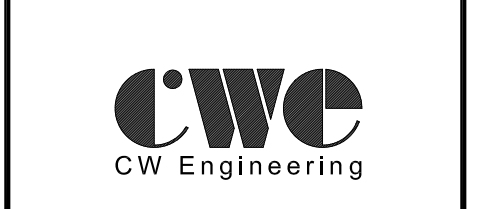
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STRUCTURAL ENGINEER:



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MEP/FP ENGINEER:



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REVISIONS:
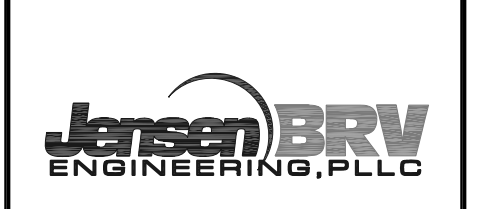
#	Date	Description

CLIENT / OWNER:



Town of Warsaw
 83 Center Street
 Warsaw, NY 14569

PROJECT INFORMATION:

Design Development
 Warsaw Public Library
 130 North Main Street, Warsaw, New York

PROJECT NUMBER: 22120

ISSUE DATE: 2/21/2024

DRAWN BY: CWE

SHEET TITLE:


REMOVALS

SHEET NUMBER:

M-01


PROJECT NOTES

- A. EXISTING ZONE VALVES IN THE BOILER ROOM MAY HAVE BEEN MIS-LABELED. VERIFY IN FIELD AND LABEL AS SHOWN.
- B. PROVIDE WORK TO REVISE THE EXISTING SYSTEMS (E.G. HOT WATER HEATING, ROOFTOP UNIT). START UP AND TEST SYSTEMS AFTER RENOVATIONS.
- C. FIELD MEASURE ALL PIPING, FIN-TUBE, AND DUCTWORK.
- D. PROVIDE AIR VENTS AT HEATING WATER HIGH POINTS.

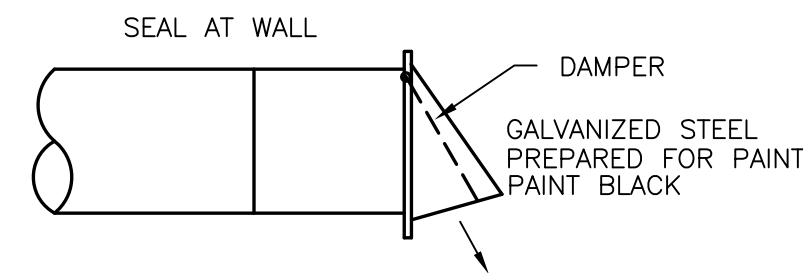

WALL VENT DETAIL
NOT TO SCALE
NO INSECT SCREENS

3/4" HWS DN TO FT. PIPE THROUGH FT. (TWO LEVEL) AND CTE BB IN 003. COORDINATE WITH THE FRAMING IN THE WALL AT THE DOOR HINGE.

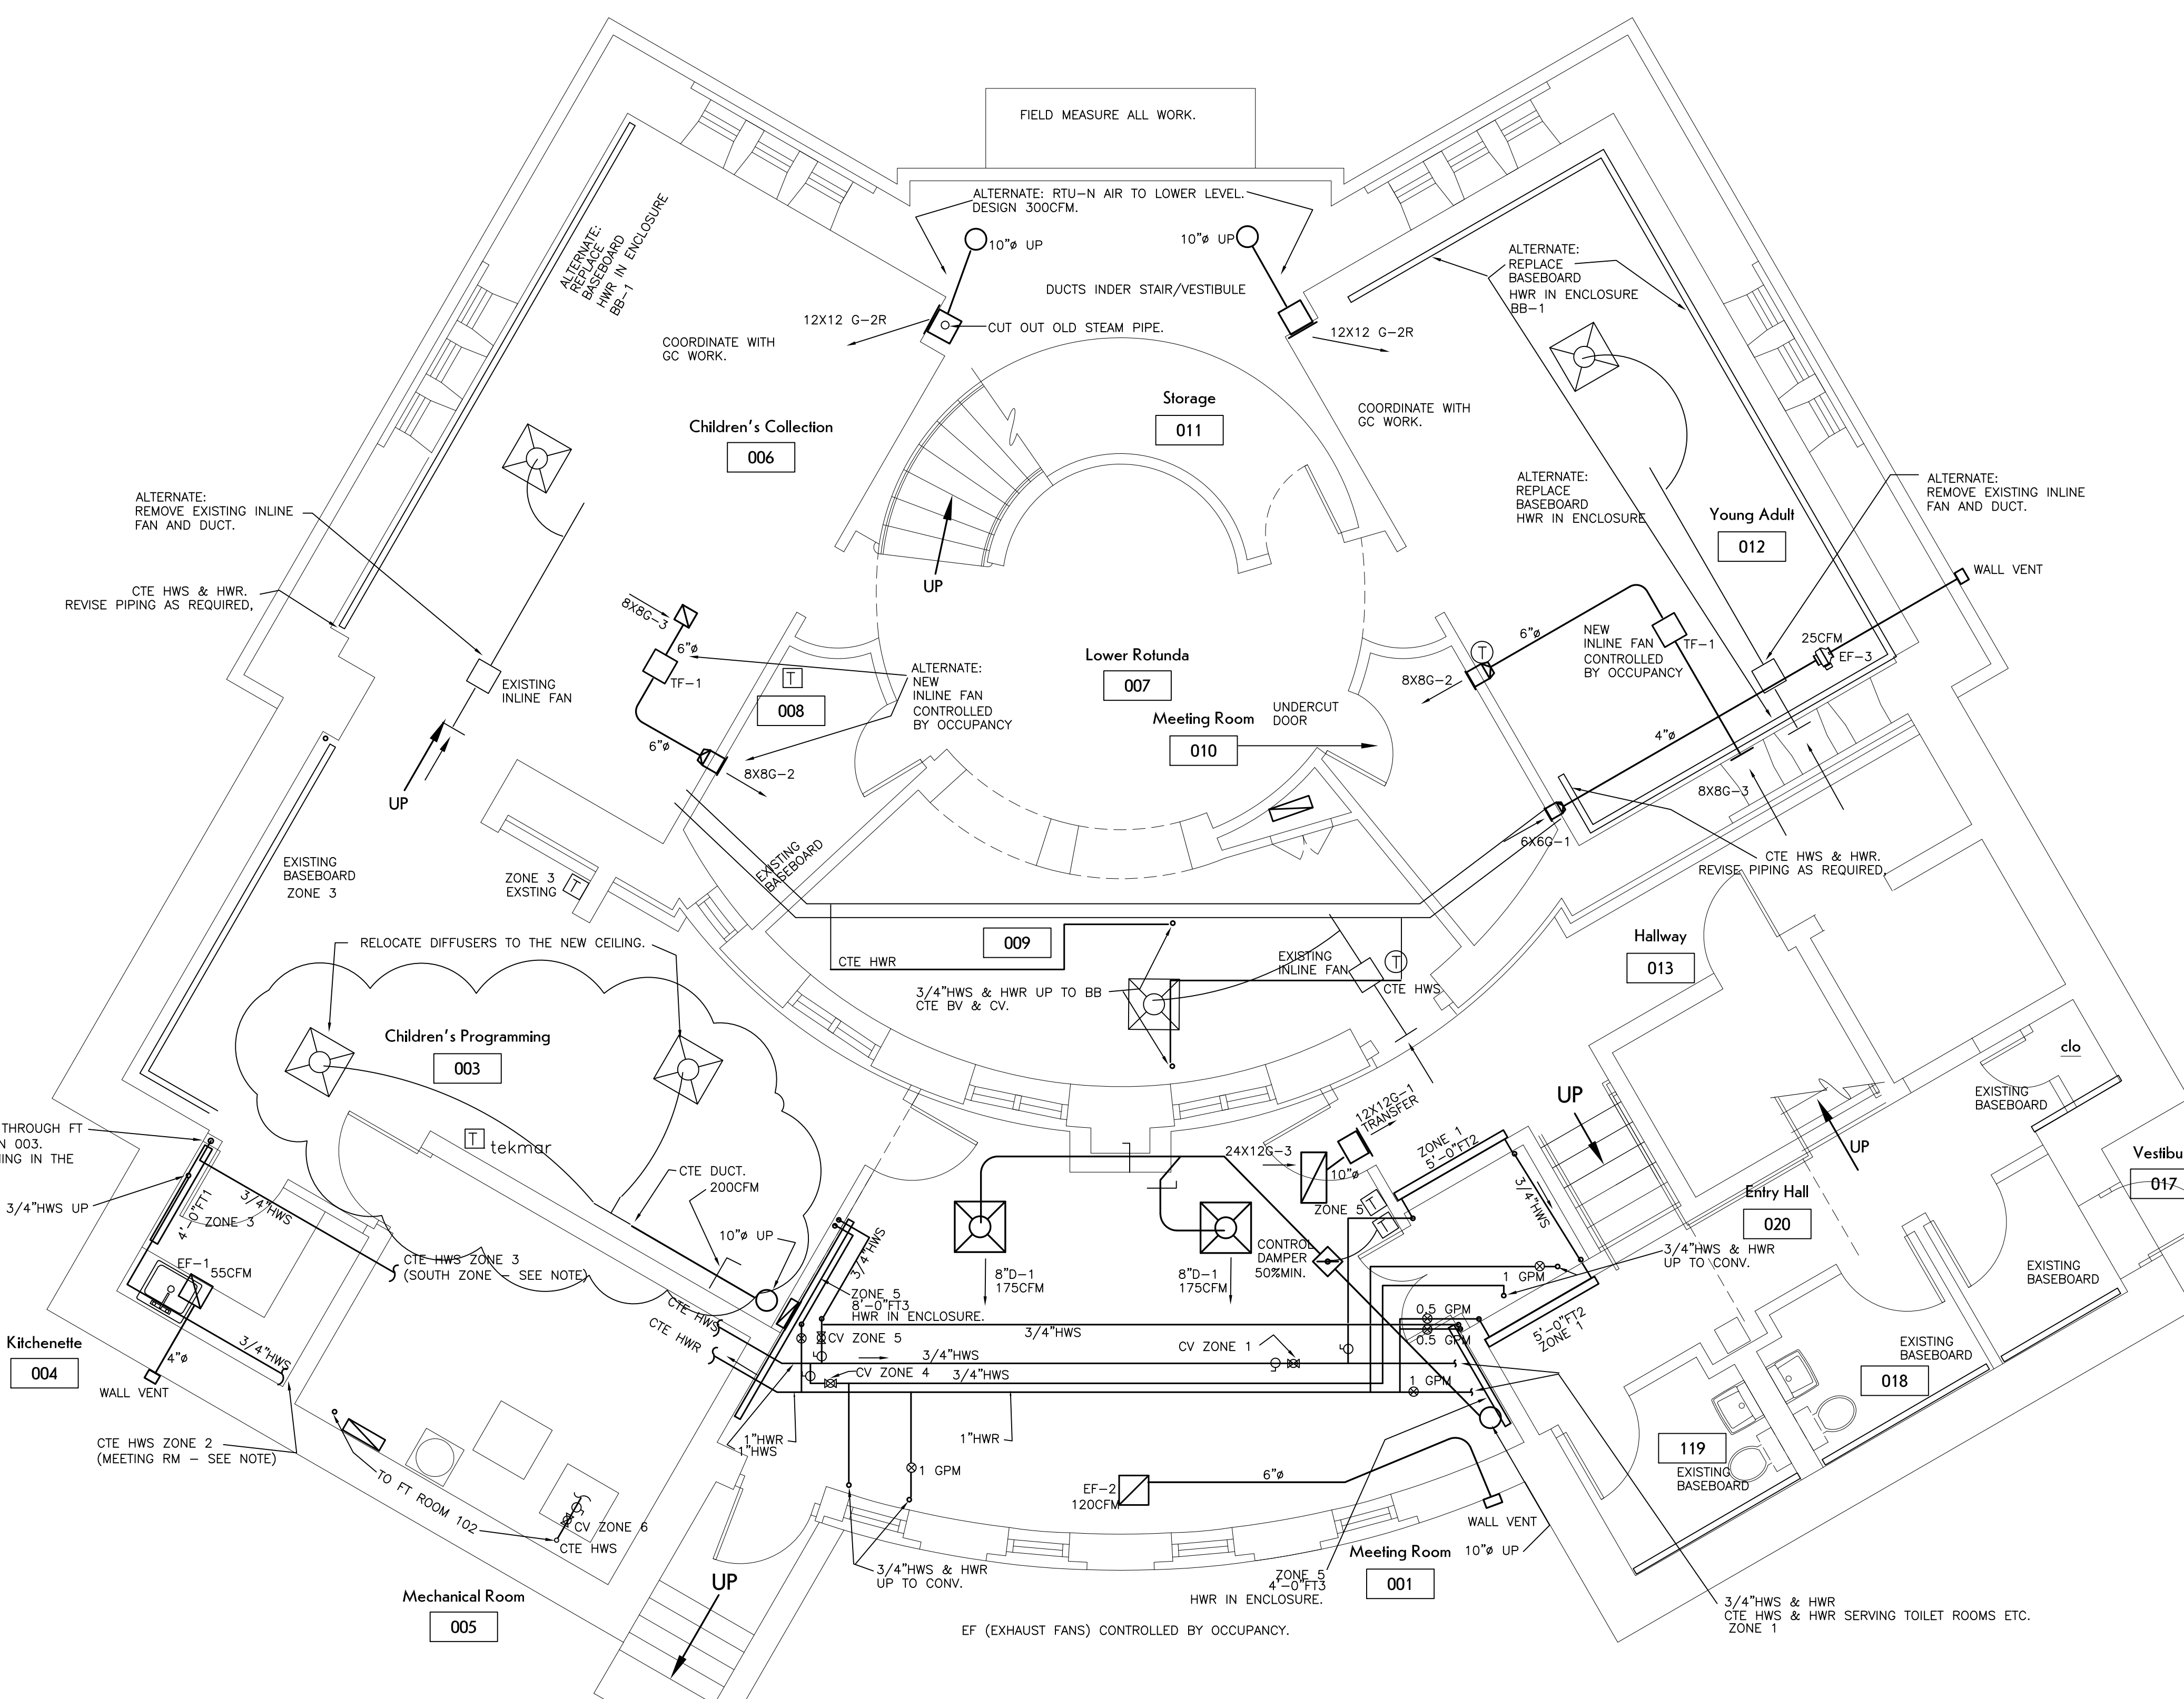

LOWER LEVEL FLOOR PLAN
1/4" = 1'-0"



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
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130 North Main Street, Warsaw, New York

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SHEET TITLE:
LOWER LEVEL

SHEET NUMBER:
M-11

TEMPERATURE CONTROL

TEMPERATURE CONTROL WORK WILL INCLUDE ALL REQUIRED CONTROL WIRING AND POWER WIRING REQUIRED FOR CONTROL. PROVIDE WIRING IN ACCORDANCE WITH THE NATIONAL ELECTRIC CODE AND IN ACCORDANCE WITH THE MANUFACTURERS REQUIREMENTS. PROVIDE ALL WIRING AND ACCESSORIES AS REQUIRED. WIRING SHALL BE CONCEALED OR IN CONDUIT.

PROVIDE 120V CONNECTIONS TO POWER SUPPLIES. LOCATE POWER SUPPLIES IN THE BOILER ROOM. ALL 24V CABLE SHALL BE CONCEALED EXCEPT IN THE BOILER ROOM.

SUBMIT INFORMATION INCLUDING DEVICES AND WIRING DIAGRAMS.

RTU-S
COMMERCIAL PROGRAMMABLE THERMOSTAT
TWO STAGE
AUTO CHANGE-OVER, 5 DEGREE DEAD BAND
24V, RETAIN MEMORY DURING POWER FAILURE
AUXILIARY OCCUPIED OUTPUT FOR VENTILATION.

OCCUPIED - FAN TO RUN CONTINUOUSLY, OUTSIDE AIR DAMPER TO OPEN.
UNOCCUPIED - FAN TO CYCLE WITH HEAT/COOL, OUTSIDE AIR DAMPER TO CLOSE.

ZONE CONTROL (COOLING) - PROVIDE SINGLE ZONE DAMPER CONTROL WITH AUTO CHANGEOVER AND DUCT TEMPERATURE SENSING. PROVIDE DAMPER, THERMOSTAT, DAMPER OPERATOR, ACCESSORIES AND WIRING.
DAMPER CLOSES WHEN COOLING SET POINT IS SATISFIED (NORMALLY OPEN). CONNECT TO NEW DESIGNATED CIRCUIT WITH SWITCH.
DAMPER
DAMPER ACTUATOR - 24V, HONEYWELL TRUE ZONE OR EQUAL. NORMALLY OPEN
TRANSFORMER - POWER SUPPLY
DUCT AIR SENSOR (CHANGE OVER)
THERMOSTAT - CLOSES DAMPER WHEN SATISFIED (NORMALLY OPEN - HEATING ACTION).

HOT WATER HEAT CONTROL - THERMOSTAT TO OPEN VALVE ON CALL FOR HEAT. CONNECT VALVE END SWITCH TO THE EXISTING BOILER CONTROL. CONNECT TO EXISTING HOT WATER CONTROL POWER SUPPLY.
ZONE VALVE WITH END SWITCH - 24V
THERMOSTAT

CONTROL: SET UP AND PROGRAM THE THERMOSTAT FOR THE SEQUENCE AND OCCUPIED SCHEDULE. OBTAIN SCHEDULE FROM THE OWNER.

AIR BALANCE:
BALANCE SUPPLY AIR FLOW.
BALANCE OUTSIDE AIR FLOW.

EQUIPMENT

DIFFUSERS AND GRILLES

- D-1 DIFFUSER - 24X24 LAY-IN ARCHITECTURAL, KRUEGER PLQ
- D-2 DIFFUSER - SURFACE LOUVERED 2-WAY, KRUEGER SH 22 2S
- D-3 DIFFUSER - ROUND ARCHITECTURAL, KRUEGER RM2PLQ
- G-1 GRILLE - RETURN LOUVERED SURFACE, KRUEGER S80
- G-2 GRILLE - SUPPLY LOUVERED, KRUEGER 80
- G-2R GRILLE - SUPPLY LOUVERED, OPPOSED BLADE DAMPER, KRUEGER 80
- G-3 GRILLE - RETURN EGGRATE, KRUEGER EGCS

ALL MOTORS SHALL HAVE THERMAL PROTECTION.

EF-1 - CEILING EXHAUST FAN WITH GRILLE
55 CFM @ .125"
115V
1 SONES
GREENHECK SP-B50
PROVIDE SPEED CONTROL.

EF-2 - CEILING EXHAUST FAN WITH GRILLE
120 CFM @ .25"
115V
2 SONES
GREENHECK SP-A90-13-VG

EF-3 - EXHAUST FAN - INLINE
25 CFM @ .2"
115V
PROVIDE SPEED CONTROL (EC-10V), WALL VENT.
FANTECH FG4

TF-1 - INLINE FAN
125 CFM @ .125"
115V
1.1 SONES
GREENHECK CSP-A125


FT-1 - FINITUBE HEATER
SLOPE TOP ENCLOSURE
1810 BTUH/FT @ 170F
3/4" COPPER, 2 ROW, ALUMINUM FINS
24" ENCLOSURE
VULCAN LVS

FT-2 - LIGHT COMMERCIAL FINITUBE HOT WATER HEATER
SLOPE TOP ENCLOSURE
715 BTUH/FT @ 170F
3/4" COPPER, 1 ROW, ALUMINUM FINS
10" ENCLOSURE
VULCAN LC-210


FT-3 - LIGHT COMMERCIAL FINITUBE HOT WATER HEATER
SLOPE TOP ENCLOSURE
715 BTUH/FT @ 170F
3/4" COPPER, 1 ROW, ALUMINUM FINS
RETURN IN ENCLOSURE
10" ENCLOSURE
VULCAN LC-210

BB-1 - BASEBOARD FINITUBE HOT WATER HEATER
710 BTUH/FT @ 170F, 1GPM
3/4" COPPER, 1 ROW, ALUMINUM FINS
VULCAN 800

CONVECTOR - HOT WATER FLOOR MOUNTED SLOPE TOP
VULCAN SF-A
DEPTH X LENGTH X HEIGHT, 170 AWT, 65 EAT
CONVECTOR-1 8X64X18H, 12,985 BTUH
CONVECTOR-2 8X64X18H, 12,985 BTUH

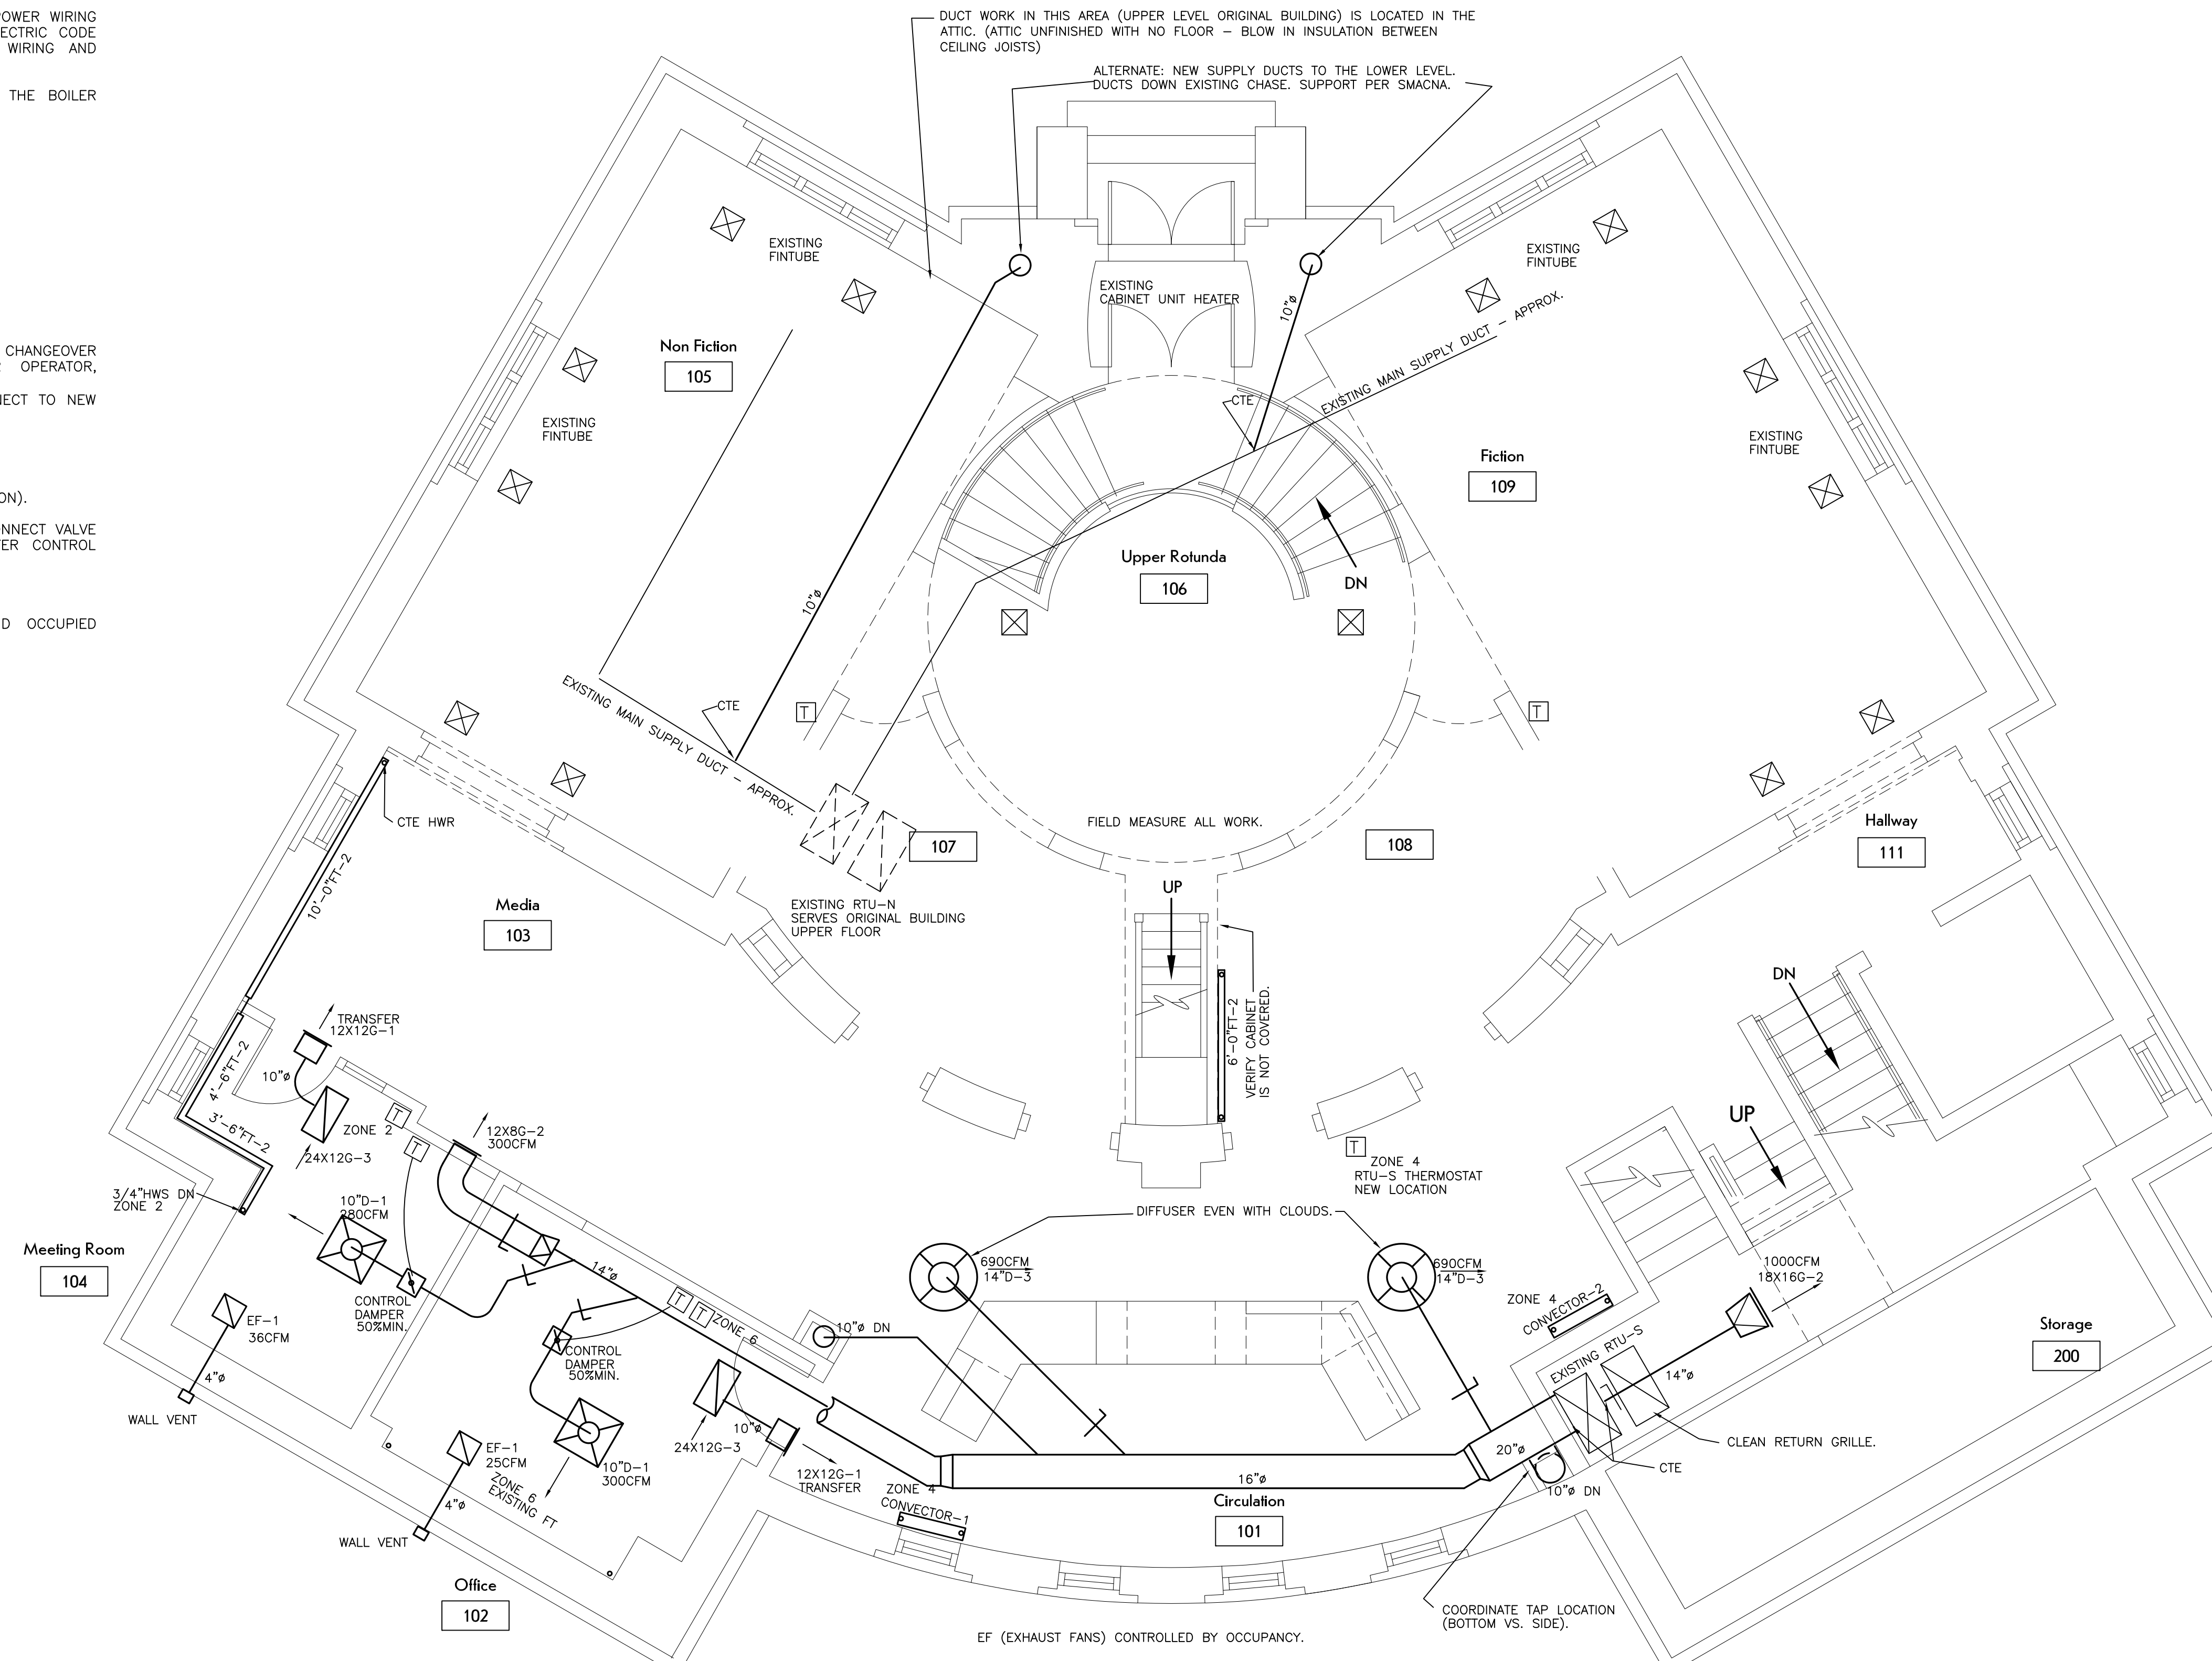

MAIN LEVEL FLOOR PLAN
1/4" = 1'-0"

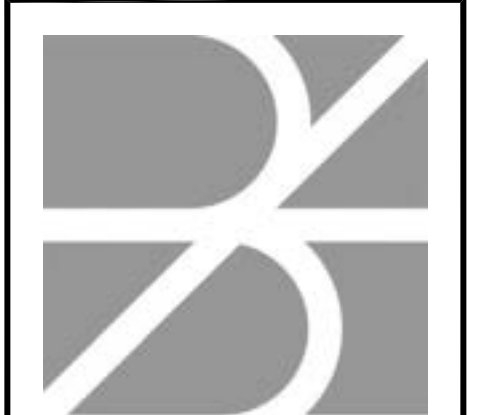

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
STRUCTURAL ENGINEER:
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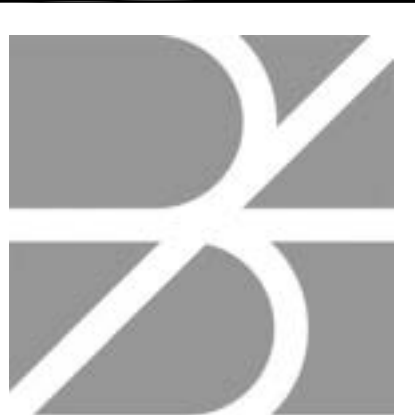
CLIENT / OWNER:

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83 Center Street
Warsaw, NY 14569

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Design Development
Warsaw Public Library
130 North Main Street, Warsaw, New York

PROJECT NUMBER: 22120
ISSUE DATE: 2/21/2024
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SHEET TITLE:
MAIN LEVEL

SHEET NUMBER:
M-12



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
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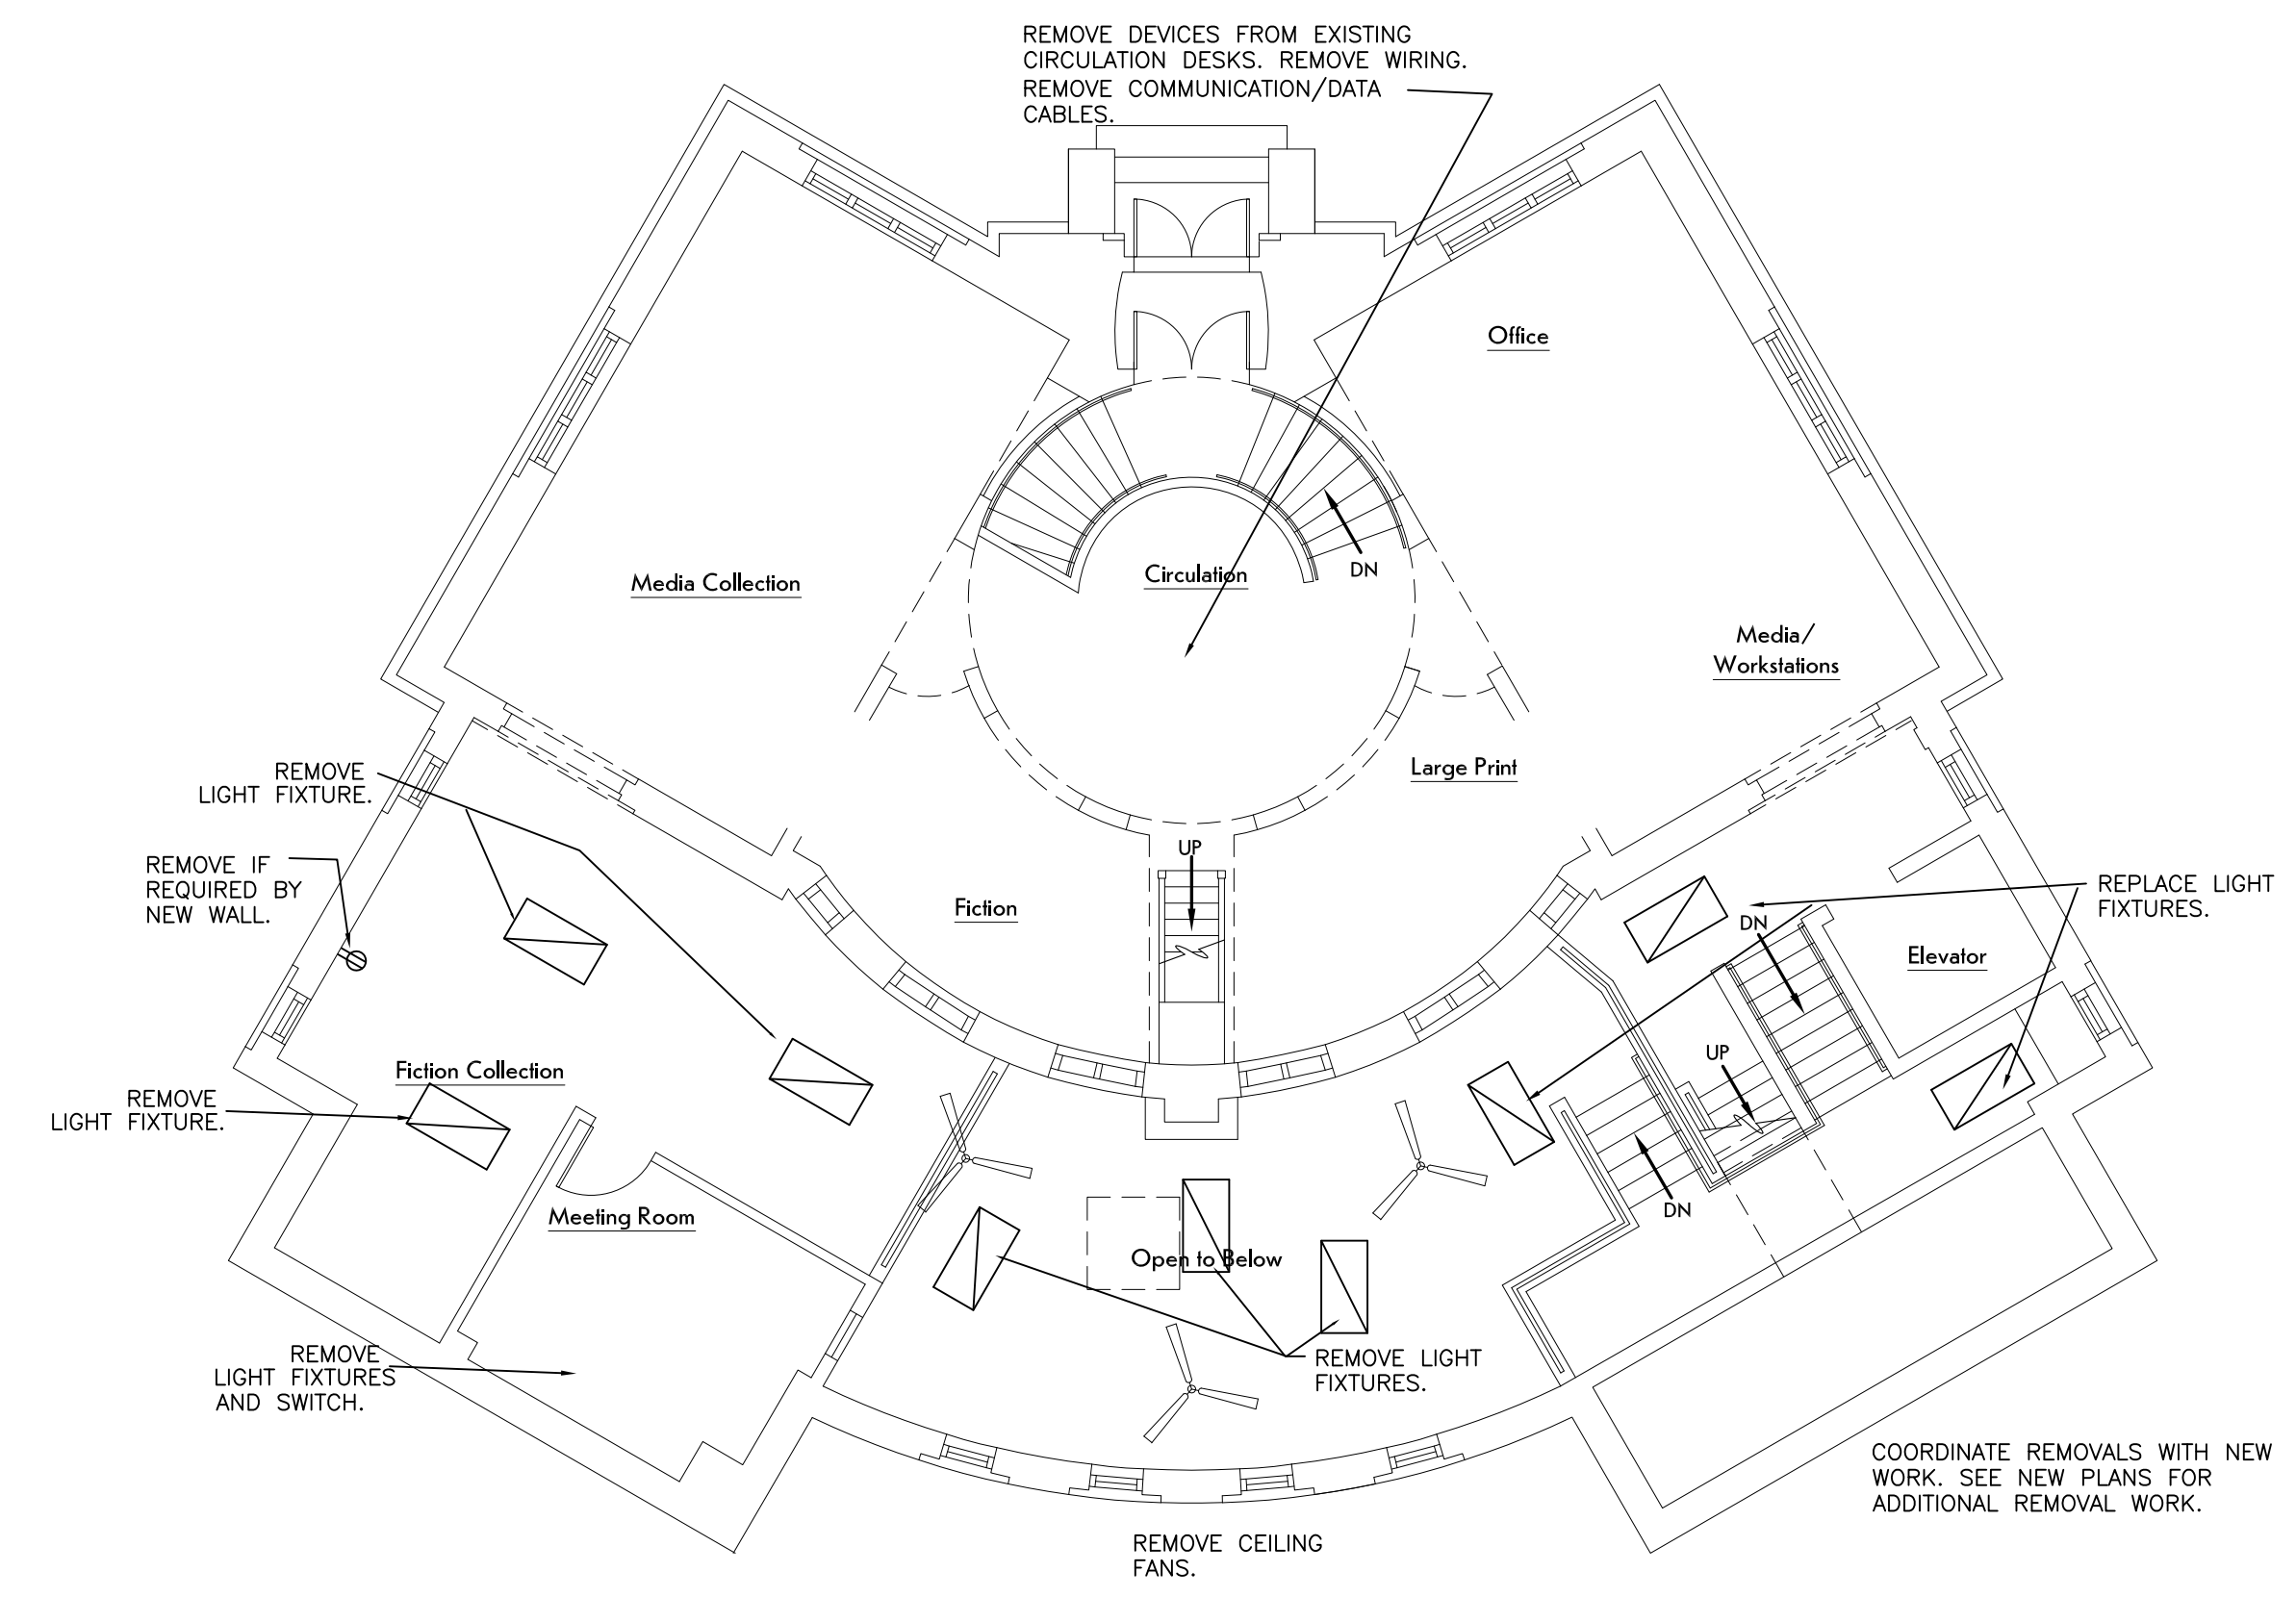
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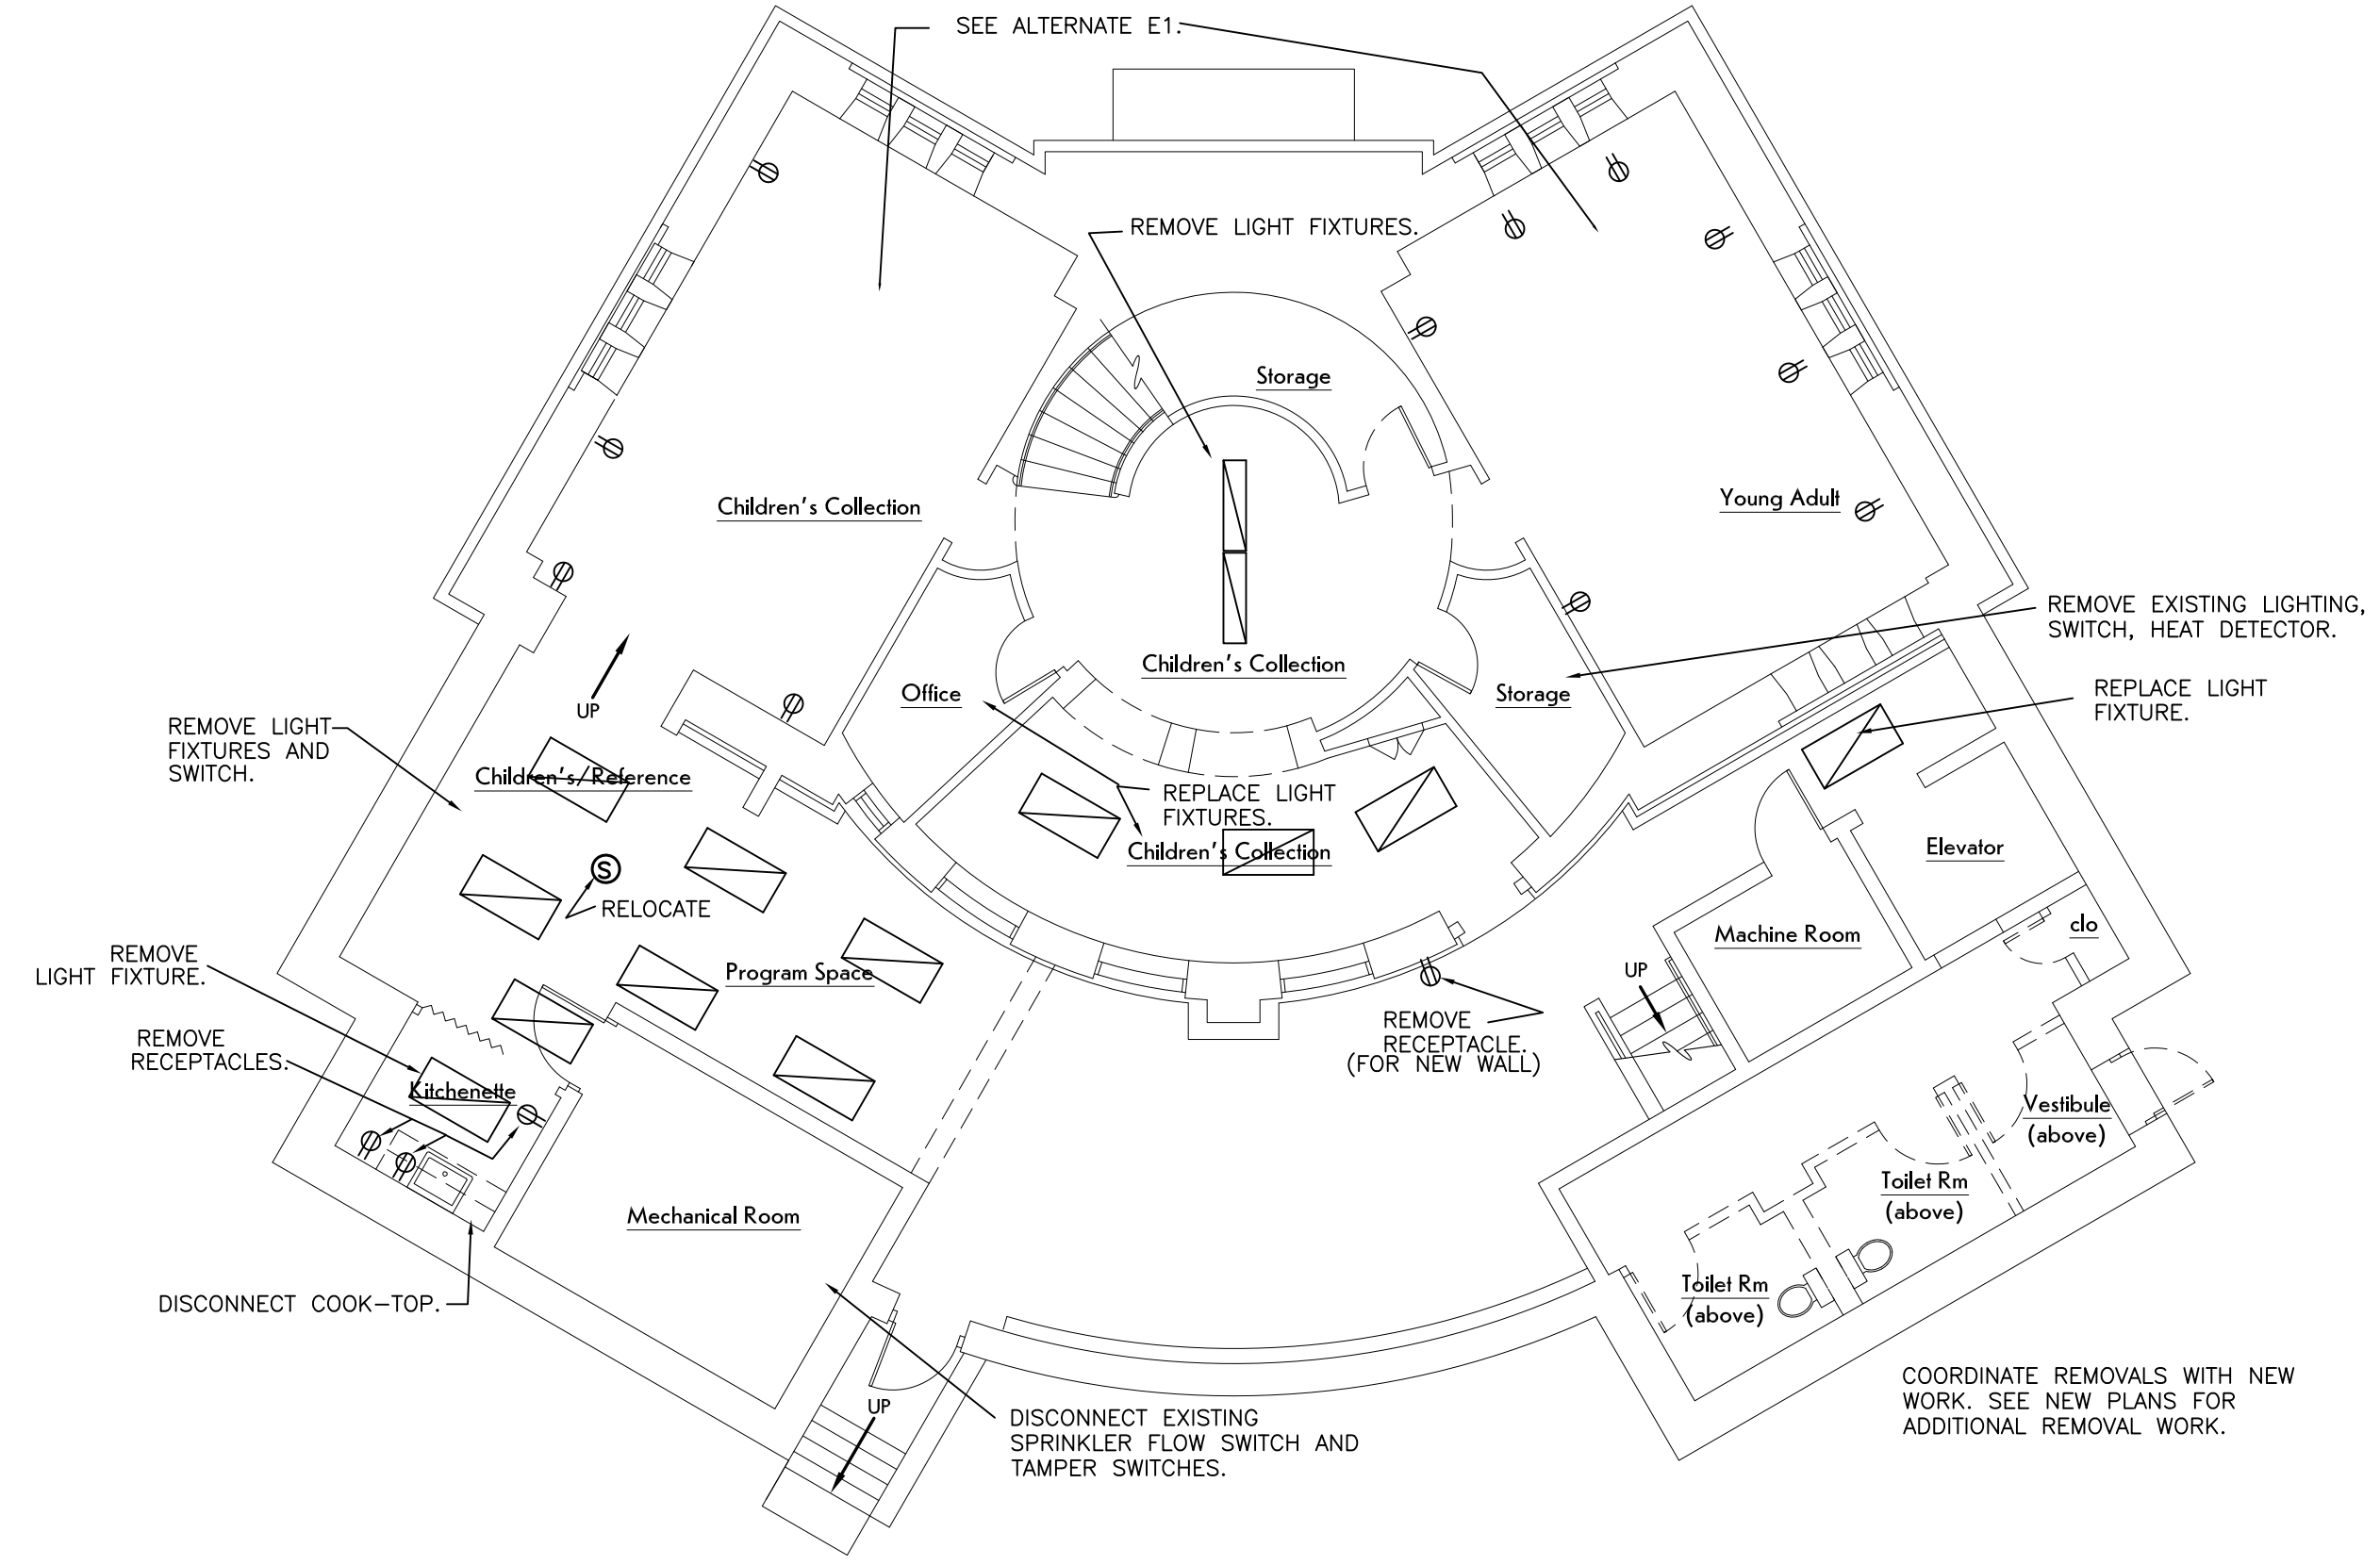
PROJECT NUMBER: 22120
ISSUE DATE: 2/21/2024
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SHEET TITLE:
REMOVALS

SHEET NUMBER:
E-01



MAIN LEVEL FLOOR PLAN
1/8" = 1'-0"



LOWER LEVEL FLOOR PLAN
1/8" = 1'-0"

SYMBOLS - ELECTRICAL

- \oplus DUPLEX RECEPTACLE
 - \oplus QUAD RECEPTACLE
 - \oplus_c RECEPTACLE - COUNTER (GFI IF NEAR SINK)
 - \oplus_{TR} RECEPTACLE - TAMPER RESISTANT
 - \oplus_{TR} RECEPTACLE - SPECIAL
 - \triangleleft TELEPHONE/DATA/CATV OUTLET
 - \curvearrowright HOME RUN CIRCUIT
 - \oplus_{GFI} RECEPTACLE - GROUND FAULT INTERRUPTING
 - \square DISCONNECT (SAFETY SWITCH)
 - \square CONTROLLER
 - $\$$ SWITCH
 - $\$3$ SWITCH - 3 WAY (4 WAY)
 - $\$_o$ OCCUPANCY SENSOR (WALL SWITCH)
 - $\$_v$ VACANCY SENSOR (WALL SWITCH)
 - $\$_d$ SWITCH - DIMMER
 - \square OCCUPANCY SENSOR (CEILING)
 - \square DAYLIGHT SENSOR (CEILING)
 - \square OCCUPANCY SENSOR RELAY
 - EF EXHAUST FAN
 - NL NIGHT LIGHT
 - \square EXIT SIGN
 - \square EMERGENCY LIGHT
 - \square PHOTOELECTRIC CONTROL
 - E EXISTING DEVICE
- FIRE ALARM**
- \oplus SMOKE DETECTOR
 - \oplus HEAT DETECTOR
 - \square FIRE ALARM PULL STATION
 - \square FIRE ALARM AUDIO/VISUAL
 - \square FIRE ALARM VISUAL (STROBE)
 - FACP FIRE ALARM CONTROL PANEL
 - FAA FIRE ALARM ANNUCIATOR
 - \square FIRE ALARM - SPRINKLER FLOW SWITCH
 - \square FIRE ALARM - VALVE TAMPER SWITCH
 - \square CARBON MONOXIDE ALARM/DETECTOR
 - \square DUCT SMOKE DETECTOR
 - AC DEVICE ABOVE CEILING
 - E EXISTING DEVICE
 - \square CARBON MONOXIDE VISUAL (STROBE)

NOTES - ELECTRICAL

1. CIRCUITS - UNLESS OTHERWISE NOTED, PROVIDE 2 #12 AWG WITH #12 GROUND TO A 20A, 1P (POLE) CIRCUIT BREAKER.
2. PROVIDE COMPLETE CIRCUITS AS SHOWN OR AS NUMBERED.
3. COORDINATE RECEPTACLE AND SWITCH INSTALLATION HEIGHTS WITH CABINETS AND EQUIPMENT.
4. PROVIDE ELECTRIC DISCONNECTS AND SAFETY SWITCHES FOR EQUIPMENT (MECHANICAL, ETC.).
5. INSTALL ALL CONDUIT CONCEALED (EXCEPTION - MECHANICAL ROOMS). INSTALL ALL CABLE CONCEALED.
6. PROVIDE LISTED FIRE STOP SEALANT/SYSTEM AT CABLE AND CONDUIT PENETRATION OF RATED WALLS & PARTITIONS.
7. DO NOT COMBINE NEUTRALS.
8. MOUNT SWITCHES 44 INCHES ABOVE FLOOR, UNLESS OTHERWISE NOTED. MOUNT RECEPTACLES VERTICALLY AT 18 INCHES ABOVE FINISHED FLOOR, UNLESS OTHERWISE NOTED.
9. DATA OUTLET - INSTALL OUTLET AT THE SAME HEIGHT AS ADJACENT RECEPTACLES. PROVIDE DEVICE WALL BOX WITH 1" CONDUIT TO ABOVE THE SUSPENDED CEILING (ABOVE OR BELOW). PROVIDE FISH WIRE AND BLANK WALL PLATE.
10. COORDINATE TO CONCEAL WIRING. ANY EXPOSED WIRING SHALL BE INSTALLED NEATLY.
11. PROVIDE CONDUIT SIZES PER THE NATIONAL ELECTRIC CODE.

ALTERNATES

- E1 006 & 012 - RENOVATION WORK:
REPLACE LIGHT FIXTURES.
REMOVE DEVICES IN WALLS. EXTEND BOXES FOR THE NEW WALL FINISH AND REPLACE THE DEVICE.
REMOVE EXISTING LIGHT FIXTURES. PROVIDE NEW LIGHT FIXTURES IN THE NEW CEILING. DISCONNECT EXISTING TRANSFER FAN.
PROVIDE CONNECTION TO THE NEW TRANSFER FAN SERVING 008.
012 ONLY - REMOVE EXISTING RECEPTACLES ON THE BASE INCLUDING SURFACE RACEWAY AND WIRING. PROVIDE NEW RECEPTACLES IN THE NEW BASE. INSTALL WIRING CONCEALED. CONNECT TO THE EXISTING CIRCUITS.
(NOTE THAT THE CONNECTIONS FOR THE FANS SERVING 010 IS IN THE BASE BID.)
PROVIDE ABOVE CEILING SMOKE DETECTORS. RELOCATE DETECTORS TO THE NEW CEILING.
- E2 101 - ALTERNATE LIGHT FIXTURES (CLOUD CEILING)

THE EXISTING CONDITIONS SHOWN ARE BASED ON ORIGINAL DRAWINGS AND FIELD OBSERVATIONS. ACTUAL CONDITIONS MAY VARY. ACCOUNT FOR POSSIBLE VARIATIONS. NOTE EXISTING CONDITIONS DURING REMOVALS AND INCLUDE THE CONDITIONS ON THE FIELD AS-BUILT DRAWINGS.

REMOVALS

- "REMOVE" TO INCLUDE DISCONNECT AND REMOVE THE DEVICE AND EXISTING CIRCUIT.
"DISCONNECT" TO INCLUDE DISCONNECT AND REMOVE EXISTING CIRCUIT.
"CIRCUIT" INCLUDES BUT NOT LIMITED TO WIRE AND CONDUIT.
"WIRING" INCLUDES BUT NOT LIMITED TO WIRE, CONDUIT, DEVICES, ACCESSORIES.
"RELOCATE" TO INCLUDE EXTEND EXISTING CIRCUIT TO THE NEW LOCATION.
1. WALL REMOVAL - REMOVE WIRING IN AND ON EXISTING WALLS WHICH WILL BE DEMOLISHED. RELOCATE AND EXTEND ANY EXISTING CIRCUITS TO REMAIN.
 2. AT REMOVALS, ON SURFACES TO REMAIN, REPAIR SURFACES TO MATCH THE ADJACENT SURFACE.

PANELBOARD SCHEDULE										
#	VOLTAGE PHASE	FRAME AMPS	MCB AMPS	UL SCCR	SPACES	MOUNT.	FEEDER			
							CONDUCT. AWG	GROUND AWG	SOURCE	CB/FUSE
PP-3	208/3/4W	125	MLO	22KA	20	RECESSED	4	10	PP-1	60A-3P

PROVIDE REQUIRED BRANCH CIRCUIT BREAKERS. CONDUCTOR SIZES ARE FOR COPPER. PP-3: LOAD CENTER

PP-1 - REMOVE COOKTOP CIRCUIT BREAKER. RELOCATE/EXTEND AN ADJACENT CIRCUIT TO PP-3 (PROVIDE CIRCUIT BREAKER). PROVIDE FEEDER CIRCUIT BREAKER IN PP-1.

FIRE ALARM SYSTEM

COORDINATE WITH EXISTING FIRE ALARM SYSTEM. CONTRACTOR TO DETERMINE IF THE EXISTING FIRE ALARM PANEL CAN BE EXPANDED. IF NOT, REPLACE THE PANEL. EXISTING PANEL - SIMPLEX 4007

PROVIDE DEVICES AS SHOWN. CONNECT TO THE BUILDING FIRE ALARM SYSTEM. PROVIDE WIRING AND ACCESSORIES REQUIRED.

REPLACE EXISTING ALARMS (AUDIBLE/VISUAL, VISUAL, AUDIBLE).

PROVIDE NAC EXTENDER POWER SUPPLY IF REQUIRED.

PROVIDE TESTING AND CERTIFICATION AS REQUIRED.

PROVIDE SHOP DRAWINGS THAT INCLUDE WIRING DIAGRAMS, MANUFACTURER'S MODEL NUMBERS AND LISTING INFORMATION, BATTERY CALCULATIONS, VOLTAGE DROP CALCULATIONS, AND CONDUCTOR TYPES AND SIZES.

CONTRACTOR SHALL PROVIDE COMPLETE SYSTEM DOCUMENTATION AS REQUIRED BY THE AHJ. CERTIFICATION OF THE SHOP DRAWINGS SHALL BE THE RESPONSIBILITY OF THE CONTRACTOR

INSTALL DEVICES IN ACCORDANCE WITH ADA AND STATE ACCESSIBILITY CODES.

SPRINKLER ALARM

SPRINKLER ALARM - IN ADDITION TO THE FIRE ALARM SYSTEM PROVIDE A INDEPENDENT CIRCUIT FOR THE SPRINKLER FLOW ALARM. PROVIDE WIRING TO EACH FLOW SWITCH (INDEPENDENT OF THE FIRE ALARM MONITORING) AND TO THE EXTERIOR WALL MOUNTED AUDIO/VISUAL ALARM. AUDIO/VISUAL ALARM TO ACTIVE WHEN ANY BUILDING FLOW ALARM IS ACTIVATED. COORDINATE WITH THE SPRINKLER SYSTEM.


PROJECT NOTES

- A. PROVIDE RECEPTACLES IN CIRCULATION DESK. COORDINATE WITH THE DESK CONSTRUCTION. PROVIDE CONNECTION TO JUNCTION BOX BELOW FLOOR. PROVIDE DATA PATHWAY TO BELOW THE FLOOR.
- B. MEETING ROOMS - PROVIDE RECEPTACLES IN ACCORDANCE WITH NFPA 70 210.71.
- C. RELOCATED AND EXTEND EXISTING CONDUIT AND WIRING NEAR FLOOR (DUE TO NEW WATER SERVICE).
- D. FOR CONNECTIONS TO EXISTING PANELBOARDS - PROVIDE BRANCH CIRCUIT BREAKER. MATCH THE SCCR OF THE PANELBOARD.
- E. ALL WIRING UNDERGROUND TO BE IN CONDUIT. UNDERGROUND CONDUIT TO BE NON-METALLIC.
- F. CUT AND TRENCH FLOOR WHERE REQUIRED. PATCH FLOOR.
- G. FLOOR OUTLET - PROVIDE CIRCUIT WIRING IN CONDUIT UNDER SLAB TO WALL AND UP TO THE CEILING SPACE.
- H. ALL NEW RECEPTACLES SHALL BE TAMPER RESISTANT. EXCEPTION - OFFICE & IN THE CIRCULATION DESK.

EQUIPMENT

FLOOR RECEPTACLE - RECESSED FLOOR OUTLET BOX
 FLUSH FLOOR WITH FLAP COVER
 BOX - INFLOOR NON-METALLIC
 PROVIDE DEPTH AS REQUIRED.
 COORDINATE WITH FLOOR FINISH.
 PROVIDE ACCESSORIES AND FLOOR TRIM.
 COVER AND TRIM MATERIAL - ALUMINUM
 STYLE: LINE DECORATOR OPENING
 HUBBELL

TABLE TOP RECEPTACLES - HUBBELL 525 SERIES

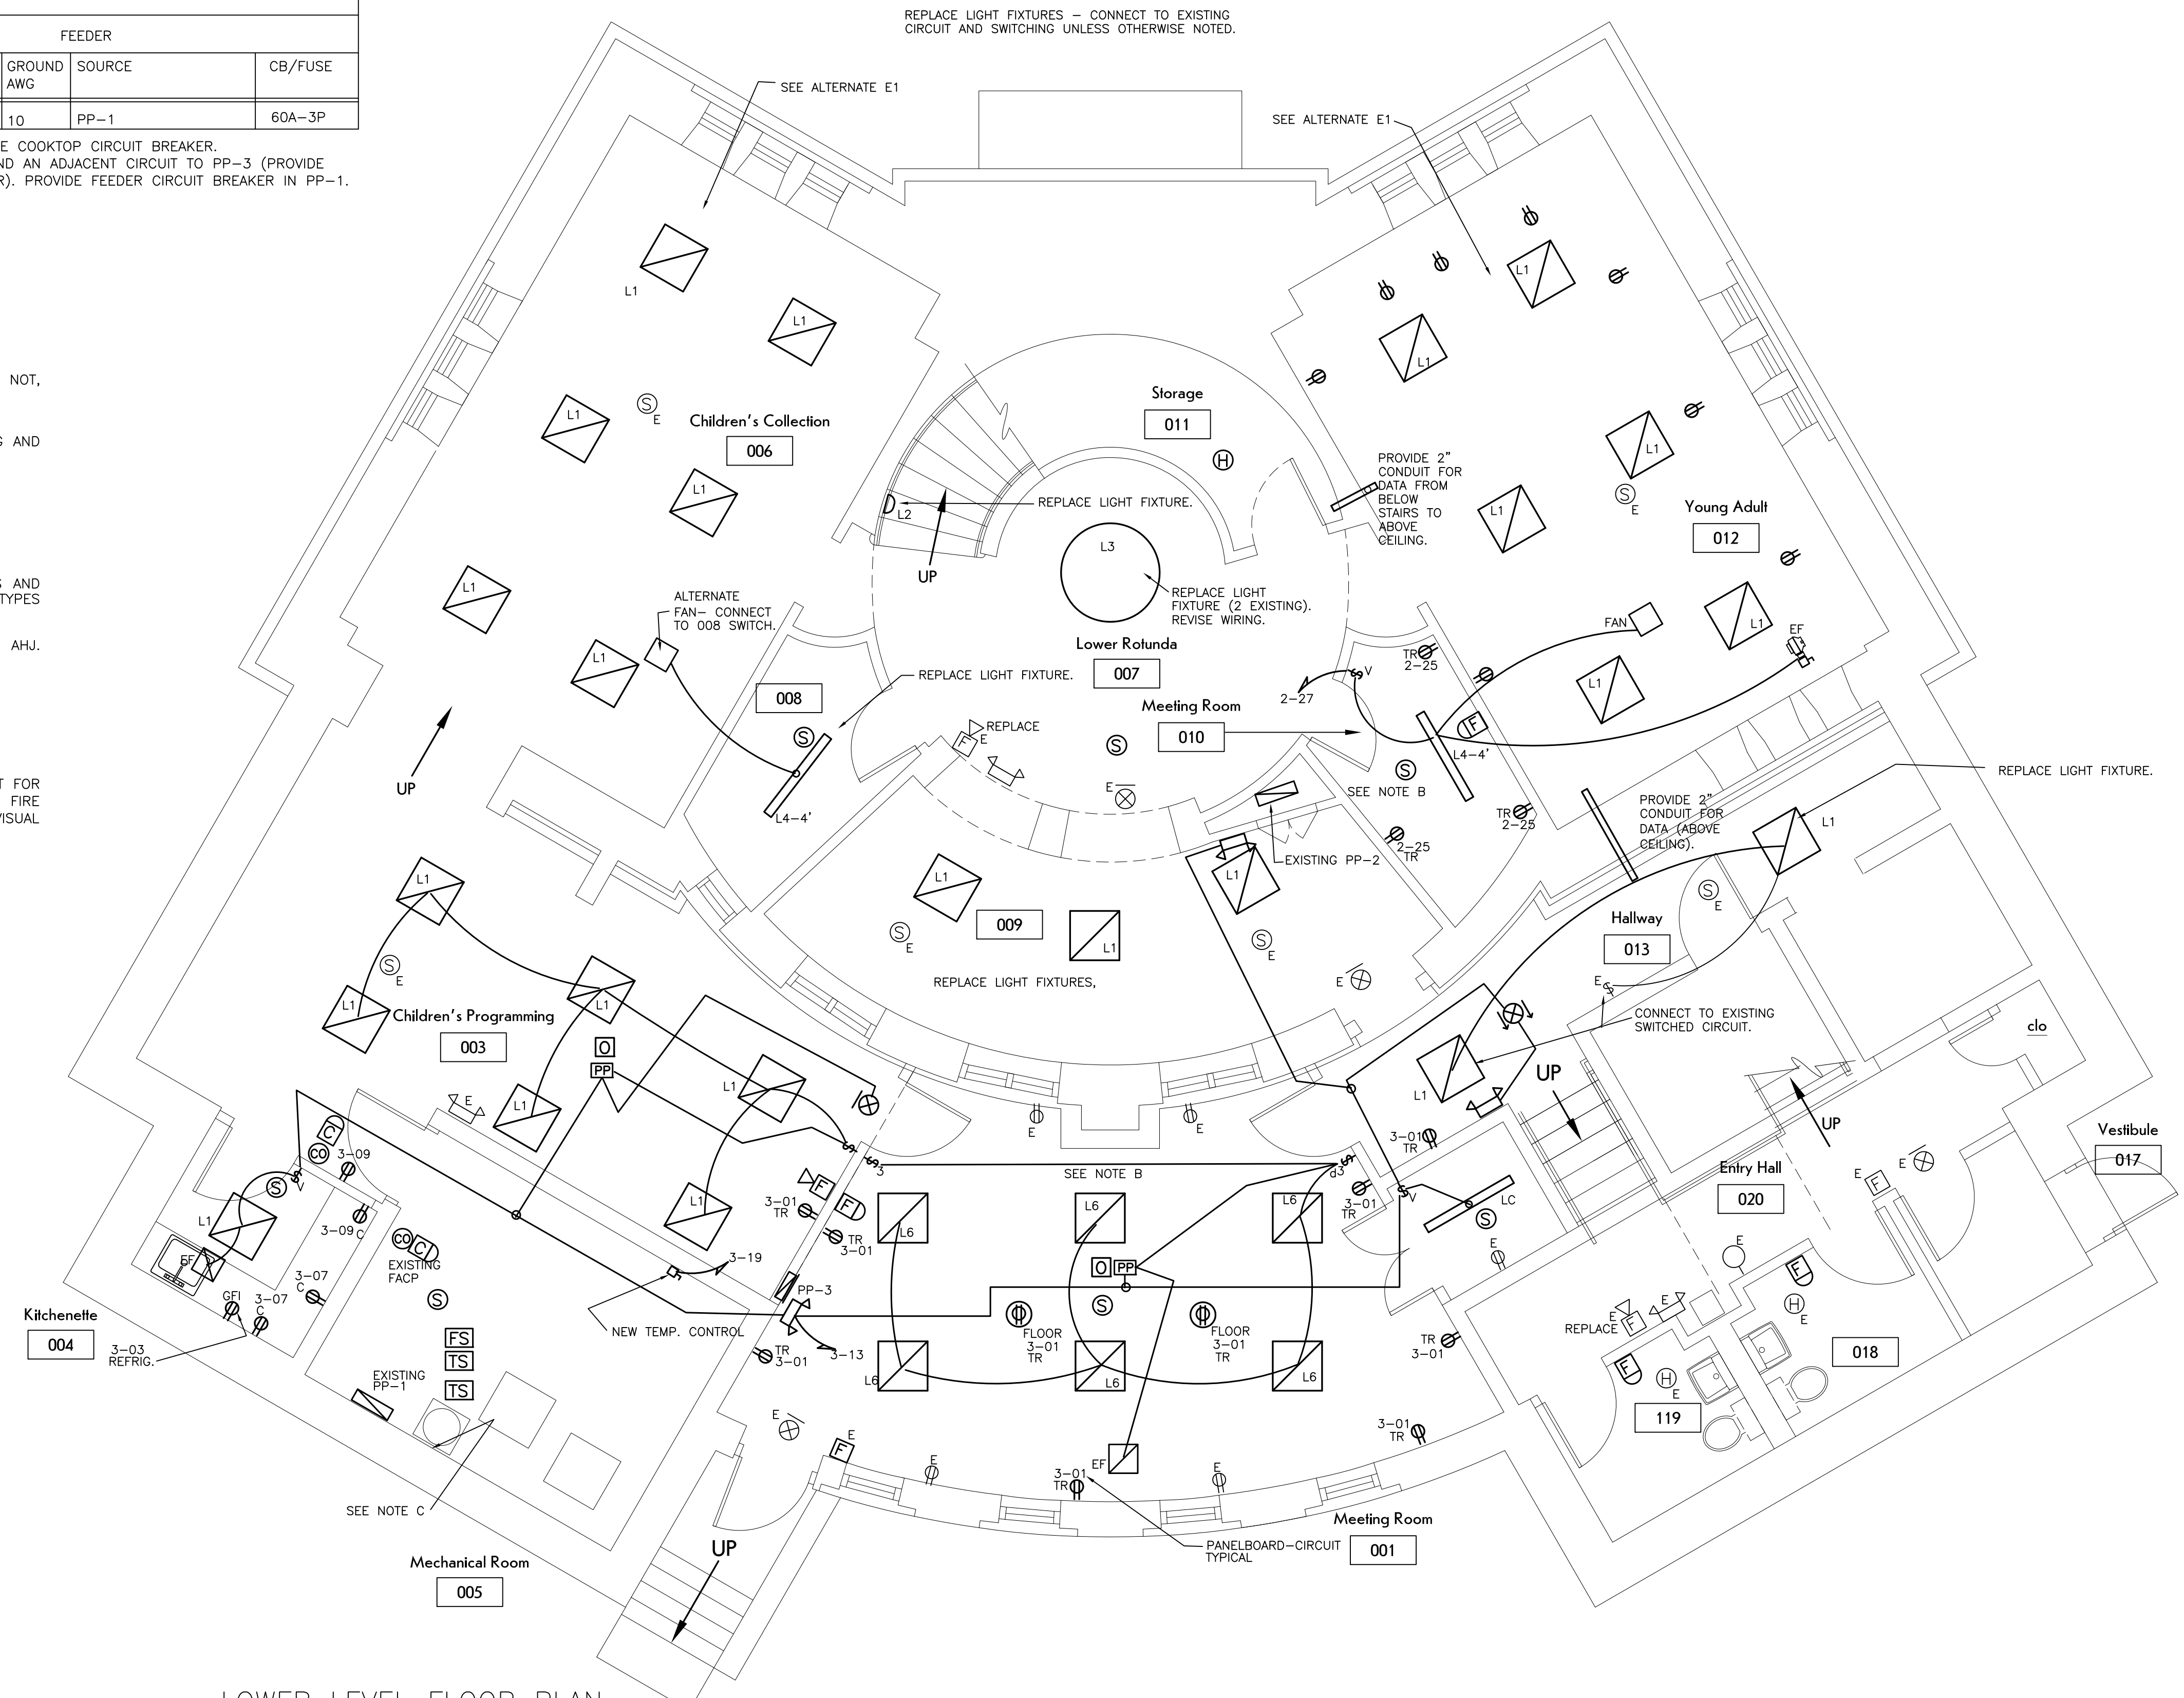

LOWER LEVEL FLOOR PLAN
 1/4" = 1'-0"

SHEET SCALE 1" ← →



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 (585) 262-2035 | www.beroarchitecture.com

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
STRUCTURAL ENGINEER:
Jensen BRV
 ENGINEERING, PLLC

1653 East Main Street
 Rochester, NY 14609
 MEP/FP ENGINEER:
CWE
 CW Engineering
 315 Rockingham Street
 Rochester, NY 14620

WARNINGS:
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REVISIONS:

#	Date	Description


CLIENT / OWNER:

 Town of Warsaw
 83 Center Street
 Warsaw, NY 14569

PROJECT INFORMATION:
 Design Development
 Warsaw Public Library
 130 North Main Street, Warsaw, New York


PROJECT NUMBER: 22120
 ISSUE DATE: 2/21/2024
 DRAWN BY: CWE

SHEET TITLE:
 LOWER LEVEL

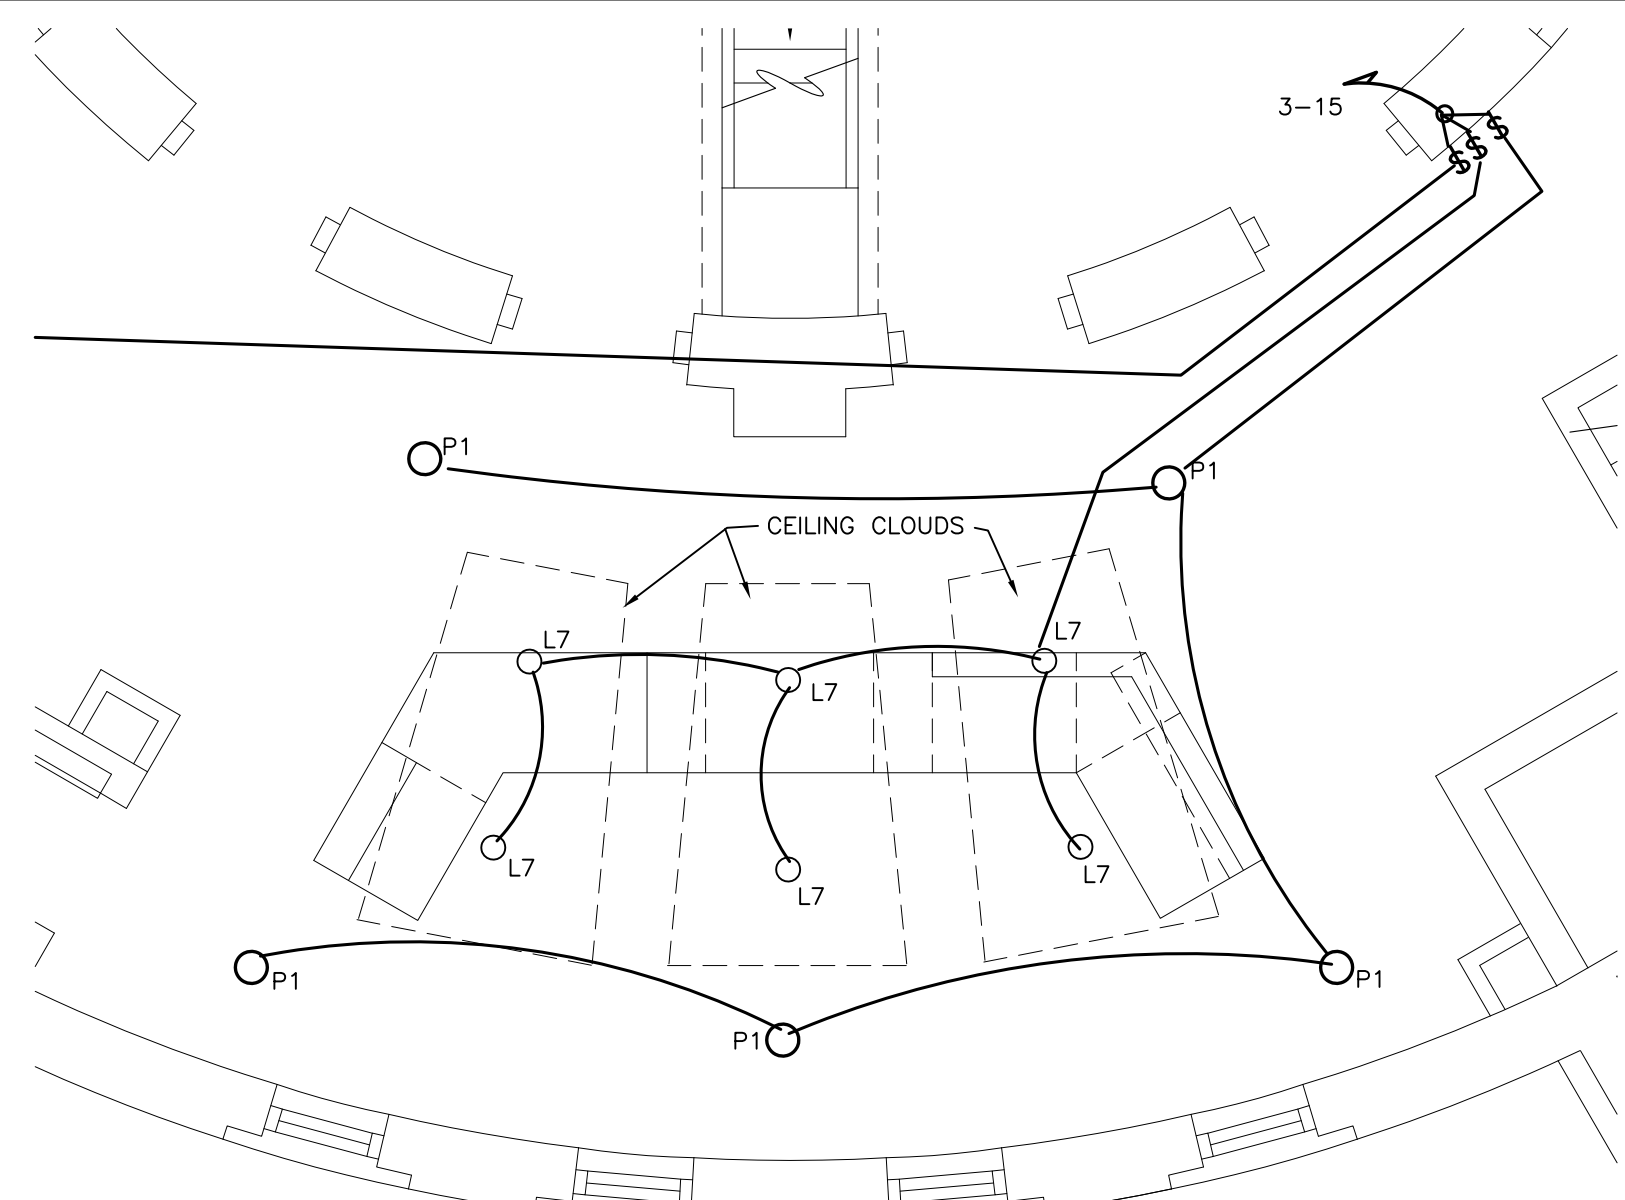SHEET NUMBER:
E-11



101 ALTERNATE LIGHTING
1/4" = 1'-0"

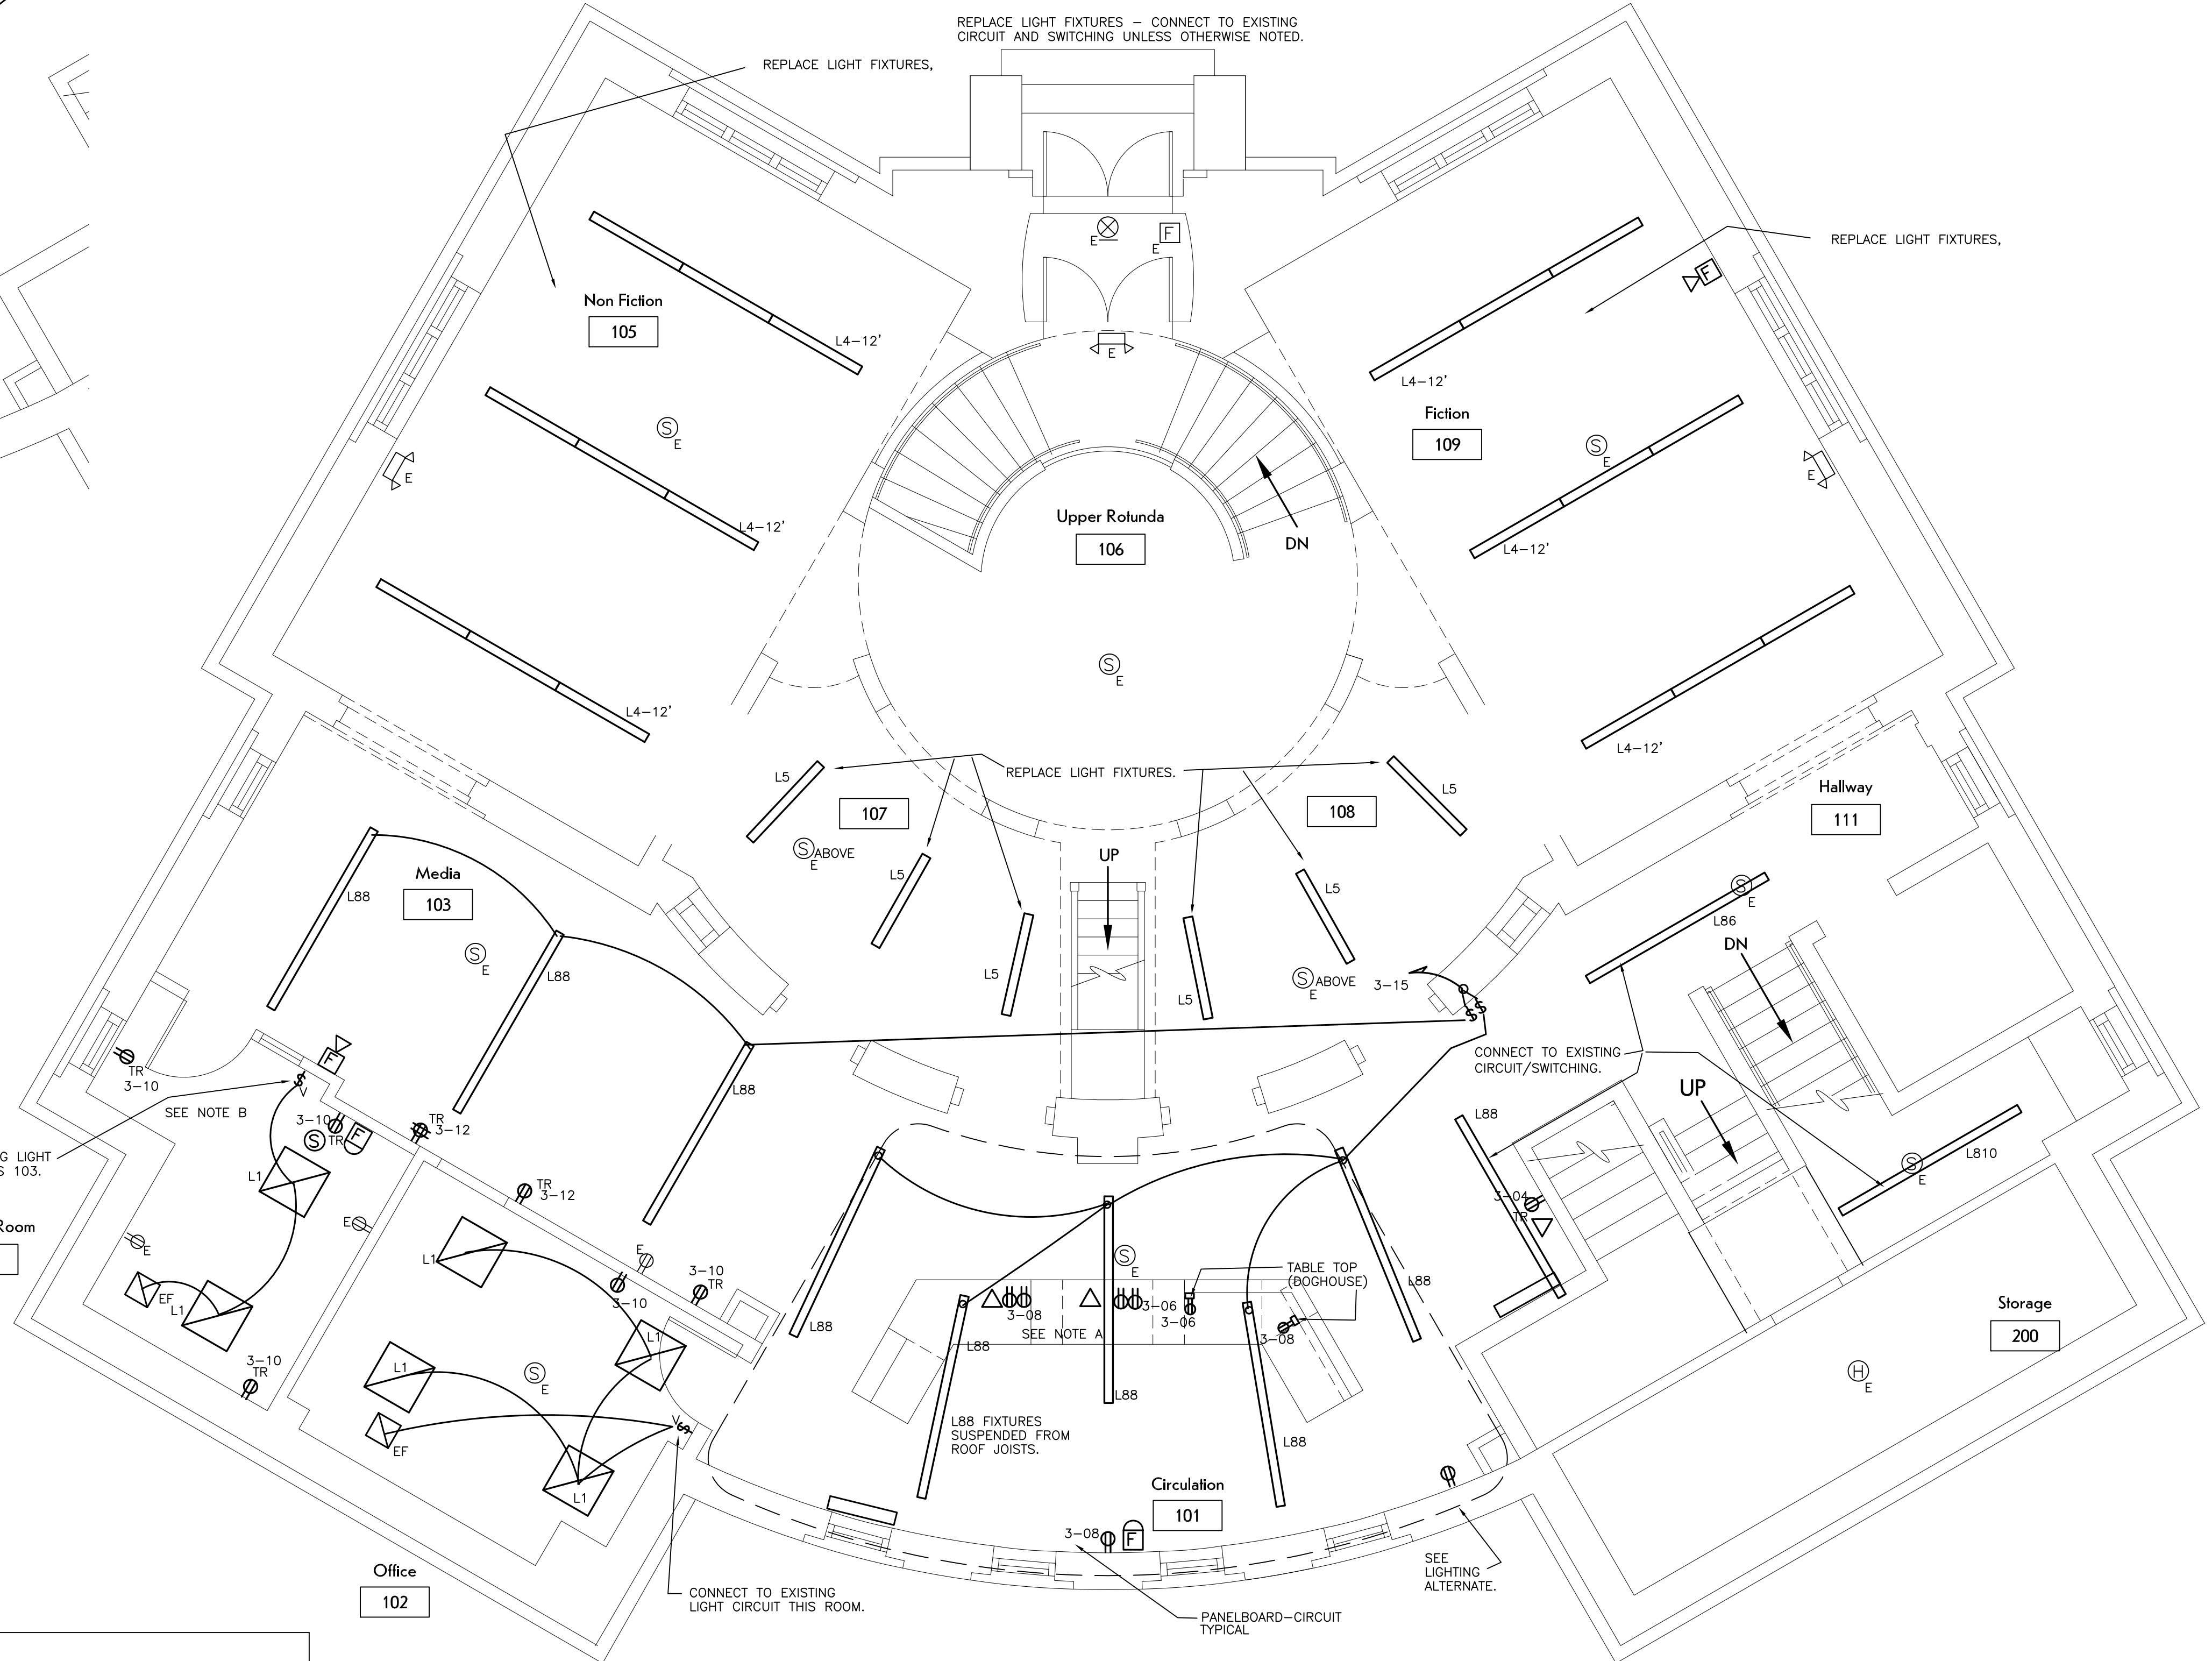

MAIN LEVEL FLOOR PLAN
1/4" = 1'-0"

LIGHT FIXTURE SCHEDULE			
FIXTURE	DESCRIPTION	LAMP	MODEL
L1	LED 2X2 LAY-IN FLAT PANEL, SWITCHABLE LUMENS	34W, 3200L, 3500K	LITHONIA CPX
L2	LED WALL SCONCE	16W 3500K	BROWNLEE 1450 *
L3	LED CEILING DRUM FIXTURE 48"	215W 3500K	BROWNLEE 2370 BAC *
L4	LED LINEAR SUSPENDED 2" DIRECT INDIRECT	600DL/FT, 300IDL/FT, 3500K	MARK S2PID *
L5	LED LINEAR SURFACE 24" LOW PROFILE	3500K	
L6	LED 2X4 LAY-IN FLAT PANEL DIMMABLE	34W, 3200L, 3500K	LITHONIA CPX
L86	LED 96" SUSPENDED LINEAR	50W, 6000L, 3500K	LITHONIA LL
L88	LED 96" SUSPENDED LINEAR	66W, 8000L, 3500K	LITHONIA LL
L810	LED 96" SUSPENDED LINEAR	79W, 10000L, 3500K	LITHONIA LL
LC	LED 48" STRIP DROP LENS		LITHONIA ZL1D
P1	LED PENDANT	3500K	GOTHAM IVO
L7	LED DOWN LIGHT 4"	3500K	GOTHAM IVO *
⊗	EXIT - LED, BATTERY		LITHONIA LQM S WR ELN SD
⊗	EXIT/EMERGENCY LIGHT - LED		LITHONIA LHQM LED R SD
⊕	EMERGENCY FIXTURE		LITHONIA ELM2 LED SD

120V UNLESS OTHERWISE NOTED
SPECIFIED FIXTURES REPRESENT MIN. EFFICIENCIES

COORDINATE WITH CEILING TYPE (LAY-IN CEILINGS, DRYWALL CEILINGS).



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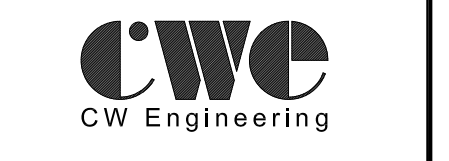
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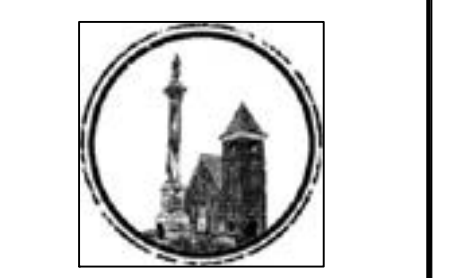
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SHEET TITLE:

MAIN LEVEL

SHEET NUMBER:

E-12

SHEET SCALE 1" ← →