CONSTRUCTION DOCUMENTS


EXPANSION AND RENOVATION Warsaw Public Library

130 North Main Street Warsaw, New York

FOR

Town of Warsaw

83 Center Street Warsaw, NY 14569

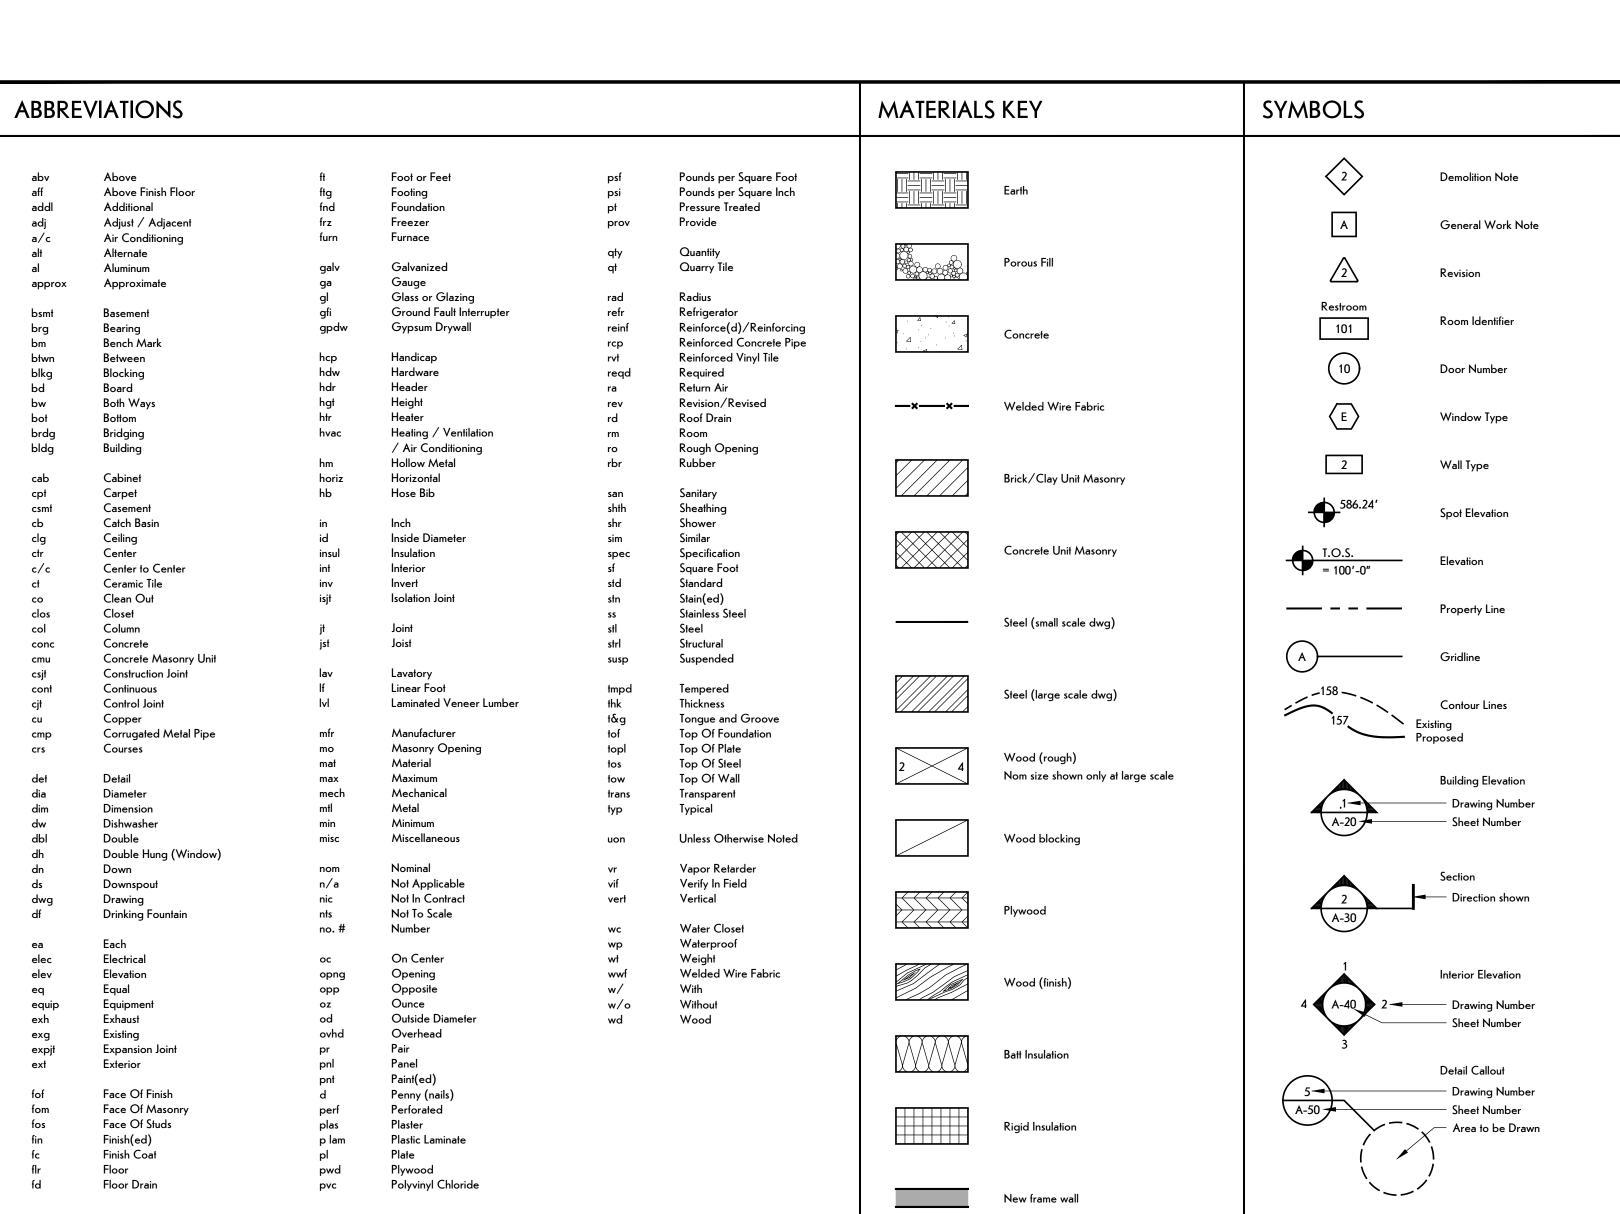



PROJECT TEAM:





STRUCTURAL ENGINEER:



1653 East Main Street Rochester, NY 14609

MEP/FP ENGINEER:



315 Rockingham Street Rochester, NY 14620

WARNING:

DRAWINGS, SPECIFICATIONS AND OTHER
DOCUMENTS, INCLUDING THOSE IN ELECTRONIC
FORM, PREPARED BY BERO ARCHITECTURE PLLC ARE
INSTRUMENTS OF SERVICE FOR USE SOLELY WITH
RESPECT TO THE PROJECT FOR WHICH THEY WERE
CREATED. THE ARCHITECT RETAINS ALL COMMON LAW,
STATUTORY AND OTHER RESERVED RIGHTS, INCLUDING

FOR ARCHITECTURAL DRAWINGS AND ELECTRONIC MEDIA, IT IS A VIOLATION OF TITLE VII, PART 69.5(B) OI THE NEW YORK STATE EDUCATION LAW FOR ANY PERSON, UNLESS ACTING UNDER THE DIRECTION OF A LICENSED ARCHITECT TO ALTER THIS DRAWING. IF ALTERED, SUCH ARCHITECT SHALL AFFIX THEIR SEAL, SIGNATURE, THE DATE, THE NOTATION "ALTERED BY", AND THE SPECIFIC DESCRIPTION OF THE ALTERATION.

WHERE DRAWINGS, ON PAPER OR ELECTRONIC MEDIA, SHOW EXISTING, NEW, AND/OR PROPOSED WORK AND CONDITIONS, IT IS UNDERSTOOD THAT IT IS SO SHOWN AS A MATTER OF INFORMATION AND THAT THE OWNER AND ARCHITECT, WHILE BELIEVING SUCH INFORMATION TO BE SUBSTANTIALLY CORRECT, ASSUME NO RESPONSIBILITY THEREFORE. THE USER SHALL MAKE THEMSELVES FAMILIAR WITH ALL CONDITIONS AFFECTING THE NATURE AND MANNER OF THEIR WORK INCLUDING VERIFICATION OF ALL DIMENSIONS LOCATING FIXETING PROPOSED.

AND/OR NEW WORK AND CONDITIONS.

| REVISIONS: | | | | | | | | | |
|------------|------|-------------|--|--|--|--|--|--|--|
| # | Date | Description | | | | | | | |
| | | | | | | | | | |
| | | | | | | | | | |
| | | | | | | | | | |
| | | | | | | | | | |

CLIENT / OWNER:



Town of Warsaw 83 Center Street Warsaw, NY 14569

PROJECT INFORMATION:

Expansion and Renovation Warsaw Public Library 130 North Main Street, Warsaw, New Yorl


PROJECT NUMBER: 22121

ISSUE DATE: April 25, 2025

DRAWN BY: LMY / TTN

SHEET TITLE:

Title Sheet

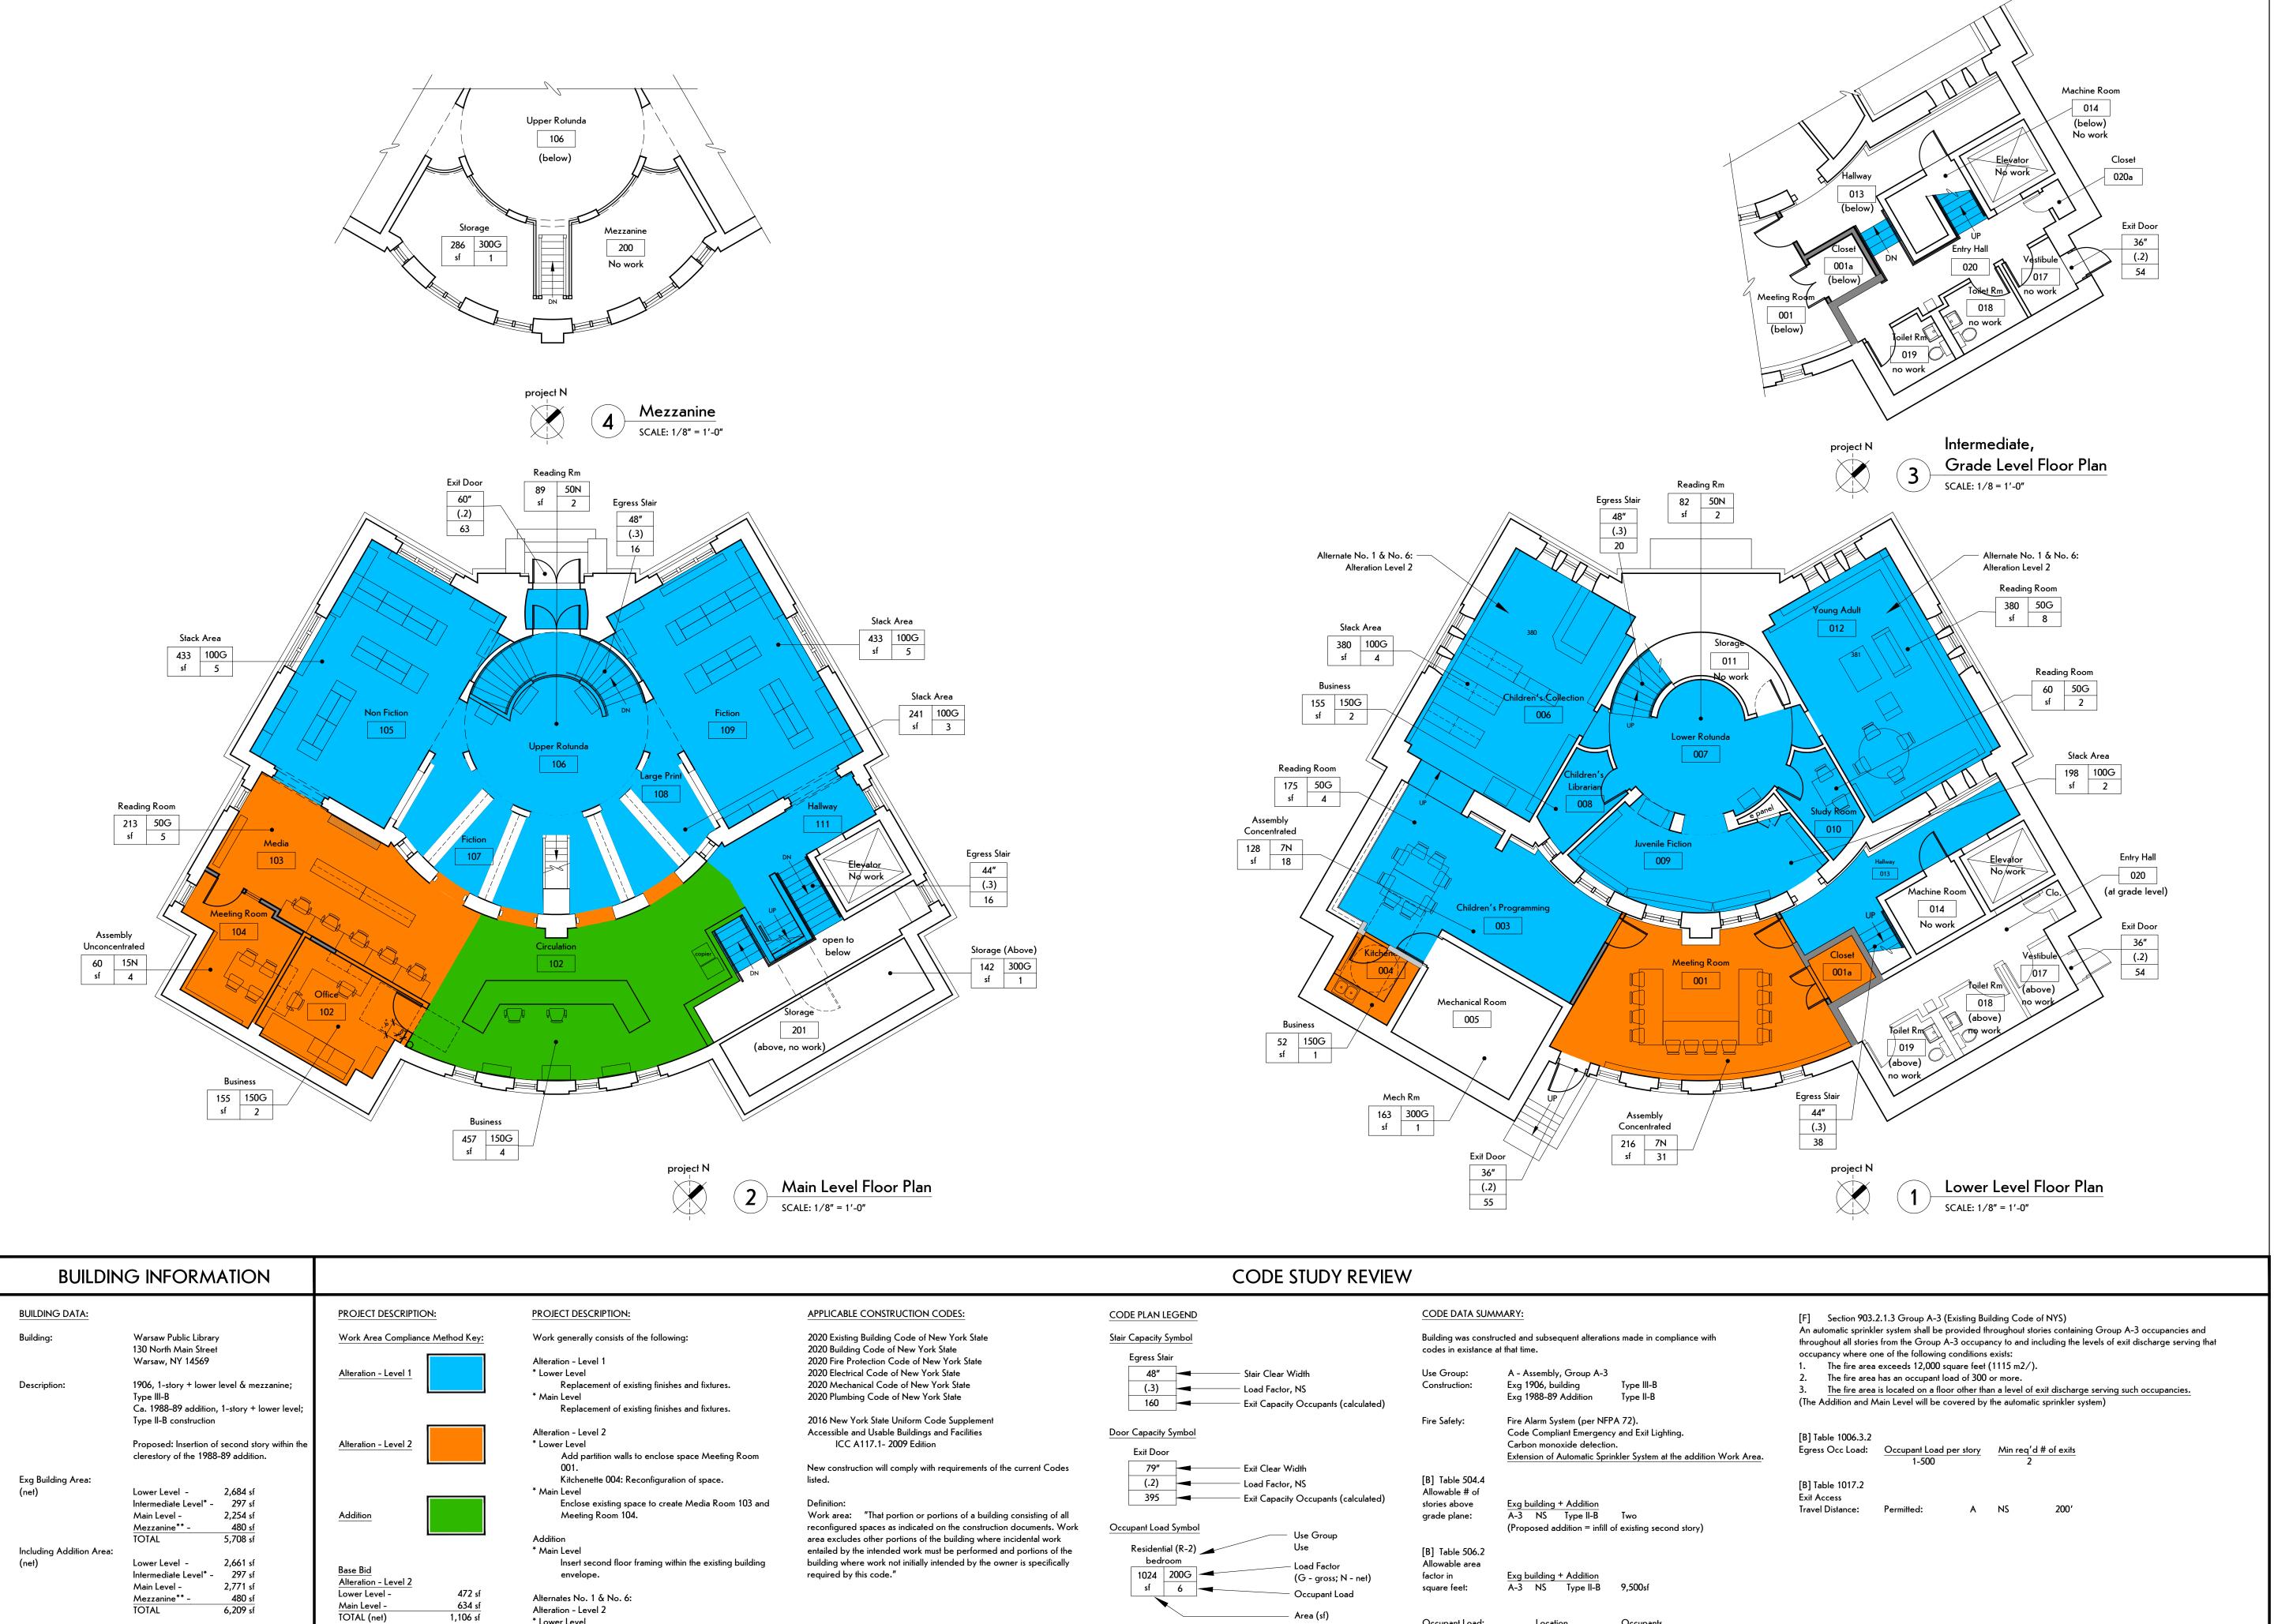

Occupant Load:

(calculated)

TOTAL

Location

First Floor

Lower Level

Mezzanine/Storage

Occupants

* Lower Level

498 sf

1,604 sf

adjacent spaces.

Children's Collection 006 & Young Adult 012:

Removal and replacement of existing floor to level with

*Includes entry level, vestibule, hallway,

**Includes Mezzanine 200 and Storage 201

Main Level

TOTAL (net)

Work Area:

TOTAL (net)

(26% of Building Total)

toilet rooms, and closet.





STRUCTURAL ENGINEER:



1653 East Main Street Rochester, NY 14609



MEP/FP ENGINEER:

315 Rockingham Street Rochester, NY 14620

WARNING: DRAWINGS, SPECIFICATIONS AND OTHER FORM, PREPARED BY BERO ARCHITECTURE PLLC ARE

INSTRUMENTS OF SERVICE FOR USE SOLELY WITH
RESPECT TO THE PROJECT FOR WHICH THEY WERE
CREATED. THE ARCHITECT RETAINS ALL COMMON LAW,
STATUTORY AND OTHER RESERVED RIGHTS, INCLUDING
COPYRIGHT. FOR ARCHITECTURAL DRAWINGS AND ELECTRONIC MEDIA, IT IS A VIOLATION OF TITLE VII, PART 69.5(B) OF THE NEW YORK STATE EDUCATION LAW FOR ANY

PERSON, UNLESS ACTING UNDER THE DIRECTION OF A LICENSED ARCHITECT TO ALTER THIS DRAWING. IF ALTERED, SUCH ARCHITECT SHALL AFFIX THEIR SEAL, SIGNATURE, THE DATE, THE NOTATION "ALTERED BY", AND THE SPECIFIC DESCRIPTION OF THE ALTERATION.

WHERE DRAWINGS, ON PAPER OR ELECTRONIC MEDIA, SHOW EXISTING, NEW, AND/OR PROPOSED WORK AND CONDITIONS, IT IS UNDERSTOOD THAT IT I SO SHOWN AS A MATTER OF INFORMATION AND THA THE OWNER AND ARCHITECT, WHILE BELIEVING SUCH INFORMATION TO BE SUBSTANTIALLY CORRECT, ASSUME NO RESPONSIBILITY THEREFORE. THE USER SHALL MAKE THEMSELVES FAMILIAR WITH ALL CONDITIONS AFFECTING THE NATURE AND MANNER
OF THEIR WORK INCLUDING VERIFICATION OF ALL DIMENSIONS LOCATING EXISTING, PROPOSED, AND/OR NEW WORK AND CONDITIONS.

REVISIONS: # Date Description

CLIENT / OWNER:



Town of Warsaw 83 Center Street Warsaw, NY 14569

PROJECT INFORMATION:

Expansion and Renovation Warsaw Public Library 130 North Main Street, Warsaw, New Yorl

PROJECT NUMBER: ISSUE DATE: April 25, 2025


DRAWN BY: SHEET TITLE:

Code Study

LMY / TTN

SHEET NUMBER: **CS-10**

EAST COURT STREET

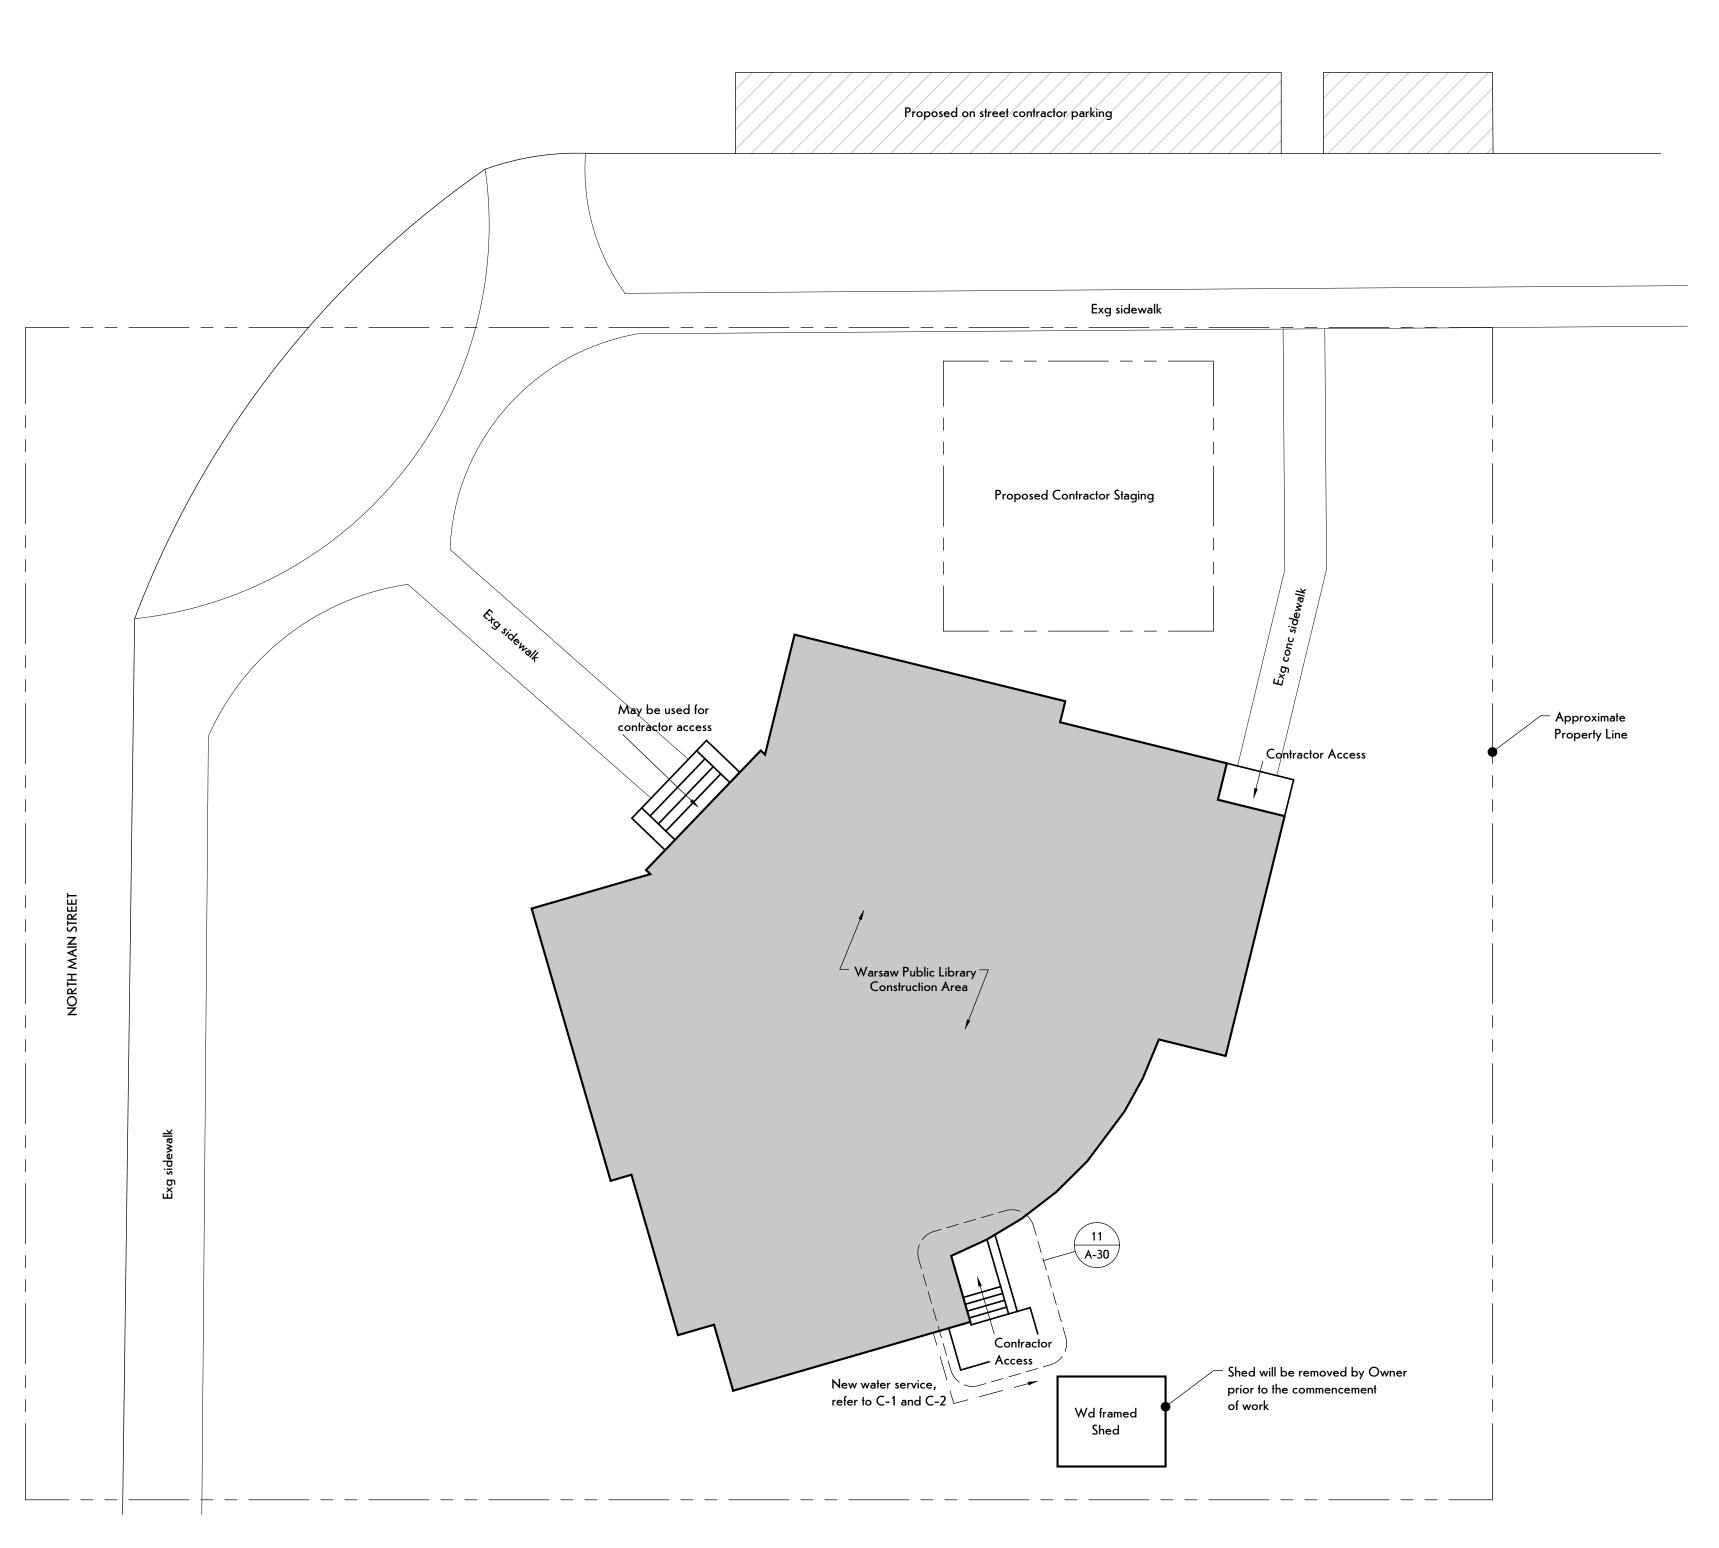

General Site Plan Notes:

- 1. Refer to drawings C-1 and C-2 for detailed site and water service information.
- 2. Protect persons, motor vehicles, surrounding surfaces of building, building site, plants, and surrounding buildings from harm resulting from alteration work.
- 3. Location of staging, storage, unloading, and contractor parking areas shall be reviewed, coordinated, and approved by Owner prior to commencement of work.
- Protect site improvements from damage. Restore damaged work to condition existing before start of site clearing. Protect trees and shrubs from damage and maintain vegetation.
- 5. Restore site to existing conditions at completion of project. Restore damaged improvements, if necessary, as acceptable to Owner.
- Determine location of existing utility services trenching. Comply with local utility service requirements. Contractor is responsible for verifying location of utilities at job site. Maintain existing utilities in service and protect them against damage during selective demolition operations.





STRUCTURAL ENGINEER:



1653 East Main Street Rochester, NY 14609

MEP/FP ENGINEER:



315 Rockingham Street Rochester, NY 14620

WARNING:

DRAWINGS, SPECIFICATIONS AND OTHER DOCUMENTS, INCLUDING THOSE IN ELECTRONIC FORM, PREPARED BY BERO ARCHITECTURE PLLC ARE INSTRUMENTS OF SERVICE FOR USE SOLELY WITH RESPECT TO THE PROJECT FOR WHICH THEY WERE CREATED. THE ARCHITECT RETAINS ALL COMMON LAW, STATUTORY AND OTHER RESERVED RIGHTS, INCLUDING COPYRIGHT.

FOR ARCHITECTURAL DRAWINGS AND ELECTRONIC MEDIA, IT IS A VIOLATION OF TITLE VII, PART 69.5(B) OF THE NEW YORK STATE EDUCATION LAW FOR ANY PERSON, UNILESS ACTING UNDER THE DIRECTION OF A LICENSED ARCHITECT TO ALTER THIS DRAWING. IF ALTERED, SUCH ARCHITECT SHALL AFFIX THEIR SEAL, SIGNATURE, THE DATE, THE NOTATION "ALTERED BY", AND THE SPECIFIC DESCRIPTION OF THE ALTERATION.

WHERE DRAWINGS, ON PAPER OR ELECTRONIC MEDIA, SHOW EXISTING, NEW, AND/OR PROPOSED WORK AND CONDITIONS, IT IS UNDERSTOOD THAT IT IS SO SHOWN AS A MATTER OF INFORMATION AND THAT THE OWNER AND ARCHITECT, WHILE BELIEVING SUCH INFORMATION TO BE SUBSTANTIALLY CORRECT, ASSUME NO RESPONSIBILITY THEREFORE. THE USER SHALL MAKE THEMSELVES FAMILIAR WITH ALL CONDITIONS AFFECTING THE NATURE AND MANNER OF THEIR WORK INCLUDING VERIFICATION OF ALL DIMENSIONS LOCATING EXISTING, PROPOSED, AND/OR NEW WORK AND CONDITIONS.

| REV | ISIONS: | | | | | |
|-----|---------|-------------|--|--|--|--|
| # | Date | Description | | | | |
| | | | | | | |
| | | | | | | |
| | | | | | | |

CLIENT / OWNER:



Town of Warsaw 83 Center Street Warsaw, NY 14569

PROJECT INFORMATION:

Expansion and Renovation Warsaw Public Library 130 North Main Street, Warsaw, New York

PROJECT NUMBER: 22121


ISSUE DATE: April 25, 2025

DRAWN BY: LMY / TIN

DRAWN BY:
SHEET TITLE:

Site & Staging Plan

SHEET NUMBER:

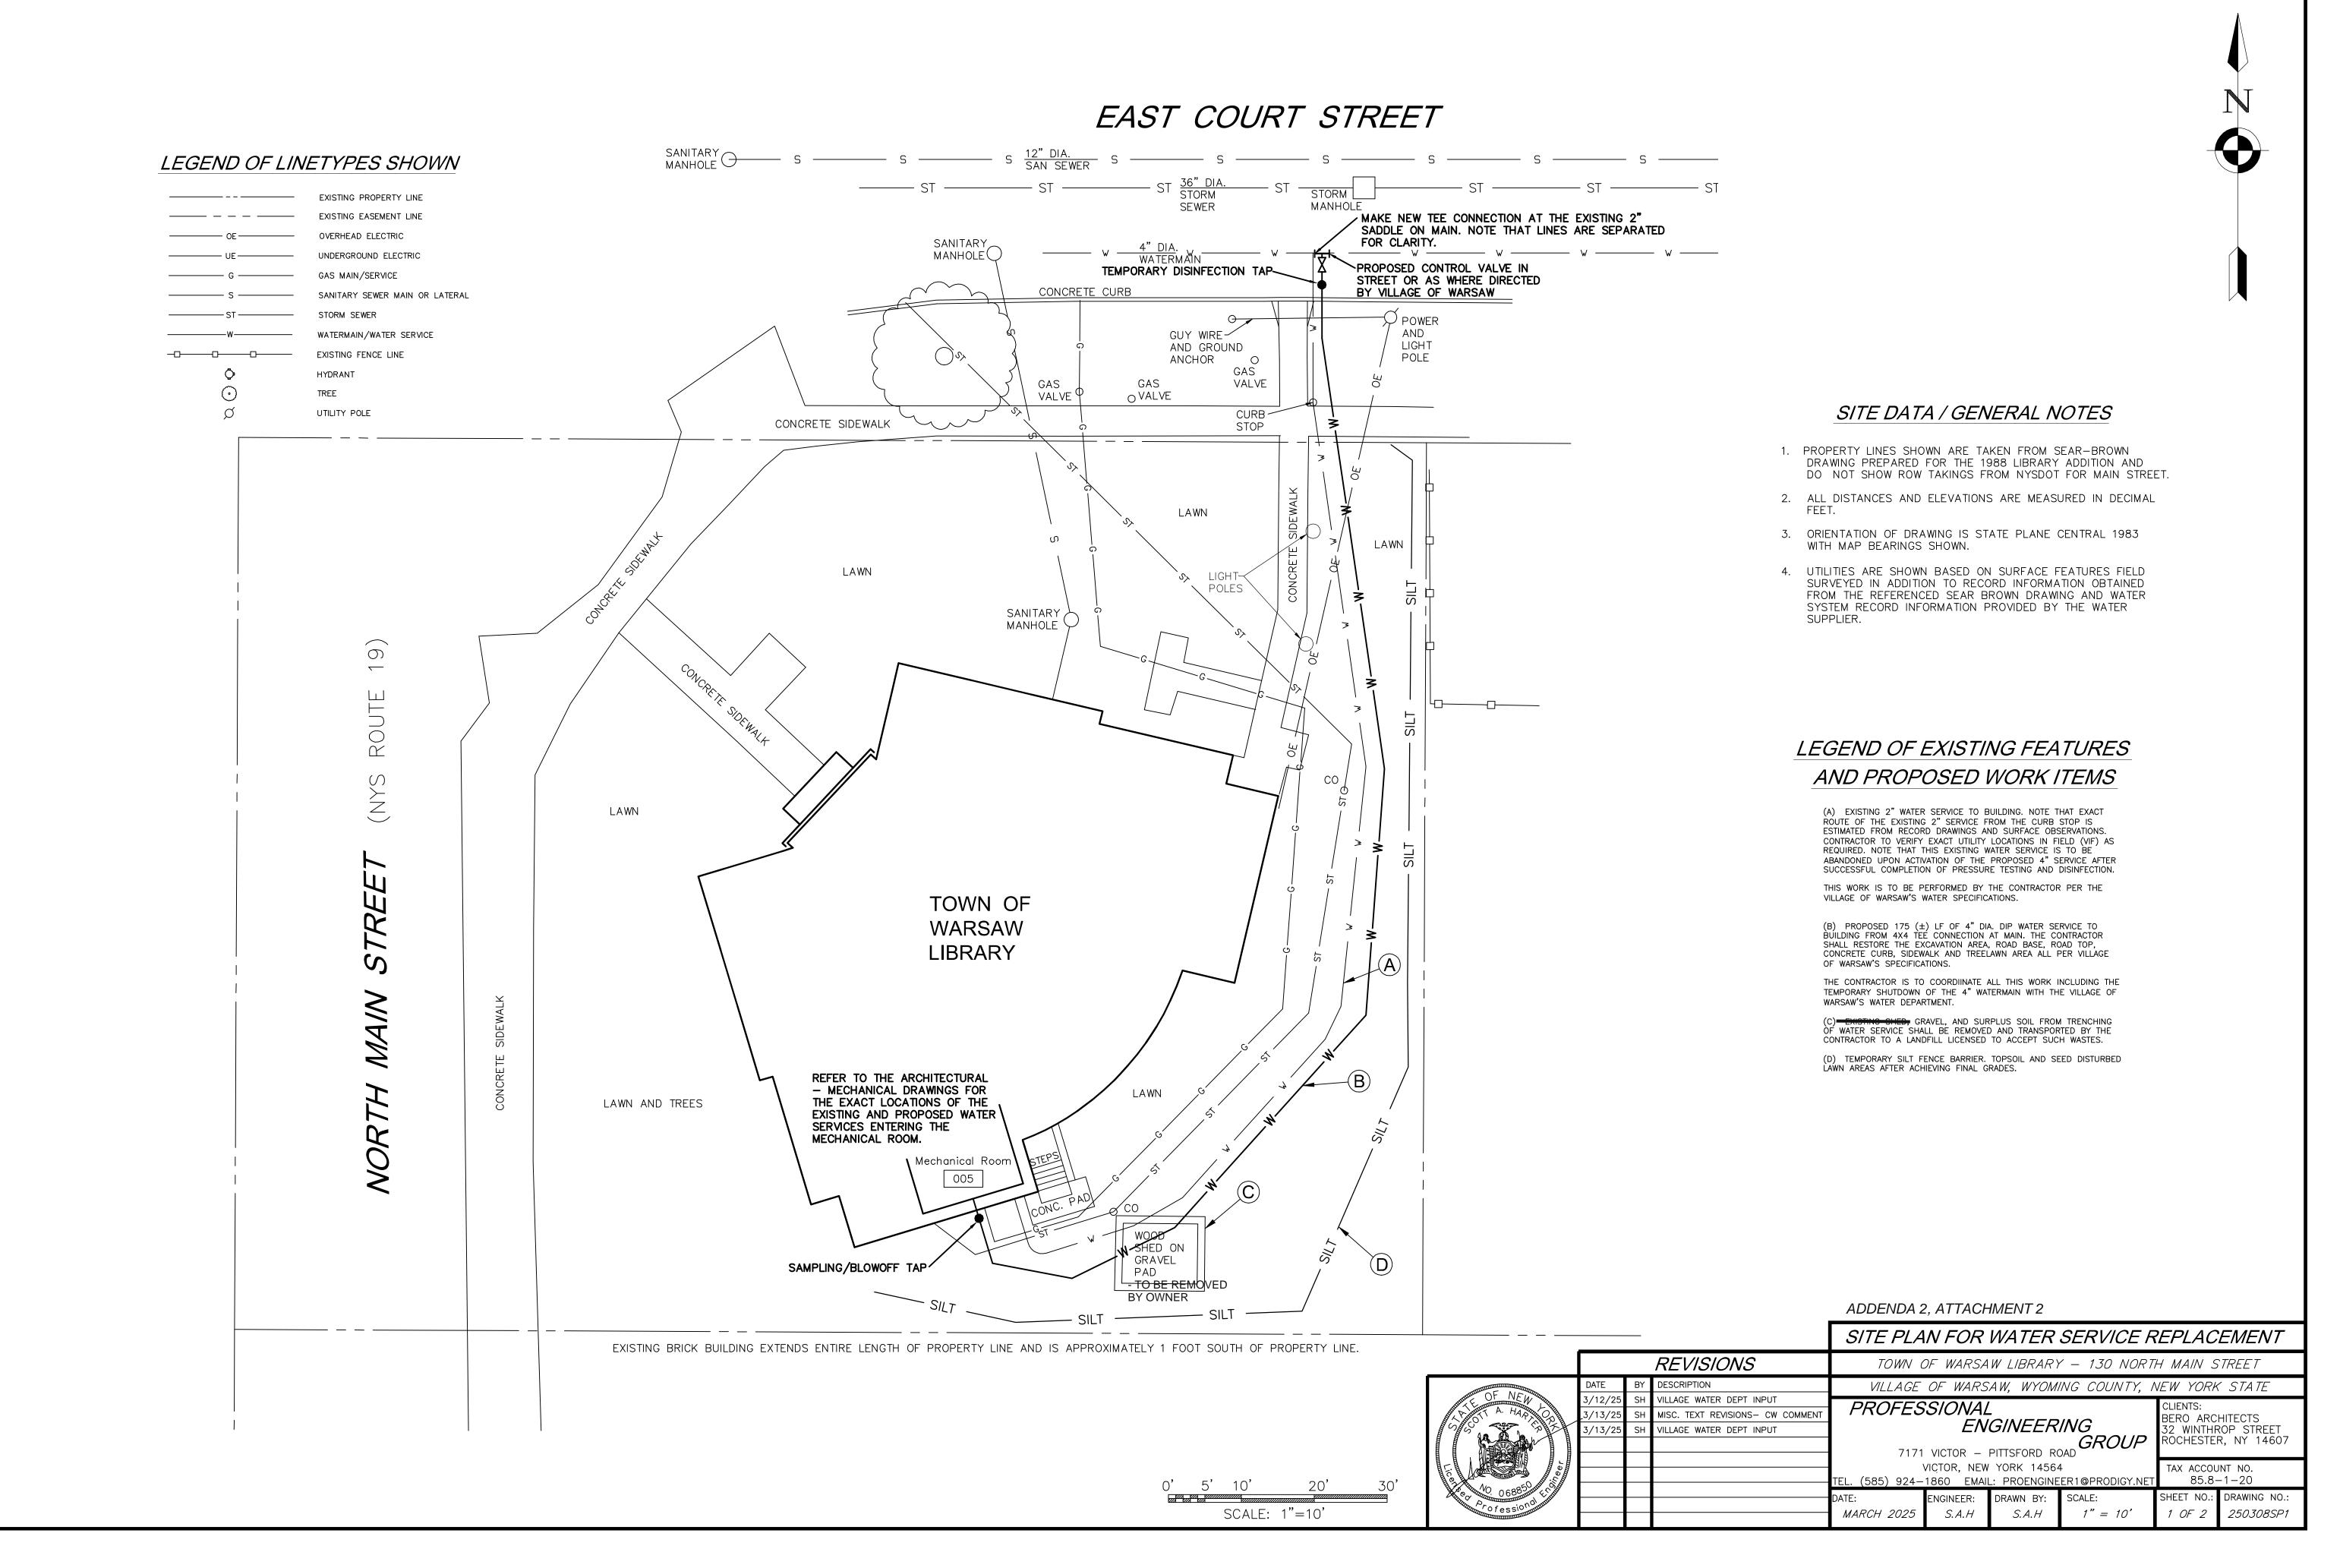

GENERAL & UTILITY NOTES

- SAFE AND CONTINUOUS TRAFFIC AND INGRESS AND EGRESS FOR ADJACENT OWNER DRIVEWAYS, SERVICE AND PUBLIC ROADS SHALL BE MAINTAINED THROUGH THE PERIOD OF CONSTRUCTION.
- 2. ALL CONSTRUCTION RELATED TO THIS PROJECT SHALL BE IN CONFORMANCE WITH ALL APPLICABLE LOCAL, STATE, AND FEDERAL REQUIREMENTS.
- 3. THE CONTRACTOR SHALL OBTAIN ALL APPROPRIATE PERMITS BEFORE BEGINNING ANY CONSTRUCTION.
- 4. THE CONTRACTOR IS REQUIRED TO NOTIFY CENTRAL STAKEOUT, TELEPHONE NO. 1-800-962-7962 (811) FOR FIELD STAKEOUT OF UNDERGROUND UTILITIES BEFORE COMMENCING CONSTRUCTION.
- 5. THE PROPOSED WATER APPURTENANCES SHALL CONFORM TO THE

LOCAL WATER AUTHORITY STANDARDS.

GRADING AND SEEDING HAS BEEN ESTABLISHED.

- 6. ALL WATER AND WASTEWATER APPURTENANCES SHALL CONFORM TO
- NEW YORK STATE HEALTH DEPARTMENT STANDARDS. 7. THE CONTRACTOR SHALL PROVIDE FOR EROSION CONTROL BARRIERS
- 8. THE CONTRACTOR SHALL BE REQUIRED TO CLEAN MUD AND DEBRIS FROM PUBLIC ROADS SERVICING THE CONSTRUCTION SITE DURING AND AFTER THE COMPLETION OF THE PROJECT.
- 9. THE CONTRACTOR SHALL NOTIFY AGENCIES PRIOR TO ANY EXCAVATING AND REQUEST SUCH UTILITY TO STAKE OUT WATER, GAS, ELECTRIC, AND/OR BURIED TELEPHONE LINES OR CABLES.

DURING CONSTRUCTION AND FOR THE REMOVAL OF THE SAME AFTER

- 10. THE CONTRACTOR SHALL USE DUE CAUTION IN PROTECTING PROPERTY MARKERS AND ALL ELEVATION SURVEY STAKES.
- 11. THE ACCURACY OF EXISTING UTILITIES ARE NOT GUARANTEED.
 EXISTING UTILITIES SHOWN ON THE PLANS ARE A RESULT OF THE BEST INFORMATION THAT COULD BE OBTAINED FROM FIELD SURVEYS AND RECORD MAPS AND ARE FOR GENERAL INFORMATION ONLY. IT SHALL BE THE CONTRACTOR'S RESPONSIBILITY TO DETERMINE THE LOCATION OF ALL PERTINENT UTILITIES BY FIELD INVESTIGATION. THE CONTRACTOR SHALL ALSO TAKE THE NECESSARY MEASURES TO PRESERVE AND PROTECT PROTECT EXISTING UTILIITES.
- 12. ALL ELECTRICAL WORK SHALL BE PERFORMED IN CONFORMANCE WITH ALL NEC AND UL ELECTRICAL CODES

- MINIMUM SEPARATION BETWEEN WATERMAIN AND SEWER MAINS TO BE 18" VERTICALLY MEASURED FROM THE OUTSIDE OF THE PIPES AT THE POINT OF CROSSING. MINIMUM HORIZONTAL SEPARATION BETWEEN WATERMAINS AND SEWER MAINS TO BE 10' (FEET) MEASURED FROM THE OUTSIDE OF THE PIPES. IF A CROSSING SHOULD OCCUR ONE FULL LENGTH OF THE SEWER SHALL BE CENTERED UNDER OR OVER THE WATERMAIN SO THAT BOTH THE JOINTS WILL BE AS FAR FROM THE SEWER AS POSSIBLE. WHERE A WATERMAIN CROSSES UNDER A SEWER ADEQUATE STRUCTURAL SUPPORT COMPACTED SELECT FILL SHALL BE PROVIDED FOR THE SEWER TO PREVENT SETTLING.
- ALL WATERMAINS AND SERVICES SHALL HAVE A MINIMUM OF 5' (FEET)
 OF COVER FROM THE TOP OF THE MAIN TO THE FINISHED GRADE. THE
 CONTRACTOR SHALL CHECK ALL CUT STAKES BEFORE TRENCHING TO INSURE THAT ALL INSTALLED WATERMAINS WILL HAVE THE REQUIRED COVER.
- 15. THE CONTRACTOR SHALL COMPLY WITH THE NEW YORK STATE INDUSTRIAL CODE, RULE 23, SUBPART 23-4 EXCAVATION OPERATIONS AND ALL APPLICABLE O.S.H.A. REQUIREMENTS SO AS TO PROVIDE SAFE EXCAVATION PROCEDURES.
- 16. IT IS THE CONTRACTOR'S RESPONSIBILITY TO TEMPORARILY SUPPORT AND MAINTAIN OTHER UTILITIES AS REQUIRED.
- 17. ALL TRAFFIC MAINTENANCE INCLUDING SIGNS, BARRICADES, LIGHTS AND OTHER TRAFFIC CONTROL DEVICES SHALL BE IN CONFORMANCE WITH THE REQUIREMENTS OF THE NEW YORK STATE MANUAL OF UNIFORM TRAFFIC CONTROL DEVICES.
- PROPOSED SLOPES SHALL NOT EXCEED 1 ON 3 EXCEPT WHERE NOTED.
- THE CONTRACTOR SHALL READ AND BECOME COMPLETELY FAMILIAR WITH THE APPROVED DESIGN PLANS. SHOULD THE CONTRACTOR HAVE ANY QUESTIONS CONCERNING THE PROJECT DESIGN, CONTACT THE DESIGN ENGINEER PRIOR TO COMMENCING CONSTRUCTION.

— 1" COPPER OR PLASTIC (MIN)

 CORPORATION STOP - PROPOOSED 4" WATER SERVICE

1" CURB STOP


NOTE: IN THE PRESENCE OF A WATER AUTHORITY REPRESENTATIVE REMOVE ALL CORPORATIONS ASSOCIATED WITH TEMPORARY DISINFECTION/SAMPLE TAPS AND REPLACE WITH THREADED BRASS PLUGS.

DISINFECTION/BLOW-OFF/SAMPLING TAP (TEMPORARY) NOT TO SCALE

VALVE BOX — EXTENSION -BASE-TYPE 7 SELECT FILL FOR WIDTH OF TRENCH AROUND VALVE BOX SOLID CONCRETE BLOCK-(MIN: 4"x 8"x16" UP TO 12" VALVE 8"x8"x16" LARGER THAN 12" VALVE)

- 1. VALVE BOX SHALL BE CENTERED ON VALVE AND SET ON COMPACTED BACKFILL.
- 2. VALVE SHALL NOT SUPPORT VALVE BOX.
- 3. ALL VALVES SHALL BE OPEN LEFT

VALVE NOT TO SCALE

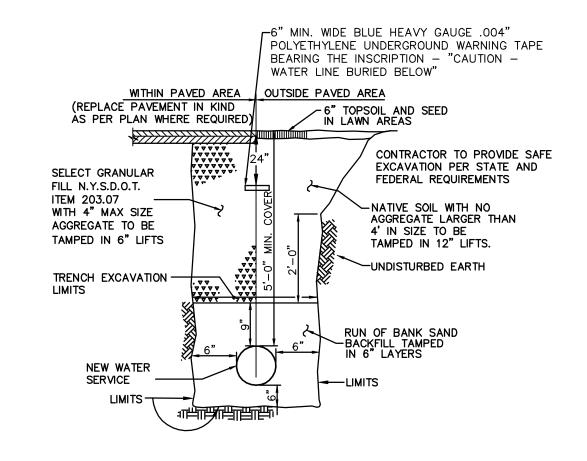

TYPICAL WATER SERVICE TRENCH DETAIL

N.T.S.

PERMANENT SEEDING

- 1. REPLACE TOPSOIL TO A MINIMUM DEPTH OF 6 INCHES.
- 2. SEED 20 POUNDS OF PERENNIAL RYEGRASS PER ACRE AND 80 POUNDS PER ACRE OF KENTUCKY BLUEGRASS OR EQUIVALENT.
- 3. FERTILIZE WITH 600 POUNDS PER ACRE OF 10-10-10. LIME TO ACHIEVE A PH OF 6.0. IF HYDROSEEDER IS NOT USED, SEED AND FERTILIZER SHOULD BE LIGHTLY RAKED INTO SOIL.
- 4. MULCH WITH CLEAN (WEED FREE) STRAW.

FABRIC OR EQUAL (STAPLE TO LATH) 2 1/2'± BURY END 2**'**± IT SHALL BE THE RESPONSIBILITY OF THE CONTRACTOR TO PROVIDE AND INITITIALIZE EROSION CONTROL MEASURES. SILT FENCE IS TO BE MAINTAINED TO THE SATISFACTION OF THE TOWN OF HENRIETTA'S PROJECT REPRESENTATIVE AND WILL BE REMOVED BY THE CONTRACTOR ONCE GROUND COVER IS RE-ESTABLISHED AND APPROVAL TO REMOVE IS CONFIRMED WITH THE VILLAGE.

MIRAFI FILTER

SILT FENCE DETAIL

R:\DETAILS\DME\2016 DME DETAILS\DME 6.DWG 1 DEGREE 22 DEGREE 45 DEGREE 90 DEGREE DIAMETER 2 0.4 0.2 2 0.8 0.4 2 1.6 0.8 2 3 1.5 2 3.5 1.5 * SIZE BLOCK BASED ON BRANCH DIAMETER. SOIL BEARING STRENGTH - 3000 PSF 150 PSI TEST PRESSURE HORIZONTAL AND VERTICAL UP THRUST BLOCKS BOND BREAKER CONCRETE THRUST BLOCK -UNDISTURBED SOIL BEND PROFILE BEND ELEVATION VERTICAL UP THRUST BLOCKS NOT TO SCALE -CONCRETE THRUST BLOCK -UNDISTURBED SOIL -BOND BREAKER TEE ELEVATION TEE PLAN CONCRETE THRUST BLOCK UNDISTURBED SOIL UNDISTURBED SOIL-BEND ELEVATION HORIZONTAL THRUST BLOCKS NOT TO SCALE MONROE COUNTY WATER AUTHORITY ROCHESTER, NEW YORK DME 6

WATER SERVICE LINE NOTES

- WATER SERVICE LINES SHALL BE CONSTRUCTED IN ACCORDANCE WITH THE REGULATIONS AND SPECIFICATIONS OF THE LOCAL WATER AUTHORITY.
- 2. WATER SERVICE LINES SHALL HAVE A MINIMUM OF FIVE FEET OF COVER FROM FINISHED GRADE IN LAWN AREAS AND SIX FEET OF COVER FROM FINISHED GRADE IN PAVED AREAS.
- WATER SERVICE LINES SHALL BE SEPARATED AT LEAST TEN FEET HORIZONTALLY AS MEASURED FROM
- THE OUTSIDE OF THE WATER PIPES, TO SEWER MAINS OR SEPTIC SYSTEM COMPONENTS. WATER SERVICE LINES SHALL BE SEPARATED AT LEAST 1.5 FEET VERTICALLY AS MEASURED FROM
- THE OUTSIDE OF THE WATER PIPES, TO SEWER MAINS OR SEPTIC SYSTEM COMPONENTS.
- 5. WATER SERVICE LINES SHALL BE IDENTIFIED AS:

| DESCRIPTION | SIZE | MATERIAL (A) | TYPE (B) |
|---|---------|--------------|----------|
| MUNICIPAL PORTION=FROM THE WATERMAIN TO AND INCLUDING THE CONTROL VALVE ON THE ROW/PROPERTY/EASEMENT LINE | 4" DIA. | D.I.P. | DS |
| PRIVATE PORTION = FROM THE CONTROL VALVE TO THE METER | 4" DIA. | D.I.P. | DS |

- (A) ACCEPTABLE MATERIAL FOR PRIVATE PORTION IS CLASS 52 CEMENT MORTAR LINED DUCTILE IRON PIPE.
- (B) SERVICE TYPES INCLUDE: DOMESTIC=DS, FIRE =FS, OR COMBINED=CMB
- 6. THE MUNICIPAL PORTION OF THE WATER SERVICE SHALL BE INSTALLED PRIOR TO THE PRIVATE PORTION OF THE SERVICE LINE.
- 7. WATER SERVICE LINES SIZED 4" OR LARGER SHALL BE:
 - PRESSURE TESTED IN ACCORDANCE WITH THE LATEST SPECIFICATIONS OF THE LOCAL WATER AUTHORITY. THE LOCAL WATER AUTHORITY MUST WITNESS THIS TEST.
 - DISINFECTED BY USING THE CONTINUOUS FEED METHOD ACCORDING TO THE LATEST AWWA STANDARD SPECIFICATIONS, AFTER FLUSHING AND DISINFECTING THE SERVICE LINE, WATER SAMPLES SHALL BE COLLECTED IN ACCORDANCE WITH THE LOCAL HEALTH DEPARTMENT'S REQUIREMENTS. APPROVAL AND NOTIFICATION BY THE HEALTH DEPARTMENT MUST BE RECEIVED BEFORE THE WATER SERVICE CAN BE ACTIVATED BY THE LOCAL WATER

ADDENDA 2, ATTACHMENT 3

| | | | | DETAIL SHEET | | | | | | |
|-------------------|----------|----|--------------------------|--------------------------------|--|-----------------------------|-----------------------|-----------------------------------|--------------------------------------|--|
| | | | REVISIONS | TOWN | TOWN OF WARSAW LIBRARY — 130 NORTH MAIN STREET | | | | | |
| OF NE | DATE | BY | | | OF WARS | SAW, WYOM | ING COUNTY, I | VEW YORK | (STATE | |
| A. HAM. | 3/12/25 | | VILLAGE WATER DEPT INPUT | PROFESSIONAL | | | | | CLIENTS: | |
| | _3/13/25 | SH | MISC. TEXT REVISIONS | 1 | EΛ | PITTSFORD R | GROUP | BERO ARC 32 WINTHE ROCHESTE | HITECTS ROP STREET R, NY 14607 | |
| | | | | | | V YORK 1456 L: PROENGINE | 4 EER1@PRODIGY.NET | TAX ACCOU 85.8- | JNT NO. -1-20 | |
| Professional City | | | | — DATE: — <i>MARCH 2025</i> | ENGINEER: S.A.H | DRAWN BY: S.A.H | SCALE: AS SHOWN | SHEET NO.: 2 OF 2 | DRAWING NO.: 250308DT1 | |

GENERAL CONDITIONS

1.) THE INFORMATION SHOWN ON THESE DOCUMENTS IS THE BEST REPRESENTATION OF EXISTING CONDITIONS AVAILABLE TO THE ENGINEER. IT IS THE CONTRACTORS RESPONSIBILITY TO FIELD VERIFY THOSE FEATURES WHICH WILL AFFECT THE BID PRICE AND MAKE ALLOWANCES FOR THEM IN THEIR BID.

2.) EXISTING CONDITIONS: VERIFY DIMENSIONS, ELEVATIONS, AND MEMBER SIZES AS SHOWN ON THESE DRAWINGS AND NOTIFY THE A/E OF DISCREPANCIES PRIOR TO COMMENCING WORK.

3.) DIMENSIONS, ELEVATIONS, AND MEMBER SIZES SHOWN ARE CONSIDERED APPROXIMATE. THE CONTRACTOR SHALL ACCURATELY DETERMINE DIMENSIONS, ELEVATIONS, AND MEMBER SIZES OF EXISTING CONSTRUCTION.

4.) EXISTING CONSTRUCTION ADJACENT TO NEW WORK SHALL BE ADEQUATELY SUPPORTED DURING CONSTRUCTION. THE CONTRACTOR SHALL REPAIR NEW OR EXISTING CONSTRUCTION DAMAGED WHILE WORK IS IN PROGRESS.

5.) THE DRAWINGS REPRESENT THE FINISHED STRUCTURE AS A COMPLETE UNIT. THE CONTRACTOR SHALL BE RESPONSIBLE FOR MEANS, METHODS, AND SEQUENCES OF DEMOLITION AND CONSTRUCTION PHASES INCLUDING TEMPORARY SHORING AND BRACING. THE CONTRACTOR SHALL COMPLY WITH ALL APPLICABLE CODES AND STANDARDS THAT PERTAIN TO MEANS, METHODS, AND SEQUENCES OF CONSTRUCTION.

6.) CONTRACT DRAWINGS AND SPECIFICATIONS: COORDINATE STRUCTURAL DRAWINGS WITH ALL OTHER DRAWINGS AND SPECIFICATIONS. INCORPORATE COORDINATION REQUIREMENTS INTO CONTRACTOR'S WORK.

7.) DETAILS NOT SPECIFICALLY SHOWN SHALL BE SIMILAR TO THOSE SHOWN FOR THE MOST NEARLY SIMILAR CONDITION AS DETERMINED BY THE ARCHITECT OR ENGINEER.

8.) WHERE DEMOLITION OR OTHER MODIFICATIONS TO THE EXISTING STRUCTURE ARE REQUIRED: THE CUTTING, DRILLING, AND REMOVAL SHALL OCCUR IN A MANNER WHICH WILL PREVENT DAMAGE TO ADJOINING CONSTRUCTION TO REMAIN. UNLESS OTHERWISE INDICATED. PROVIDE NEW MATERIALS TO MATCH THE APPEARANCE AND PERFORMANCE OF EXISTING CORRESPONDING MATERIALS WHERE

9.) SHOP DRAWINGS PREPARED BY SUPPLIERS AND SUBCONTRACTORS SHALL BE REVIEWED AND SIGNED AND STAMPED BY THE CONTRACTOR PRIOR TO SUBMISSION TO THE ARCHITECT AND ENGINEER. REPRODUCTIONS OF THE STRUCTURAL DRAWINGS SHALL NOT BE USED FOR THE PREPARATION OF SHOP DRAWINGS. MANUFACTURED COMPONENTS SHALL BE SIGNED AND STAMPED BY A LICENSED PROFESSIONAL ENGINEER PRIOR TO SUBMISSION.

STRUCTURAL LOADS AND CRITERIA

- DESIGN AND CONSTRUCTION: <u>NEW YORK STATE UNIFORM FIRE PREVENTION AND BUILDING CODE</u> (UNIFORM CODE) ACCORDING TO THE 2020 BUILDING CODE OF NEW YORK STATE (BCNYS).
- A. RISK CATEGORY II
- 2. LIVE LOADS:
- NEW ELEVATED FLOORS = 150 PSF (STACK ROOM)
- DEAD LOADS: WEIGHT OF CONSTRUCTION MATERIALS PLUS 8PSF COLLATERAL (MEP)
- DESIGN GUARDRAILS AND HANDRAILS AND INCORPORATE INTO STEEL SHOP DRAWINGS AS FOLLOWS: (LIVE LOADS SHOWN ARE IN ADDITION TO DEAD LOAD)
- A. HANDRAIL ASSEMBLIES: LOAD PRODUCING GREATEST STRESS OF 200 LB OR 50 PLF. APPLIED IN ANY DIRECTION AT ANY POINT ON THE ASSEMBLY.
- MEET BCNYS REQUIREMENTS FOR DETAILS AND DIMENSIONS NOT SPECIFICALLY INDICATED. COORDINATE FINAL DESIGN WITH ARCHITECTURAL DRAWINGS AND PROJECT SPECIFICATIONS.
- MEMBER SIZES SHOWN ON DRAWINGS ARE MINIMUM.
- FRAMING DETAILS SHOWN ARE SCHEMATIC. CONTRACTOR TO PROVIDE ADEQUATE SUPPLEMENTAL FRAMING AS NEEDED TO SUPPORT STAIR AND RAILING COMPONENTS.

MASONRY NOTES

- 1.) CONCRETE MASONRY DESIGN AND CONSTRUCTION SHALL CONFORM TO ACI 530 AND 530.1.
- 2.) CONCRETE MASONRY UNITS: ASTM C-90. UNIT COMPRESSIVE STRENGTH = 2800 PSI.
- 3.) CMU MORTAR: ASTM C270 TYPE M OR S.
- 4.) HORIZONTAL JOINT REINFORCING: ASTM A82, 9 GA, GALVANIZED LADDER-TYPE,16" O/C UNO.
- 5.) BLOCK CORE GROUT FILL: ASTM C476, 3,000 PSI MINIMUM 28 DAY COMPRESSIVE STRENGTH. PLACE IN LIFTS NOT EXCEEDING 7 COURSES IN HEIGHT UNLESS OTHERWISE APPROVED BY THE ENGINEER.
- 6.) PROVIDE FULL HEAD AND BED JOINTS.
- MASONRY WALLS, PARTITIONS, AND OPENINGS: COORDINATE WITH ARCHITECTURAL DRAWINGS.
- 8.) LAP SPLICES IN VERTICAL REINFORCING: 48 BAR DIAMETERS MINIMUM, UNO.

9.) STRUCTURAL STEEL LINTELS: 8" MINIMUM BEARING AT EACH END, HOT DIP GALVANIZE EXTERIOR

10.) MASONRY COURSING INDICATED ON THE STRUCTURAL DRAWINGS IS APPROXIMATE. REFER TO

ARCHITECTURAL DRAWINGS FOR ACTUAL COURSING LAYOUT. CUT UNITS AS REQUIRED TO ACHIEVE ELEVATIONS, BEARING ELEVATIONS, AND OPENINGS INDICATED.

11.) SECURE REINFORCING STEEL IN PLACE PRIOR TO PLACING GROUT. DO NOT WET-SET REINFORCING.

- 12.) ADHESIVE ANCHORS: LOCATE AWAY FROM REBAR.
 - a. GROUTED CMU = HILTI HY200 OR POWERS AC100+ OR SIMPSON SET b. HOLLOW CMU = HILTI HY70 OR POWERS AC100+ OR SIMPSON ACRYLIC-TIE

13.) SHOP DRAWINGS: SUBMIT FOR REINFORCING STEEL, GROUT AND MORTAR MIX DESIGNS, AND CMU PRODUCT DATA TO THE ARCHITECT FOR REVIEW BEFORE CONSTRUCTION.

STEEL NOTES

- 1. STRUCTURAL STEEL SHALL CONFORM TO THE AMERICAN INSTITUTE OF STEEL CONSTRUCTION (AISC) AISC 360 - SPECIFICATION FOR STRUCTURAL STEEL BUILDINGS AND AISC 303 - CODE OF STANDARD PRACTICE FOR STEEL BUILDINGS AND BRIDGES.
- 2. STRUCTURAL STEEL GRADES (UNLESS NOTED OTHERWISE): A. W-SECTIONS: ASTM A572 (ASTM A992), Fy = 50KSI
- B. ANGLES, PLATES & CHANNELS: ASTM A36, Fy = 36ksi C. HOLLOW STRUCTURAL SECTIONS (HSS): ASTM A500 GRADE B/C
- D. BOLTS: ASTM A325N
- E. SHEAR CONNECTORS: ASTM A108 F. WELDS: E70xx
- 3. WELDING: AWS D1.1. ALL-AROUND FILLET WELDS FOR STEEL CONNECTIONS NOT INDICATED.
- 4. STRUCTURAL STEEL FINISH: AS INDICATED BELOW. COORDINATE WITH THE ARCHITECTURAL DRAWINGS AND SPECIFICATIONS. APPLY COATINGS IN ACCORDANCE WITH MANUFACTURERS RECOMMENDATIONS, INCLUDING SURFACE PREPARATIONS. AFTER ERECTION TOUCH UP AREAS WHERE PAINT OR GALVANIZING IS MISSING OR DAMAGED INCLUDING FIELD WELDS. VERIFY COMPATIBILITY BETWEEN ALL LAYERS OF COATINGS. COLORS SELECTED BY ARCHITECT.
- A. HOT-DIP GALVANIZE: LINTELS IN EXTERIOR WALLS. B. ALL OTHER STRUCTURAL STEEL SHALL BE SHOP PAINTED WITH A MODIFIED ALKYD RUST INHIBITIVE PRIMER, 2.5 TO 3.5 MILS DFT (BASIS OF DESIGN IS TNEMEC SERIES 10).
- 5. **SHOP DRAWINGS:** SUBMIT FOR REVIEW PRIOR TO FABRICATION

STEEL DECK

- 1.) STEEL DECK SHALL CONFORM TO THE STEEL DECK INSTITUTE'S CODE OF STANDARD PRACTICE, SDI-C1.0 STANDARD FOR COMPOSITE STEEL FLOOR DECK, AND SDI-NC1.0 STANDARD FOR NON-COMPOSITE STEEL FLOOR DECK.
- 2.) COMPOSITE STEEL DECK: FASTEN TO SUPPORTS ACCORDING TO SDI RECOMMENDATIONS. COMPOSITE STEEL DECK SHALL HAVE A GALVANIZED FINISH (G-60).
- 3.) SUBMIT SHOP DRAWINGS FOR STEEL DECK FOR REVIEW PRIOR TO CONSTRUCTION.

CONCRETE NOTES

- 1.) CONCRETE DESIGN AND CONSTRUCTION: ACI 318, ACI 301, AND PROJECT SPECIFICATIONS.
- 2.) MINIMUM COMPRESSIVE STRENGTH AT 28 DAYS:
- INTERIOR SLABS ON GRADE: 3,000 PSI, 1 1/2" MAX COURSE AGGREGATE, MAX. W/C RATIO = 0.54 ELEVATED SLABS: 3,500 PSI, AIR ENTRAINMENT 6%, NORMAL WEIGHT
- 3.) LEVELING GROUT: NON-SHRINK, ASTM C1107, 5,000 PSI MINIMUM 2-DAY COMPRESSIVE STRENGTH.
- 4.) REINFORCING STEEL: ASTM A615, GRADE 60 WELDED REINFORCING BARS: ASTM A706 AND AWS D1.4
- WELDED WIRE FABRIC: ASTM A185, SUPPLIED IN SHEETS 5.) REINFORCING BAR FABRICATION: ACI 318 FOR HOOKS AND BENDS UNO.
- 6.) SECURE REINFORCEMENT: PROVIDE ACCESSORIES, CHAIRS, SPACERS, AND SUPPORTS
- 7.) LAP SPLICES: ACI-318 CLASS "B" TENSION LAP UNO.
- 8.) CONCRETE TESTING:
- A.) (1) ONE COMPOSITE SAMPLE FOR SLAB-ON-DECK CONSTRUCTION
- B.) OBTAIN: SLUMP (ASTM C 143), AIR CONTENT (ASTM C 231), TEMPERATURE (ASTM C 1064), AND UNIT WEIGHT (ASTM C 567) FOR EACH COMPOSITE SAMPLE.
- C.) CAST AND FIELD CURE (1) SET OF (6) STANDARD CYLINDER COMPRESSION TEST SPECIMENS FOR EACH COMPOSITE SAMPLE (ASTM C 31). TEST (2) AT 7 DAYS, (2) AT 28 DAYS, AND HOLD (2) FOR 56 DAYS AS REQUIRED.
- D.) CAST AND LABORATORY CURE (2) SET OF (6) STANDARD CYLINDER COMPRESSION TEST SPECIMENS FOR EACH COMPOSITE SAMPLE (ASTM C 31). TEST (2) AT 7 DAYS, (2) AT 28 DAYS AND HOLD (2) FOR 56 DAYS AS REQUIRED.

9.) ELEVATED SLABS: ADJUST CONCRETE QUANTITIES TO MAINTAIN A LEVEL SLAB SURFACE AT THE REQUIRED ELEVATIONS TO ACCOMMODATE SUPPORT DEFLECTIONS.

10.) ADHESIVE ANCHORS: LOCATE AWAY FROM REBAR. HILTI RE500; POWERS PE1000+; SIMPSON SET.

11.) SHOP DRAWINGS: SUBMIT PRIOR TO CONSTRUCTION FOR REINFORCING STEEL AND CONCRETE MIX DESIGNS.

BUILD AMERICA, BUY AMERICA ACT

- 1. BUILD AMERICA, BUY AMERICA ACT (BABAA) REQUIREMENTS INSTITUTED BY THE BIPARTISAN INFRASTRUCTURE LAW OF 2021 MANDATING DOMESTIC PREFERENCE THAT ALL IRON AND STEEL MANUFACTURED PRODUCTS, AND CONSTRUCTION MATERIALS ARE PRODUCED IN THE UNITED
- A. CONSTRUCTION MATERIALS THOSE ARTICLES, MATERIALS, OR SUPPLY OTHER THAN AN ITEM OF PRIMARILY IRON OR STEEL; A MANUFACTURED PRODUCT; CEMENT AND CEMENTITIOUS MATERIALS; AGGREGATES SUCH AS STONE, SAND, OR GRAVEL; OR AGGREGATE BINDING AGENTS OR ADDITIVES - THAT ARE OR CONSIST PRIMARILY OF: NON-FERROUS METALS, PLASTIC AND POLYMER-BASED PRODUCTS, GLASS, LUMBER OR DRYWALL
- B. MANUFACTURED PRODUCT ITEMS ASSEMBLED OUT OF COMPONENTS, OR OTHERWISE MADE OR PROCESSED FROM RAW MATERIALS INTO FINISHED PRODUCTS. MANUFACTURED PRODUCTS MUST BE MANUFACTURED (ASSEMBLED) IN THE UNITED STATES, AND THE COST OF COMPONENTS THAT WERE MINED, PRODUCED, OR MANUFACTURED IN THE UNITED STATES MUST BE GREATER THAN 55 PERCENT OF THE TOTAL COST OF ALL COMPONENTS OF
- C. MANUFACTURER'S CERTIFICATION DOCUMENTATION PROVIDED BY A MANUFACTURER, CERTIFYING THAT THE ITEMS PROVIDED BY MANUFACTURER MEET THE DOMESTIC PREFERENCE REQUIREMENTS OF BABAA.

STRUCTURAL SPECIAL INSPECTIONS

THE FOLLOWING TABLE COMPRISES THE STRUCTURAL SPECIAL INSPECTION REQUIREMENTS FOR THIS PROJECT IN ACCORDANCE WITH THE NEW YORK STATE UNIFORM CODE AND THE 2020 BCNYS, CHAPTER 17. REFER TO PROJECT SPECIFICATIONS FOR REQUIRED QUALIFICATIONS OF PERSONNEL PERFORMING SPECIAL INSPECTION ACTIVITIES AND FOR ADDITIONAL INFORMATION AND REQUIREMENTS.

SPECIAL INSPECTION NOTES

PRETENSIONING OPERATION

6. INSPECTION TASKS AFTER BOLTING:

TO CONCRETE PLACEMENT

RIGID POINT TOWARD THE FREE EDGES

A. PLACEMENT AND INSTALLATION OF STEEL DECK

C. FASTENER COMPONENT NOT TURNED BY THE WRENCH PREVENTED

D. FASTENERS ARE PRETENSIONED IN ACCORDANCE WITH THE RCSC

SPECIFICATION, PROGRESSING SYSTEMATICALLY FROM THE MOST

A. DOCUMENT ACCEPTANCE OR REJECTION OF BOLTED CONNECTIONS

INSPECTION OF STEEL ELEMENTS OF COMPOSITE CONSTRUCTION PRIOR

B. PLACEMENT AND INSTALLATION OF STEEL HEADED STUD ANCHORS

C. DOCUMENT ACCEPTANCE OR REJECTION OF STEEL ELEMENTS

- 1. SPECIAL INSPECTIONS ARE REQUIRED FOR THIS PROJECT.
- 2. COORDINATE WORK WITH OWNER'S TESTING AND SPECIAL INSPECTION REPRESENTATIVE.
- 3. PREFABRICATED ITEMS SHALL BE MANUFACTURED BY APPROVED AND CERTIFIED SHOPS. 4. REFERENCE BCNYS CHAPTER 17 FOR DEFINITION OF "CONTINUOUS" AND "PERIODIC".
- 5. REFERENCE AISC 360 CHAPTER N FOR DEFINITION OF "PERFORM" AND "OBSERVE".
- 6. REFERENCE ACI 530 FOR DEFINITION OF "CONTINUOUS" AND "PERIODIC". 7. REFERENCE SDI QA/QC FOR DEFINITION OF "PERFORM AND "OBSERVE".

| CAST-IN-PLACE CONCRETE | | | |
|---|------------|--|----------------------------------|
| INSPECT REINFORCEMENT AND VERIFY PLACEMENT | PERIODIC | ACI 318: CH. 20, 20.5 25.3, 26.6.1-26.6.3 | 1908.4 |
| 2. VERIFY REQUIRED CONCRETE MIX IS USED AT EACH LOCATION. | PERIODIC | ACI 318: CH. 19 26.4.3, 26.12 | 1904.1, 1904.2 1908.2, 1908.3 |
| 3. PRIOR TO CONCRETE PLACEMENT, FABRICATE SPECIMENS FOR STRENGTH TESTS, PERFORM SLUMP AND AIR CONTENT TESTS, AND DETERMINE THE TEMPERATURE OF THE CONCRETE. | CONTINUOUS | ASTM C172, C31 ACI 318: 26.4, 26.12 | 1908.10 |
| 4. INSPECT CONCRETE FOR PROPER APPLICATION TECHNIQUES. | CONTINUOUS | ACI 318:26.5 | 1908.6, 1908.7, |

| 2. VERIFY REQUIRED CONCRETE MIX IS USED AT EACH LOCATION. | PERIODIC | ACI 318: CH. 19 26.4.3, 26.12 | 1904.1, 1904.2 1908.2, 1908.3 |
|--|--|--|----------------------------------|
| 3. PRIOR TO CONCRETE PLACEMENT, FABRICATE SPECIMENS FOR STRENGTH TESTS, PERFORM SLUMP AND AIR CONTENT TESTS, AND DETERMINE THE TEMPERATURE OF THE CONCRETE. | CONTINUOUS | ASTM C172, C31 ACI 318: 26.4, 26.12 | 1908.10 |
| 4. INSPECT CONCRETE FOR PROPER APPLICATION TECHNIQUES. | CONTINUOUS | ACI 318:26.5 | 1908.6, 1908.7, 1908.8 |
| STEEL CONSTRUCTION (REFERENCE AISC 360 CHAPTER | RN) | | |
| 1. INSPECTION TASKS PRIOR TO WELDING: | | | |
| A. WELDING PROCEDURE SPECIFICATIONS (WPS) AVAILABLE. B. MANUFACTURER CERTIFICATIONS FOR WELDING CONSUMABLES AVAILABLE. | PERFORM PERFORM | | |
| C. MATERIAL IDENTIFICATION (TYPE/GRADE) D. WELDER IDENTIFICATION SYSTEM E. FIT-UP OF GROOVE WELDS (INCLUDING JOINT GEOMETRY) F. CONFIGURATION AND FINISH OF ACCESS HOLES G. FIT-UP OF FILLET WELDS | OBSERVE OBSERVE OBSERVE OBSERVE OBSERVE | | |
| 2. INSPECTION TASKS DURING WELDING: | | | |
| A. USE OF QUALIFIED WELDERS B. CONTROL AND HANDLING OF WELDING CONSUMABLES C. NO WELDING OVER CRACKED TACK WELDS D. ENVIRONMENTAL CONDITIONS E. WPS FOLLOWED F. WELDING TECHNIQUES | OBSERVE OBSERVE OBSERVE OBSERVE OBSERVE OBSERVE | | |
| 3. INSPECTION TASKS AFTER WELDING: A. WELDS CLEANED B. SIZE, LENGTH AND LOCATION OF WELDS C. WELDS MEET VISUAL ACCEPTANCE CRITERIA D. ARC STRIKES E. K-AREA F. BACKING REMOVED AND WELD TABS REMOVED (IF REQUIRED) G. REPAIR ACTIVITIES H. DOCUMENT ACCEPTANCE OR REJECTION OF WELDED JOINT / MEMBER 3.1 NONDESTRUCTIVE TESTING OF WELDED JOINTS: AISC 360 STRUCTURAL STEEL SPECIFICATION CHAPTER N, 5.5 | OBSERVE PERFORM PERFORM PERFORM PERFORM PERFORM PERFORM PERFORM AWS D1.1 | | |
| 4. INSPECTION TASKS PRIOR TO BOLTING: A. MANUFACTURER'S CERTIFICATIONS AVAILABLE FOR FASTENER | PERFORM | AISC 360 | 1705.2 |
| MATERIALS B. FASTENERS MARKED IN ACCORDANCE WITH ASTM REQUIREMENTS. C. PROPER FASTENERS SELECTED FOR THE JOINT DETAIL (GRADE, TYPE, BOLT LENGTH IF THREADS ARE TO BE EXCLUDED FROM SHEAR PLANE) | OBSERVE OBSERVE | CHAPTER N | |
| D. PROPER BOLTING PROCEDURE SELECTED FOR JOINT DETAIL E. CONNECTING ELEMENTS, INCLUDING THE APPROPRIATE FAYING SURFACE CONDITION AND HOLE PREPARATION, IF SPECIFIED, MEET | OBSERVE OBSERVE | | |
| APPLICABLE REQUIREMENTS. F. PRE-INSTALLATION VERIFICATION TESTING BY INSTALLATION PERSONNEL OBSERVED AND DOCUMENTED FOR FASTENER ASSEMBLIES AND METHODS USED | OBSERVE | | |
| G. PROPER STORAGE PROVIDED FOR BOLTS, NUTS, WASHERS AND OTHER FASTENER COMPONENTS | OBSERVE | | |
| 5. INSPECTION TASKS DURING BOLTING: | | | |
| A. FASTENER ASSEMBLIES, OF SUITABLE CONDITION, PLACED IN ALL HOLES AND WASHERS (IF REQUIRED) ARE POSITIONED AS REQUIRED. | OBSERVE | | |
| B. JOINT BROUGHT TO THE SNUG-TIGHT CONDITION PRIOR TO THE | OBSERVE | | |

OBSERVE

OBSERVE

PERFORM

PERFORM

PERFORM

PERFORM

| 1. ANCHOR SIZE AND EMBEDMENT AND HOLE CLEANING (ALL) 2. HOLE CLEANING AND PREPARATION (ADHESIVE) 3. OVERHEAD APPLICATIONS (ALL) 4. HORIZONTAL ANCHORS SUPPORTING SUSTAINED TENSION (ADHESIVE) 5. ADDITIONAL INSPECTION PER MANUFACTURER'S ESR REPORT | PERIODIC CONTINUOUS CONTINUOUS CONTINUOUS CONTINUOUS | MANUFACTURER'S INSTALLATION INSTRUCTIONS | ACI318 AND ESR REPOR |
|--|--|--|-------------------------|
| STEEL DECK INSTALLATION | | | |
| INSPECTION OR EXECUTION TASKS PRIOR TO DECK PLACEMENT A. VERIFY COMPLIANCE OF MATERIALS (DECK AND ALL DECK ACCESSORIES) WITH CONSTRUCTION DOCUMENTS, INCLUDING PROFILES, MATERIAL PROPERTIES, AND BASE METAL THICKNESS B. DOCUMENT ACCEPTANCE OR REJECTION OF DECK AND DECK ACCESSORIES INSPECTION OR EXECUTION TASKS AFTER DECK BLACEMENT. | PERFORM | | |
| 2. INSPECTION OR EXECUTION TASKS AFTER DECK PLACEMENT A. VERIFY COMPLIANCE OF DECK AND ALL DECK ACCESSORIES INSTALLATION WITH CONSTRUCTION DOCUMENTS | PERFORM | | |
| B. VERIFY DECK MATERIALS ARE REPRESENTED BY MILL CERTIFICATIONS THAT COMPLY WITH THE CONSTRUCTION DOCUMENTS | | | |
| C. DOCUMENT ACCEPTANCE OR REJECTION OF INSTALLATION OF DECK AND DECK ACCESSORIES B. INSPECTION OR EXECUTION TASKS PRIOR TO WELDING A. WELDING PROCEDURE SPECIFICATIONS (WPS) AVAILABLE B. MANUFACTURER CERTIFICATION FOR WELDING CONSUMABLES | OBSERVE OBSERVE | | |
| AVAILABLE C. MATERIAL IDENTIFICATION (TYPE/GRADE) D. CHECK WELDING EQUIPMENT INSPECTION OR EXECUTION TASKS DURING WELDING | OBSERVE OBSERVE | SDI QA/QC | |
| A. USE OF QUALIFIED WELDERS B. CONTROL AND HANDLING OF WELDING CONSUMABLES C. ENVIRONMENTAL CONDITIONS (WIND SPEED, MOISTURE, TEMP) D. WPS FOLLOWED | OBSERVE OBSERVE OBSERVE OBSERVE | QUALITY CONTROL AND QUALITY ASSURANCE FOR INSTALLATION OF STEEL DECK | 1705.2.2 |
| INSPECTION TASKS AFTER WELDING VERIFY SIZE AND LOCATION OF WELDS, INCLUDING SUPPORT, SIDELAP, AND PERIMETER WELDS | PERFORM | STEEL DECK | |
| B. WELDS MEET VISUAL ACCEPTANCE CRITERIA C. VERIFY REPAIR ACTIVITIES D. DOCUMENT ACCEPTANCE OR REJECTION OF WELDS | PERFORM PERFORM PERFORM | | |
| 6. INSPECTION OR EXECUTION TASKS PRIOR TO MECHANICAL FASTENING A. MANUFACTURER INSTALLATION INSTRUCTIONS AVAILABLE FOR MECHANICAL FASTENERS | OBSERVE | | |
| B. PROPER TOOLS AVAILABLE FOR FASTENER INSTALLATION C. PROPER STORAGE FOR MECHANICAL FASTENERS T. INCRESCION OR EXECUTION TACKS PUBLISHED MECHANICAL FASTENING | OBSERVE OBSERVE | | |
| 7. INSPECTION OR EXECUTION TASKS DURING MECHANICAL FASTENING A. FASTENERS ARE POSITIONED AS REQUIRED B. FASTENERS ARE INSTALLED IN ACCORDANCE WITH MANUFACTURER'S INSTRUCTIONS | OBSERVE OBSERVE | | |
| 8. INSPECTION OR EXECUTION TASKS AFTER MECHANICAL FASTENING A. CHECK SPACING, TYPE, AND INSTALLATION OF SUPPORT FASTENERS B. CHECK SPACING, TYPE, AND INSTALLATION OF SIDELAP FASTENERS C. CHECK SPACING, TYPE, AND INSTALLATION OF PERIMETER FASTENERS | PERFORM PERFORM PERFORM | | |
| D. VERIFY REPAIR ACTIVITIES E. DOCUMENT ACCEPTANCE OR REJECTION OF MECHANICAL FASTENERS | PERFORM PERFORM | | |





STRUCTURAL ENGINEER:



1653 East Main Street Rochester, NY 14609

MEP/FP ENGINEER:



315 Rockingham Street Rochester, NY 14620

WARNING: DRAWINGS, SPECIFICATIONS AND OTHER

DOCUMENTS, INCLUDING THOSE IN ELECTRONIC FORM, PREPARED BY BERO ARCHITECTURE PLLC ARE INSTRUMENTS OF SERVICE FOR USE SOLELY WITH RESPECT TO THE PROJECT FOR WHICH THEY WERE EATED. THE ARCHITECT RETAINS ALL COMMON STATUTORY AND OTHER RESERVED RIGHTS, INCLUDING

FOR ARCHITECTURAL DRAWINGS AND ELECTRONIC MEDIA, IT IS A VIOLATION OF TITLE VII, PART 69.5(B) O THE NEW YORK STATE EDUCATION LAW FOR ANY PERSON, UNLESS ACTING UNDER THE DIRECTION OF A LICENSED ARCHITECT TO ALTER THIS DRAWING. IF ALTERED, SUCH ARCHITECT SHALL AFFIX THEIR SEAL, SIGNATURE, THE DATE, THE NOTATION "ALTERED BY"

AND THE SPECIFIC DESCRIPTION OF THE ALTERATION

WHERE DRAWINGS, ON PAPER OR ELECTRONIC MEDIA, SHOW EXISTING, NEW, AND/OR PROPOSED WORK AND CONDITIONS, IT IS UNDERSTOOD THAT IT IS SO SHOWN AS A MATTER OF INFORMATION AND THAT THE OWNER AND ARCHITECT, WHILE BELIEVING SUCH INFORMATION TO BE SUBSTANTIALLY CORRECT, ASSUME NO RESPONSIBILITY THEREFORE. THE USER SHALL MAKE THEMSELVES FAMILIAR WITH ALL CONDITIONS AFFECTING THE NATURE AND MANNE OF THEIR WORK INCLUDING VERIFICATION OF ALL DIMENSIONS LOCATING EXISTING, PROPOSED. AND/OR NEW WORK AND CONDITIONS.

REVISIONS:

| # | Date | Description | |
|-----|---------|-------------|---|
| | | | _ |
| | | | |
| | | | |
| _ | | | _ |
| | | | |
| | | | |
| | | | |
| CLI | ENT / O | WNER: | |



PROJECT INFORMATION:

Construction Documents Warsaw Public Library 130 North Main Street, Warsaw, New Yor

22121

ISSUE DATE: 04/25/2025 DRAWN BY:


GENERAL

PROJECT NUMBER:

SHEET TITLE:

SHEET NUMBER:

NOTES

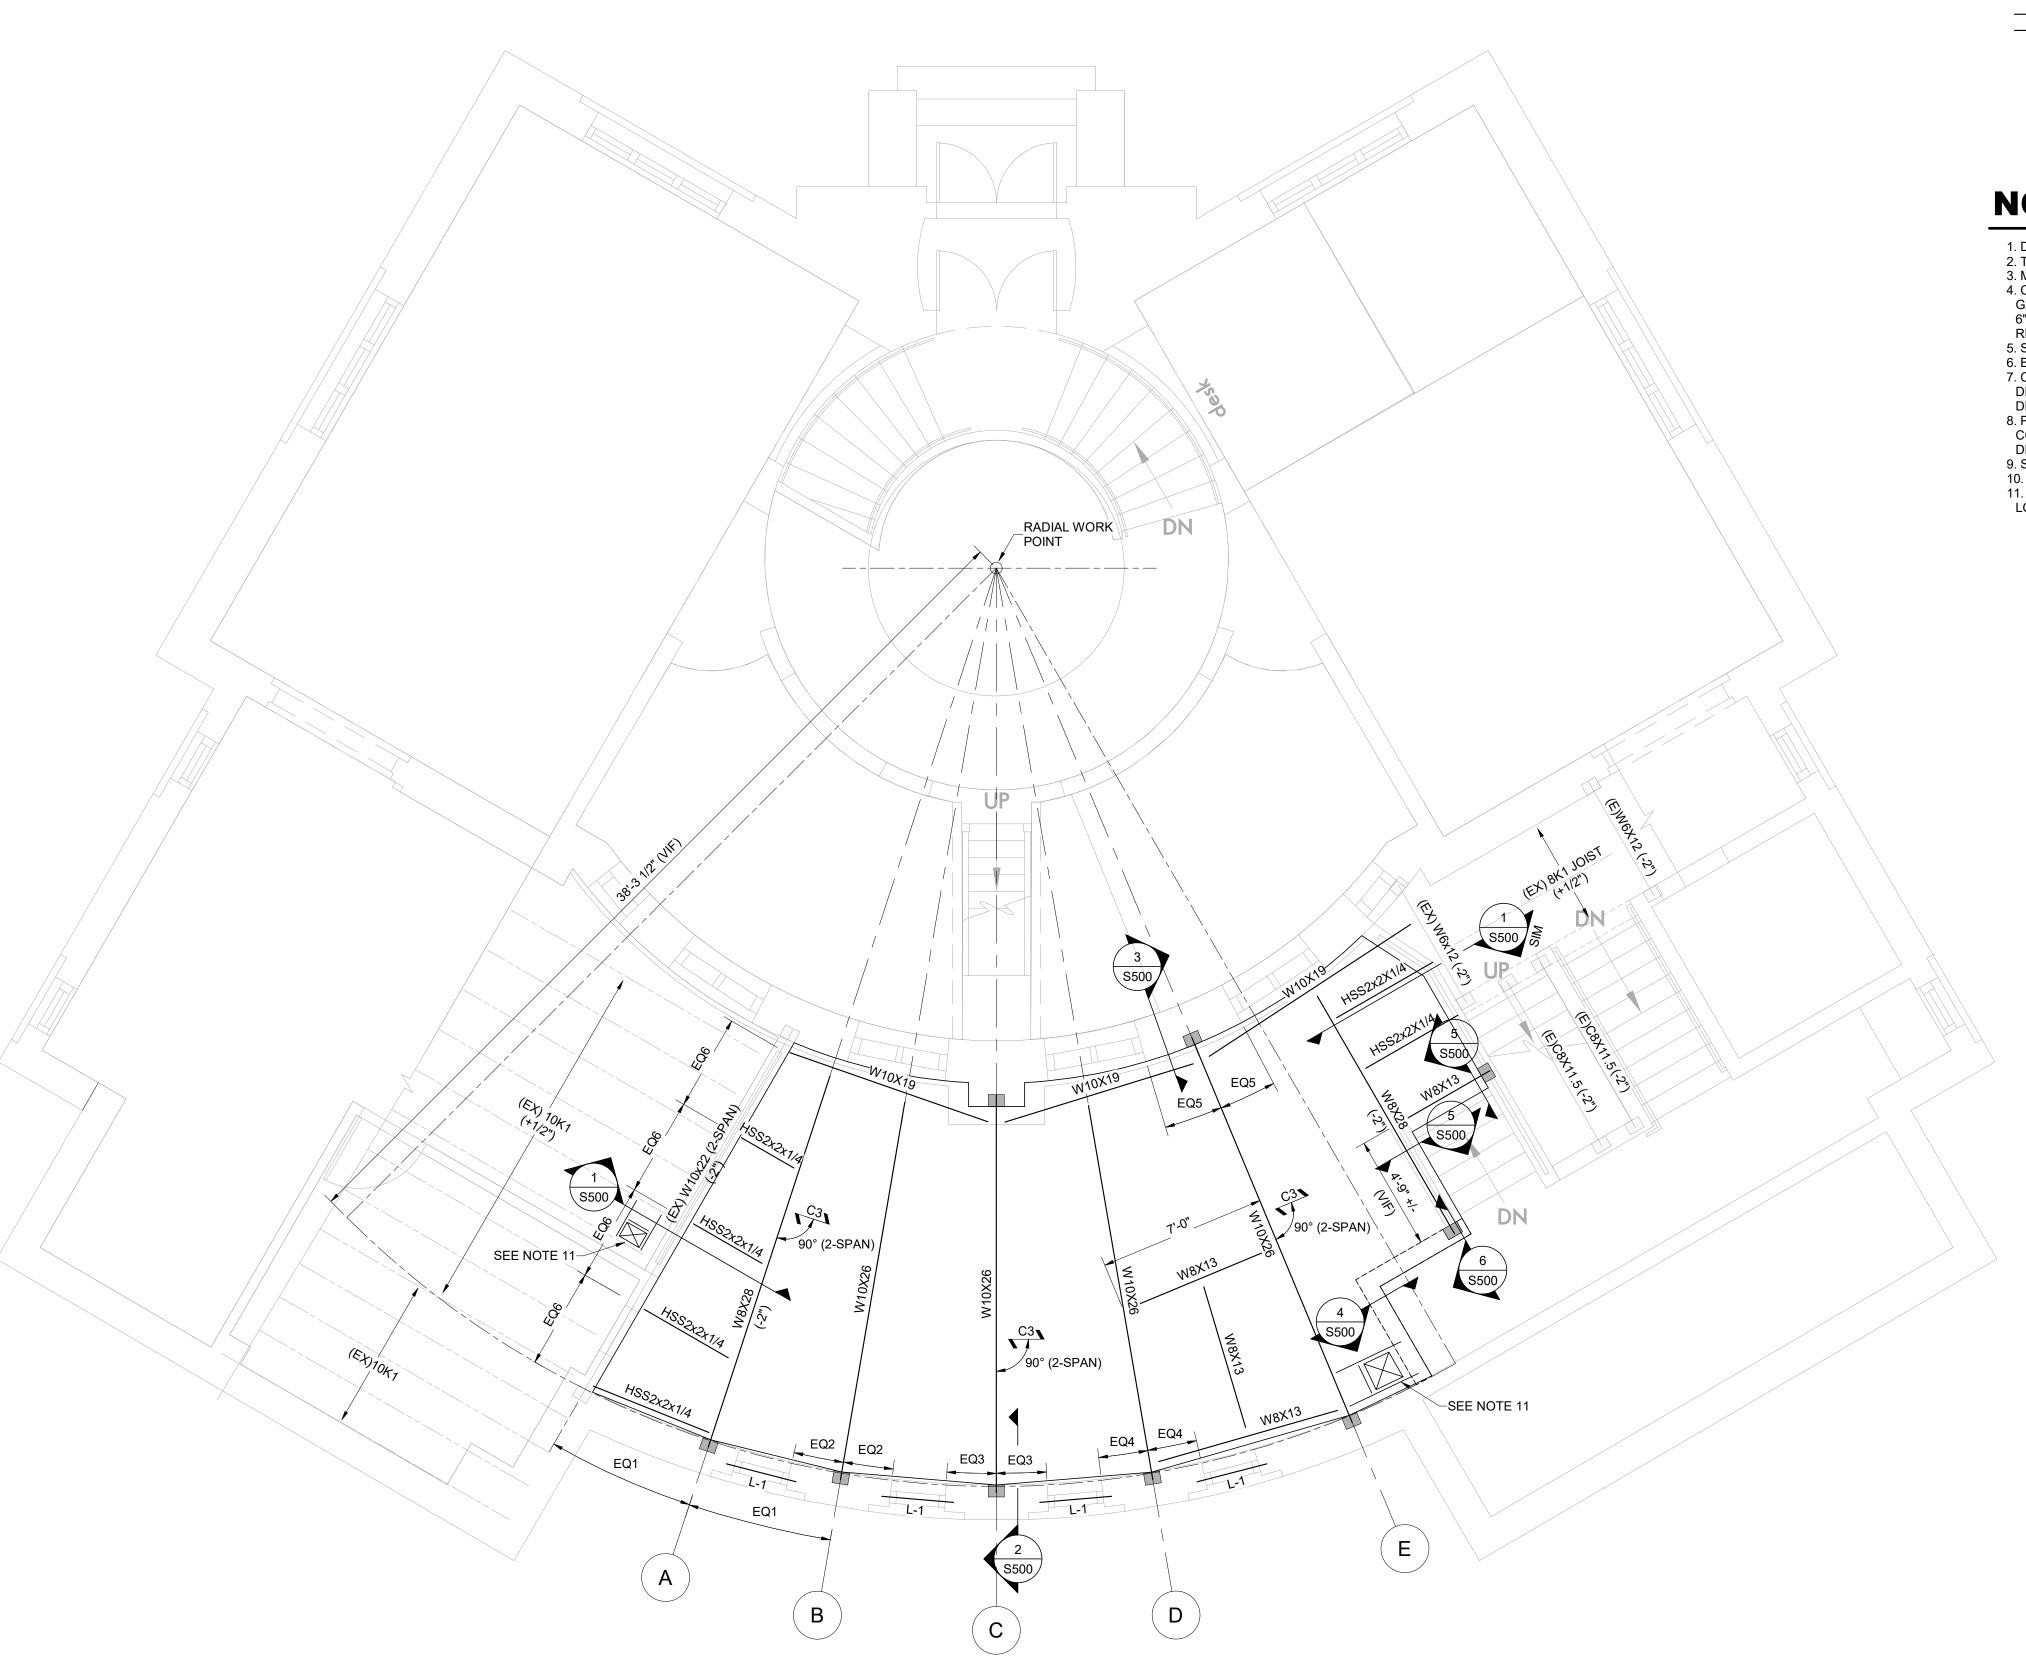

LEGEND

(+/- x'-xx") - DENOTES TOP OF STEEL ELEVATION WITH RESPECT TO DATUM ELEVATION

- DENOTES FRAMED OPENING. COORDINATE SIZE AND LOCATION WITH ARCHITECTURAL AND MECHANICAL DRAWINGS

NOTES

- 1. DATUM ELEVATION = LOWER LEVEL FFE = 0'-0"
- 2. TOP OF STEEL = +10'-0 1/2" (VIF)
 3. MAIN LEVEL TOP OF SLAB = +10'-4" (VIF)
- 4. C3 = 3 1/2" TOTAL THICKNESS NORMAL WEIGHT CONCRETE SLAB ON 1 1/2", 20 GA,COMPOSITE METAL DECK VULCRAFT 1.5VL BASIS OF DESIGN. REINFORCE WITH 6"X6"-W1.4xW1.4 WWF OR 4 LBS/CY FORTA-FERRO (FORTA) MACRO-FIBER
- REINFORCING.
 5. SECTIONS INDICATED ARE TYPICAL FOR SIMILAR CONDITIONS. 6. BEAMS ARE EQUALLY SPACED UNLESS NOTED OTHERWISE.
- 7. COORDINATE FLOOR OPENINGS WITH MECHANICAL AND ARCHITECTURAL
- DRAWINGS. OPENINGS NOT INDICATED ON PLANS SHALL CONFORM TO TYPICAL DETAIL REQUIREMENTS.
- 8. PROVIDE A MINIMUM 1/4" ANGLE OR BENT PLATE AT SLAB PERIMETERS UNO. COORDINATE ANGLE OR PLATE OVERHANG DIMENSIONS WITH ARCHITECTURAL
- 9. SPLICE BEAMS AS REQUIRED FOR INSTALL. SEE S500 FOR TYPICAL DETAIL
- 10. L-1: DENOTES NEW (2) L3 1/2X3 1/2X5/16 GALV. EXTERIOR WALL LINTEL (SEE ARCH)
- 11. PROVIDE FLOOR SLAB PENETRATION FRAME PER SECTION 4/S500 (TYP AT 2 LOCATIONS PROVIDE CFMF POUR STOP AT NEW SLAB LOCATION)

32 Winthrop Street, Rochester, NY 14607 (585) 262-2035 | www.beroarchitecture.com



STRUCTURAL ENGINEER:



1653 East Main Street Rochester, NY 14609

MEP/FP ENGINEER:



315 Rockingham Street Rochester, NY 14620

WARNING:

DRAWINGS, SPECIFICATIONS AND OTHER DOCUMENTS, INCLUDING THOSE IN ELECTRONIC FORM, PREPARED BY BERO ARCHITECTURE PLLC ARE INSTRUMENTS OF SERVICE FOR USE SOLELY WITH RESPECT TO THE PROJECT FOR WHICH THEY WERE CREATED. THE ARCHITECT RETAINS ALL COMMON LAW, STATUTORY AND OTHER RESERVED RIGHTS, INCLUDING COPYRIGHT.

FOR ARCHITECTURAL DRAWINGS AND ELECTRONIC MEDIA, IT IS A VIOLATION OF TITLE VII, PART 69.5(B) OF THE NEW YORK STATE EDUCATION LAW FOR ANY PERSON, UNLESS ACTING UNDER THE DIRECTION OF A LICENSED ARCHITECT TO ALTER THIS DRAWING. IF ALTERED, SUCH ARCHITECT SHALL AFFIX THEIR SEAL, SIGNATURE, THE DATE, THE NOTATION "ALTERED BY", AND THE SPECIFIC DESCRIPTION OF THE ALTERATION.

WHERE DRAWINGS, ON PAPER OR ELECTRONIC MEDIA, SHOW EXISTING, NEW, AND/OR PROPOSED WORK AND CONDITIONS, IT IS UNDERSTOOD THAT IT IS SO SHOWN AS A MATTER OF INFORMATION AND THAT THE OWNER AND ARCHITECT, WHILE BELIEVING SUCH INFORMATION TO BE SUBSTANTIALLY CORRECT, ASSUME NO RESPONSIBILITY THEREFORE. THE USER SHALL MAKE THEMSELVES FAMILIAR WITH ALL CONDITIONS AFFECTING THE NATURE AND MANNER
OF THEIR WORK INCLUDING VERIFICATION OF ALL
DIMENSIONS LOCATING EXISTING, PROPOSED,
AND/OR NEW WORK AND CONDITIONS.

REVISIONS: # Date

CLIENT / OWNER:



83 Center Street Warsaw, NY 14569

PROJECT INFORMATION:

Construction Documents Warsaw Public Library 130 North Main Street, Warsaw, New York

PROJECT NUMBER: 04/25/2025 ISSUE DATE:

DRAWN BY: SHEET TITLE:


> **FRAMING PLAN**


SHEET NUMBER:


S101

1 PARTIAL FLOOR FRAMING PLAN

1/4" = 1'-0"

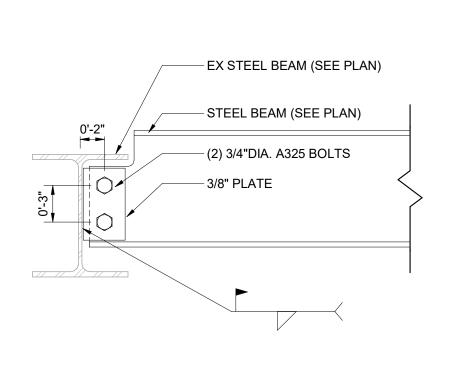

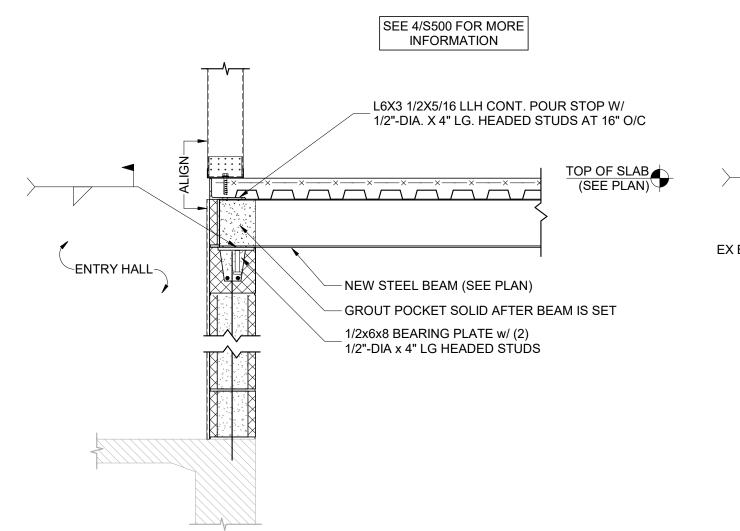


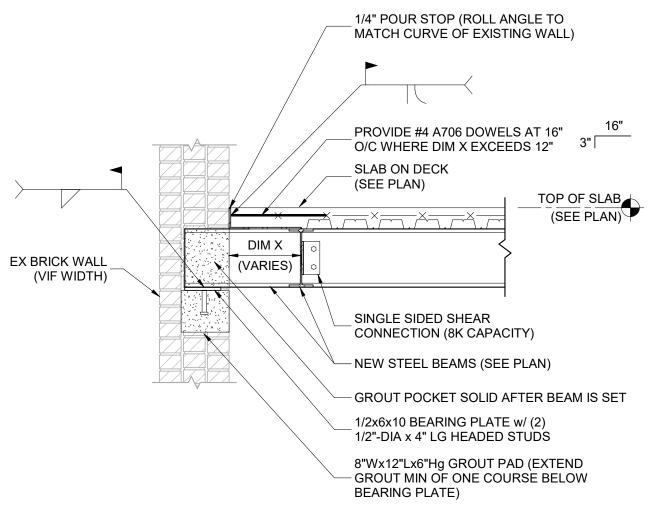


9 NEW BEAM TO EX W10
1 1/2" = 1'-0"

6 MASONRY BEAM POCKET IN NEW CMU 3/4" = 1'-0"

3 MASONRY BEAM POCKET IN EX BRICK 3/4" = 1'-0"

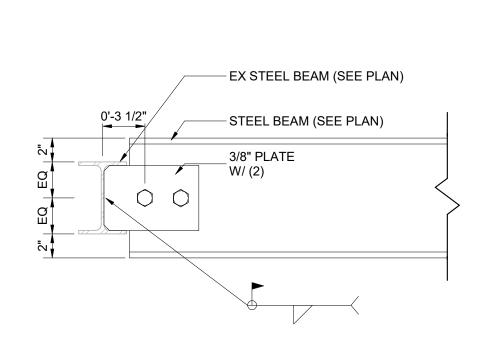

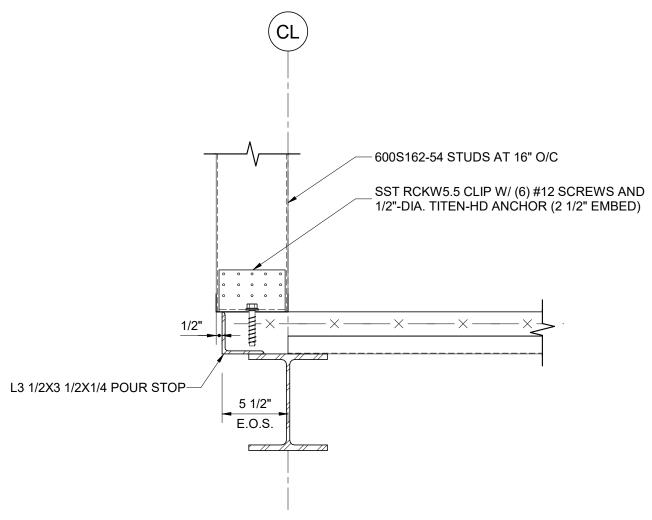

- 600S162-54 STUDS AT 16" O/C

NEW 3 1/2" SLAB-ON-DECK

SST RCKW5.5 CLIP W/ (6) #12 SCREWS AND

1/2"-DIA. TITEN-HD ANCHOR (2 1/2" EMBED)

L6X3 1/2X5/16 LLH CONT. POUR STOP W/ 1/2"-DIA. X 4" LG. HEADED STUDS AT 16" O/C

HSS1 1/2X1 1/2 DECK REINFORCEMENT

— AT EACH SIDE OF DUCT PENETRATION

DRILL AND EPOXY VERTS (EMBED 3 1/2")

(DECK NOT SHOWN FOR CLARITY)


8" CMU BOND BEAM w/ #5 BAR

8" CMU WALL w/ #5 BARS @ -- CORNERS, SIDES OF OPENINGS

(PROVIDE CORNER BARS)

AND 32" OC MAX

EXISTING FOUNDATION

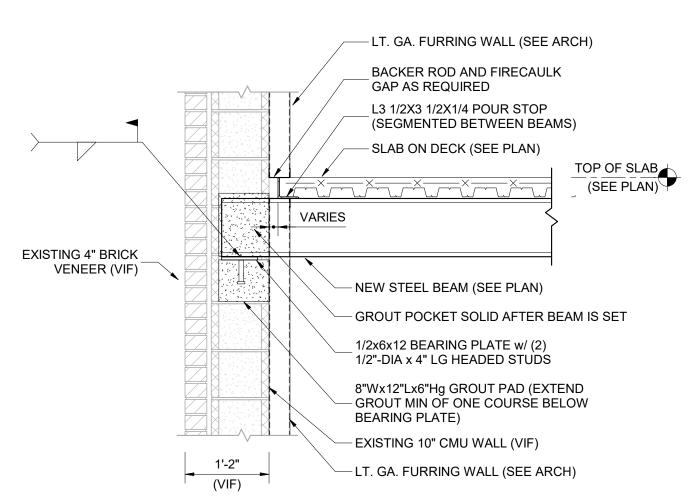

8 NEW BEAM TO EX W6
1 1/2" = 1'-0"

5 FLOOR OPENING1 1/2" = 1'-0"

CFMF


—POUR STOP

SECTION A-A

1/2" HAT CHANNELS

AT 16" O/C

(8) 3/4" A325 BOLTS IN STD HÓLES, SNUG TIGHT

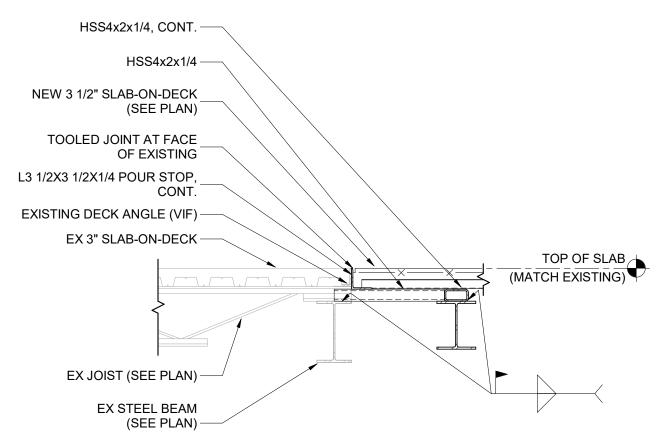

10 NEW SLAB ON GRADE - ALTERNATE NO. 1

- REINFORCING: 6X6-W2.9xW2.9 WWF

SAWCUT GROOVE: 1/8" X 1 1/4"

VAPOR BARRIER: SEE SPECS

SUBBASE: #2 WASHED STONE

SUBGRADE: STRUCTURAL OR

- UNDISTURBED NATIVE MATERIAL,

2" RIGID INSULATION: SEE SPECS

AT 10'-0" O/C

COMPACTED

7 BEAM SPLICE DETAIL
1 1/2" = 1'-0"

── W10x26

5/8" PLATE,

4 EDGE OF SLAB DETAIL

3/4" = 1'-0"

1 SLAB-ON-DECK @ EXISTING

3/4" = 1'-0"

Warsaw Public Library 30 North Main Street, Warsaw, New Yor PROJECT NUMBER: ISSUE DATE:

PROJECT INFORMATION:

DRAWN BY:

STRUCTURAL DETAILS

04/25/2025

Town of Warsaw

83 Center Street

Warsaw, NY 14569

Construction Documents

ARCHITECTURE

32 Winthrop Street, Rochester, NY 14607

(585) 262-2035 | www.beroarchitecture.com

STAMP:

STRUCTURAL ENGINEER:

1653 East Main Street Rochester, NY 14609

MEP/FP ENGINEER:

CW Engineering

315 Rockingham Street

Rochester, NY 14620

WARNING:

INSTRUMENTS OF SERVICE FOR USE SOLELY WITH RESPECT TO THE PROJECT FOR WHICH THEY WERE REATED. THE ARCHITECT RETAINS ALL COMMON L

STATUTORY AND OTHER RESERVED RIGHTS, INCLUDING

MEDIA, IT IS A VIOLATION OF TITLE VII, PART 69.5(B) OF THE NEW YORK STATE EDUCATION LAW FOR ANY PERSON, UNLESS ACTING UNDER THE DIRECTION OF A LICENSED ARCHITECT TO ALTER THIS DRAWING. IF

ALTERED, SUCH ARCHITECT SHALL AFFIX THEIR SEAL, SIGNATURE, THE DATE, THE NOTATION "ALTERED BY"

AND THE SPECIFIC DESCRIPTION OF THE ALTERATION.

MEDIA, SHOW EXISTING, NEW, AND/OR PROPOSED WORK AND CONDITIONS, IT IS UNDERSTOOD THAT IT IS SO SHOWN AS A MATTER OF INFORMATION AND THAT THE OWNER AND ARCHITECT, WHILE BELIEVING SUCH INFORMATION TO BE SUBSTANTIALLY CORRECT, ASSUME NO RESPONSIBILITY THEREFORE. THE USER SHALL MAKE THEMSELVES FAMILIAR WITH ALL CONDITIONS AFFECTING THE NATURE AND MANNER OF THEIR WORK INCLUDING VERIFICATION OF ALL

AND/OR NEW WORK AND CONDITIONS.

REVISIONS:


Date


CLIENT / OWNER:

DRAWINGS, SPECIFICATIONS AND OTHER DOCUMENTS, INCLUDING THOSE IN ELECTRONIC FORM, PREPARED BY BERO ARCHITECTURE PLLC ARE

SHEET NUMBER:


S500

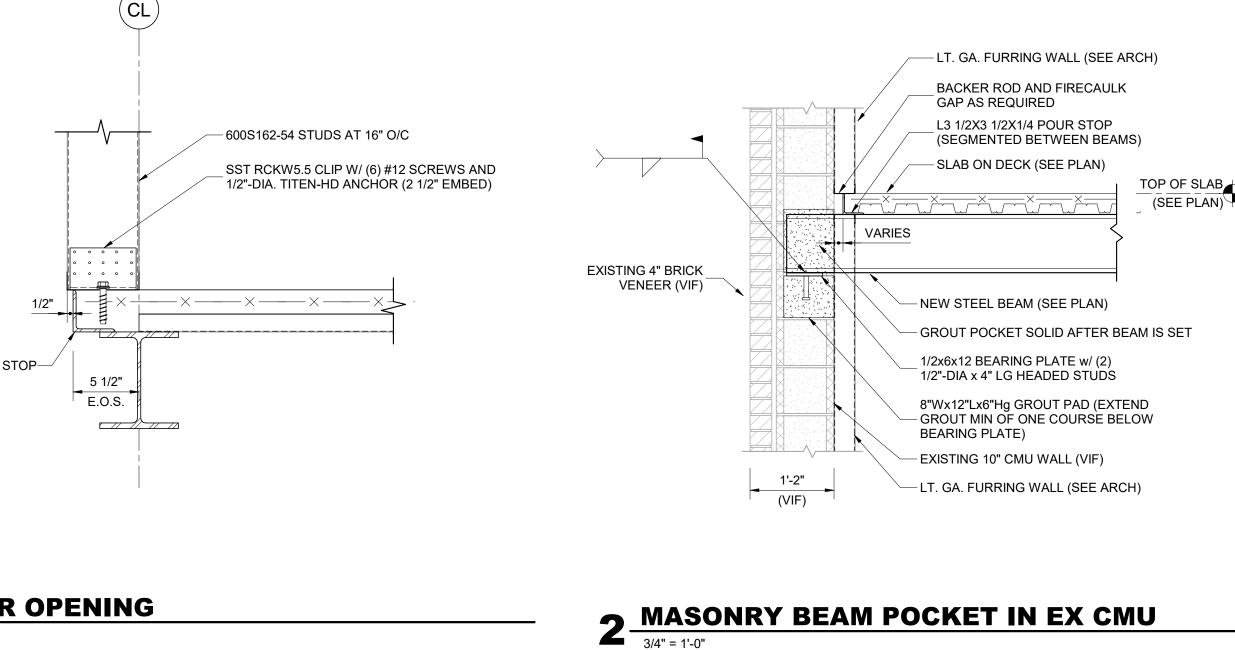

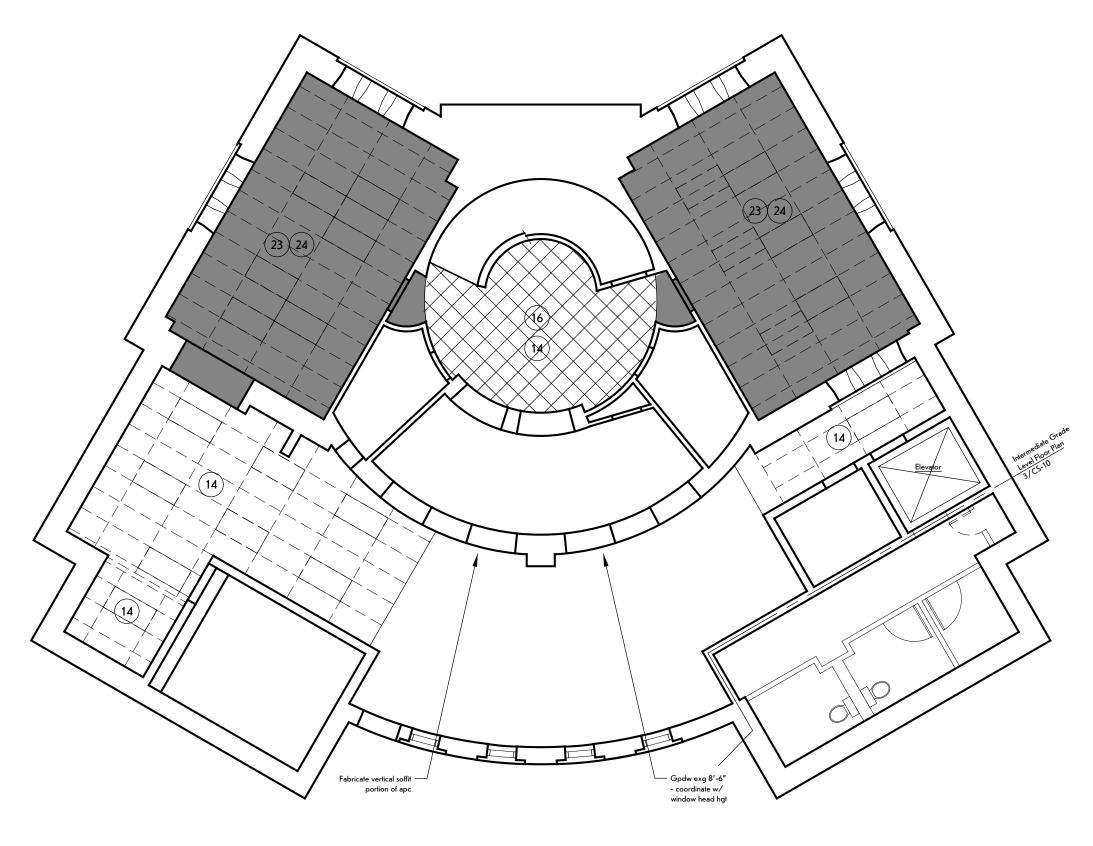



Lower Level Demolition Reflected Ceiling Plan SCALE: 1/8" = 1'-0"

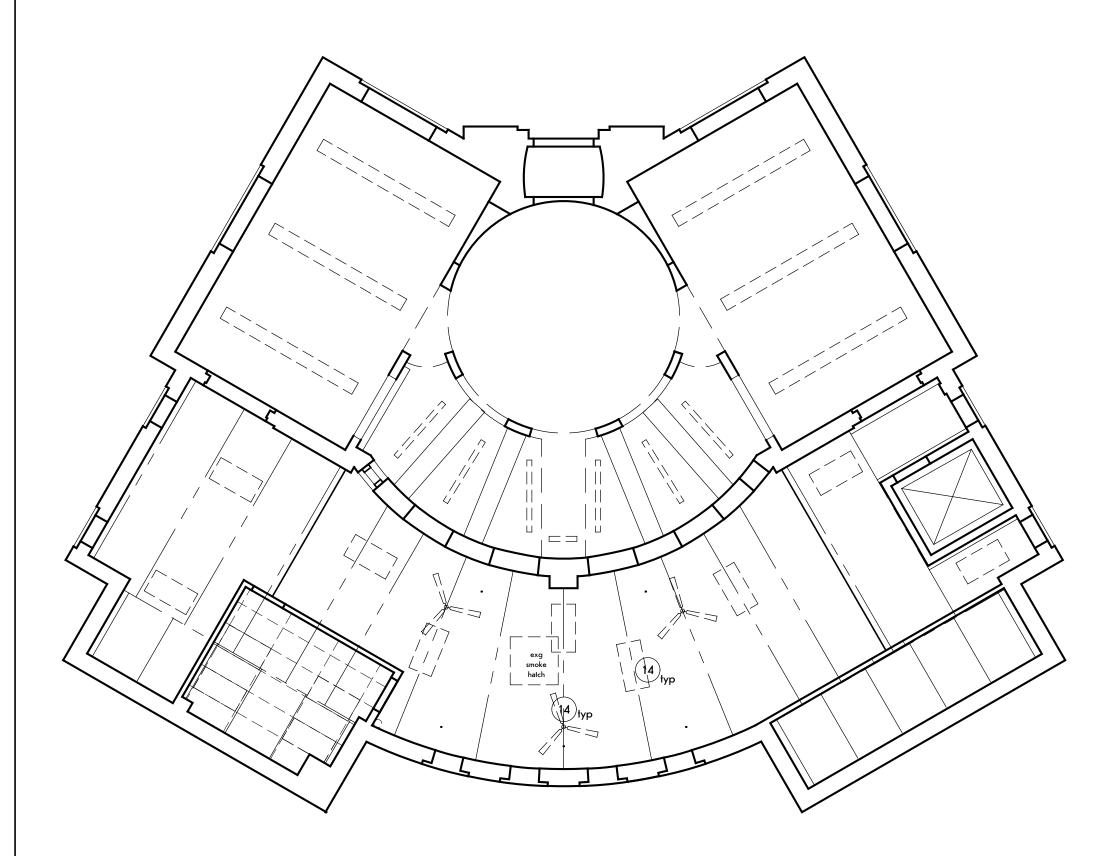

Main Level Demolition Reflected Ceiling Plan

DEMOLITION LEGEND:

---- To be removed



Remove ceiling/floor construction (Alternate No. 1 & Alternate No. 6)

GENERAL DEMOLITION NOTES:

- 1. Protect portions of building not scheduled for removal.
- 2. Remove carpet and rubber base, full extent of building.
- 3. Remove metal pipe rail at all, interior existing openings.
- 4. Elevator to be protected during construction.
- 5. Refer to MEP drawings for associated removals.

DEMOLITION NOTES:

- Remove frame wall construction and window. Plumbing and Electrical Contract responsible for relocating power and plumbing in new walls.
- Remove wall construction to finish floor level.
- Salvage door and hardware for reinstallation. Store during construction.
- Remove bifold door.
- Remove cabinetry, sink, and remaining equipment. Coordinate removals w/abatement for Study Room 010.
- Remove rubber stair treads and mastic to expose steal tread.
- Asbestos containing flooring to be encapsulated.
- Remove circulation desk casework.
- Remove guardrail paneling full extent of low guardrail to expose original guardrail, contact Architect for inspection of existing conditions. Original rail is expected behind paneling.
- 10 Prep walls for paint, full extent of Rotunda and entry stair and Study Room
- Protect exg entrance mat system with pwd during construction. Protect exg flring and walls in Entry Hall 020.
- Remove portion of exg window sash at floor level to provide new opening. Refer to 1/A-41 for extent of removals.
- Remove desk and casework below stair.
- Removal of fans and lighting responsibility of Electrical Contract. Coordinate
- Provide openings for wood windows at existing masonry wall.
- Remove acoustic tile ceiling.
- Remove fire rated door and frame.
- Remove vertical wood wall trim.
- Remove wallpaper, prep walls for paint finish. GC to provide openings as req'd to install ducts (Alternate No. 4), coord w/ Mechanical Contractor.

DEMOLITION NOTES - ALTERNATE NO. 1 & ALTERNATE NO. 6:

ALTERNATE NO. 6

- Remove wood floor and sleepers for inspection of existing concrete floor.
- (21) Remove conc floor, Allowance No. 6, and excavate as req'd for new slab.


ALTERNATE NO. 1


- (22) Remove wall paneling.
- Remove acoustical tile ceiling and grid. Coordinate w/ Electrical and Mechanical Work.
- Remove wood ceiling lathe and any remaining plaster.

ALTERNATES:

- 1. Alternate No. 1: Renovation of Children's Collection 006 and Young Adult 012.
- 2. Alternate No. 2: Acoustical, hung panel ceiling above
- Circulation Desk. Alternate No. 3: Upper Rotunda carpet flooring medallion.
- Alternate No. 4: Extend cooling system.
- Alternate No. 5: Attic access.

 Alternate No. 6: Provide concrete slab in Children's
- Collection 006 and Young Adult 012.

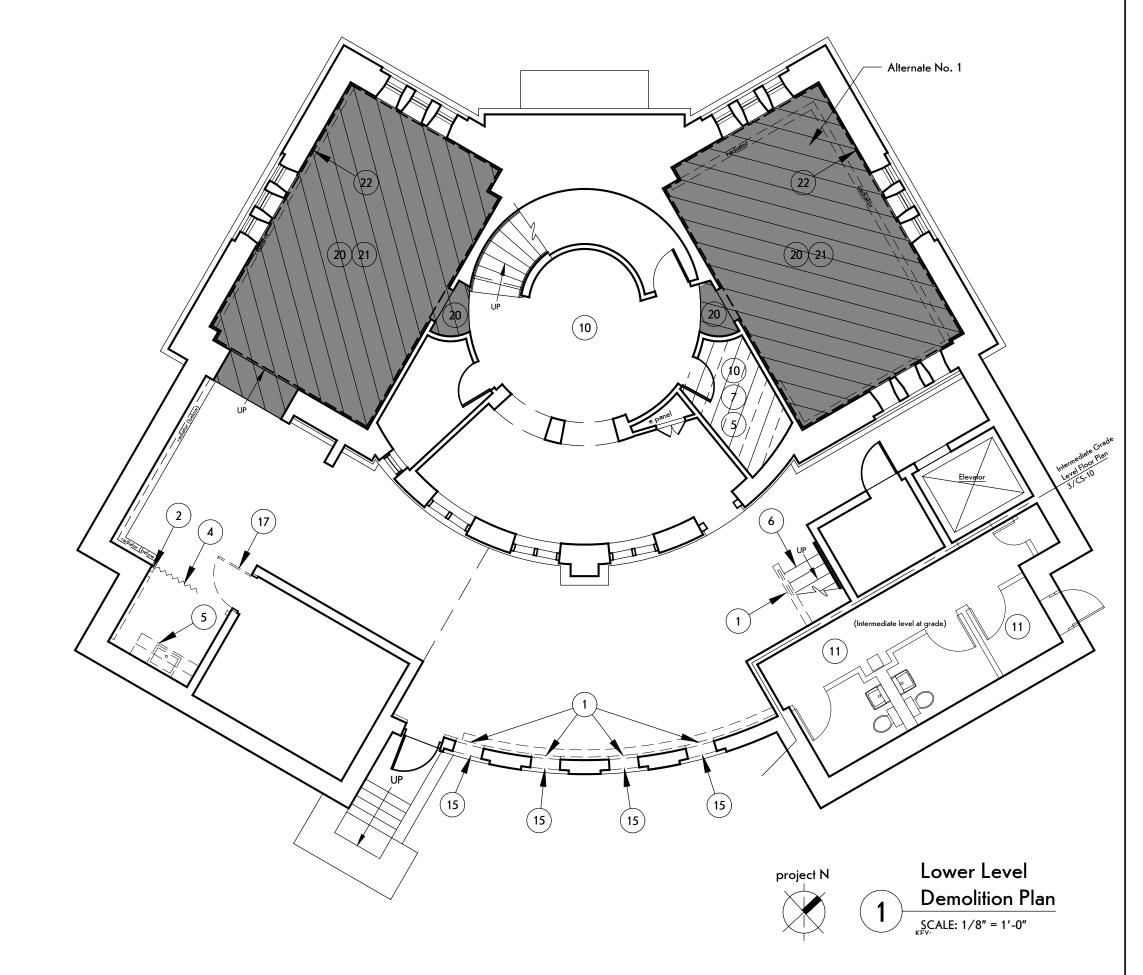

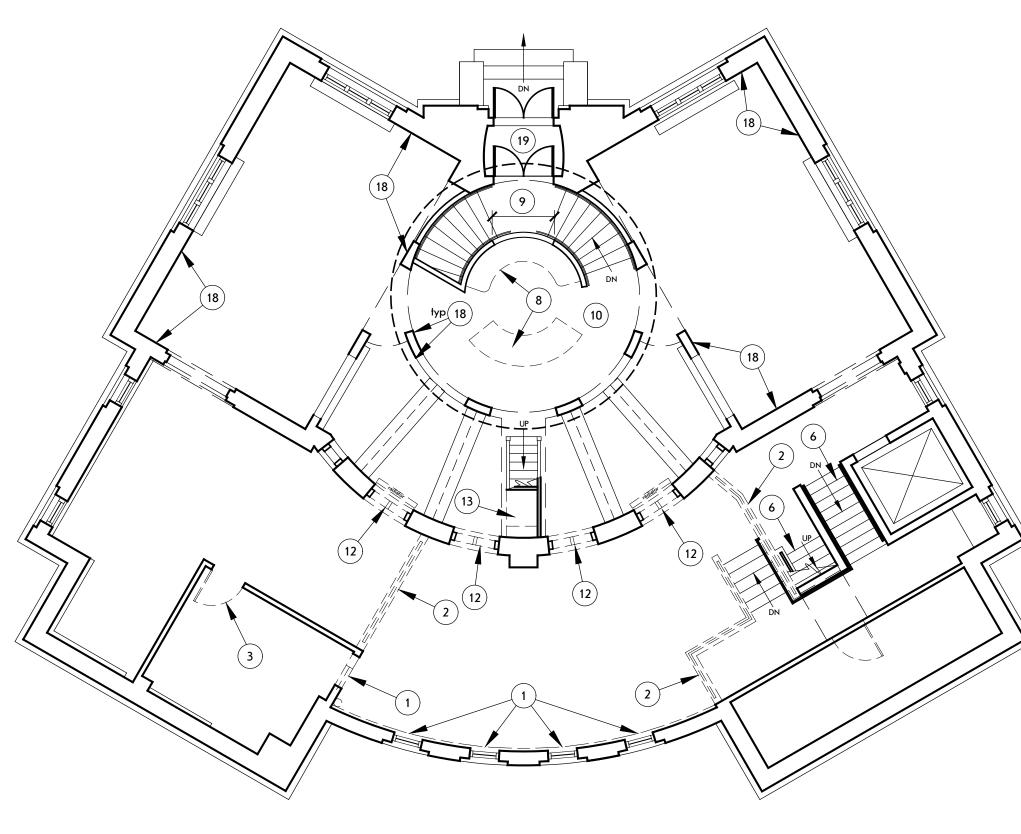



Main Level Demolition Plan





STRUCTURAL ENGINEER:



1653 East Main Street Rochester, NY 14609

MEP/FP ENGINEER:



315 Rockingham Street Rochester, NY 14620

DRAWINGS, SPECIFICATIONS AND OTHER DRAWINGS, SPECIFICATIONS AND OTHER DOCUMENTS, INCLUDING THOSE IN ELECTRONIC FORM, PREPARED BY BERO ARCHITECTURE PILLC ARE INSTRUMENTS OF SERVICE FOR USE SOLELY WITH RESPECT TO THE PROJECT FOR WHICH THEY WERE CREATED. THE ARCHITECT RETAINS ALL COMMON LAW, STATUTORY AND OTHER RESERVED RIGHTS, INCLUDING COPYRIGHT.

FOR ARCHITECTURAL DRAWINGS AND ELECTRONIC MEDIA, IT IS A VIOLATION OF TITLE VII, PART 69.5(B) OF THE NEW YORK STATE EDUCATION LAW FOR ANY PERSON, UNLESS ACTING UNDER THE DIRECTION OF A LICENSED ARCHITECT TO ALTER THIS DRAWING. IF

ALTERED, SUCH ARCHITECT SHALL AFFIX THEIR SEAL, SIGNATURE, THE DATE, THE NOTATION "ALTERED BY", AND THE SPECIFIC DESCRIPTION OF THE ALTERATION. WHERE DRAWINGS, ON PAPER OR ELECTRONIC MEDIA, SHOW EXISTING, NEW, AND/OR PROPOSED WORK AND CONDITIONS, IT IS UNDERSTOOD THAT IT IS SO SHOWN AS A MATTER OF INFORMATION AND THAT THE OWNER AND ARCHITECT, WHILE BELIEVING SUCH INFORMATION TO BE SUBSTANTIALLY CORRECT, ASSUME NO RESPONSIBILITY THEREFORE. THE USER SHALL MAKE THEMSELYES FAMILIAR WITH ALL CONDITIONS AFFECTING THE NATURE AND MANNER
OF THEIR WORK INCLUDING VERIFICATION OF ALL DIMENSIONS LOCATING EXISTING, PROPOSED, AND/OR NEW WORK AND CONDITIONS.

| REV | ISIONS: | |
|-----|---------|-------------|
| # | Date | Description |
| | | |
| | | |
| | | |
| | | |

CLIENT / OWNER:



Town of Warsaw 83 Center Street Warsaw, NY 14569

PROJECT INFORMATION:

Expansion and Renovation Warsaw Public Library

130 North Main Street, Warsaw, New Yor PROJECT NUMBER: April 25, 2025

ISSUE DATE: DRAWN BY:


SHEET TITLE: Main & Lower Level

LMY / TTN

SHEET NUMBER:

D-10

Demolition Plan

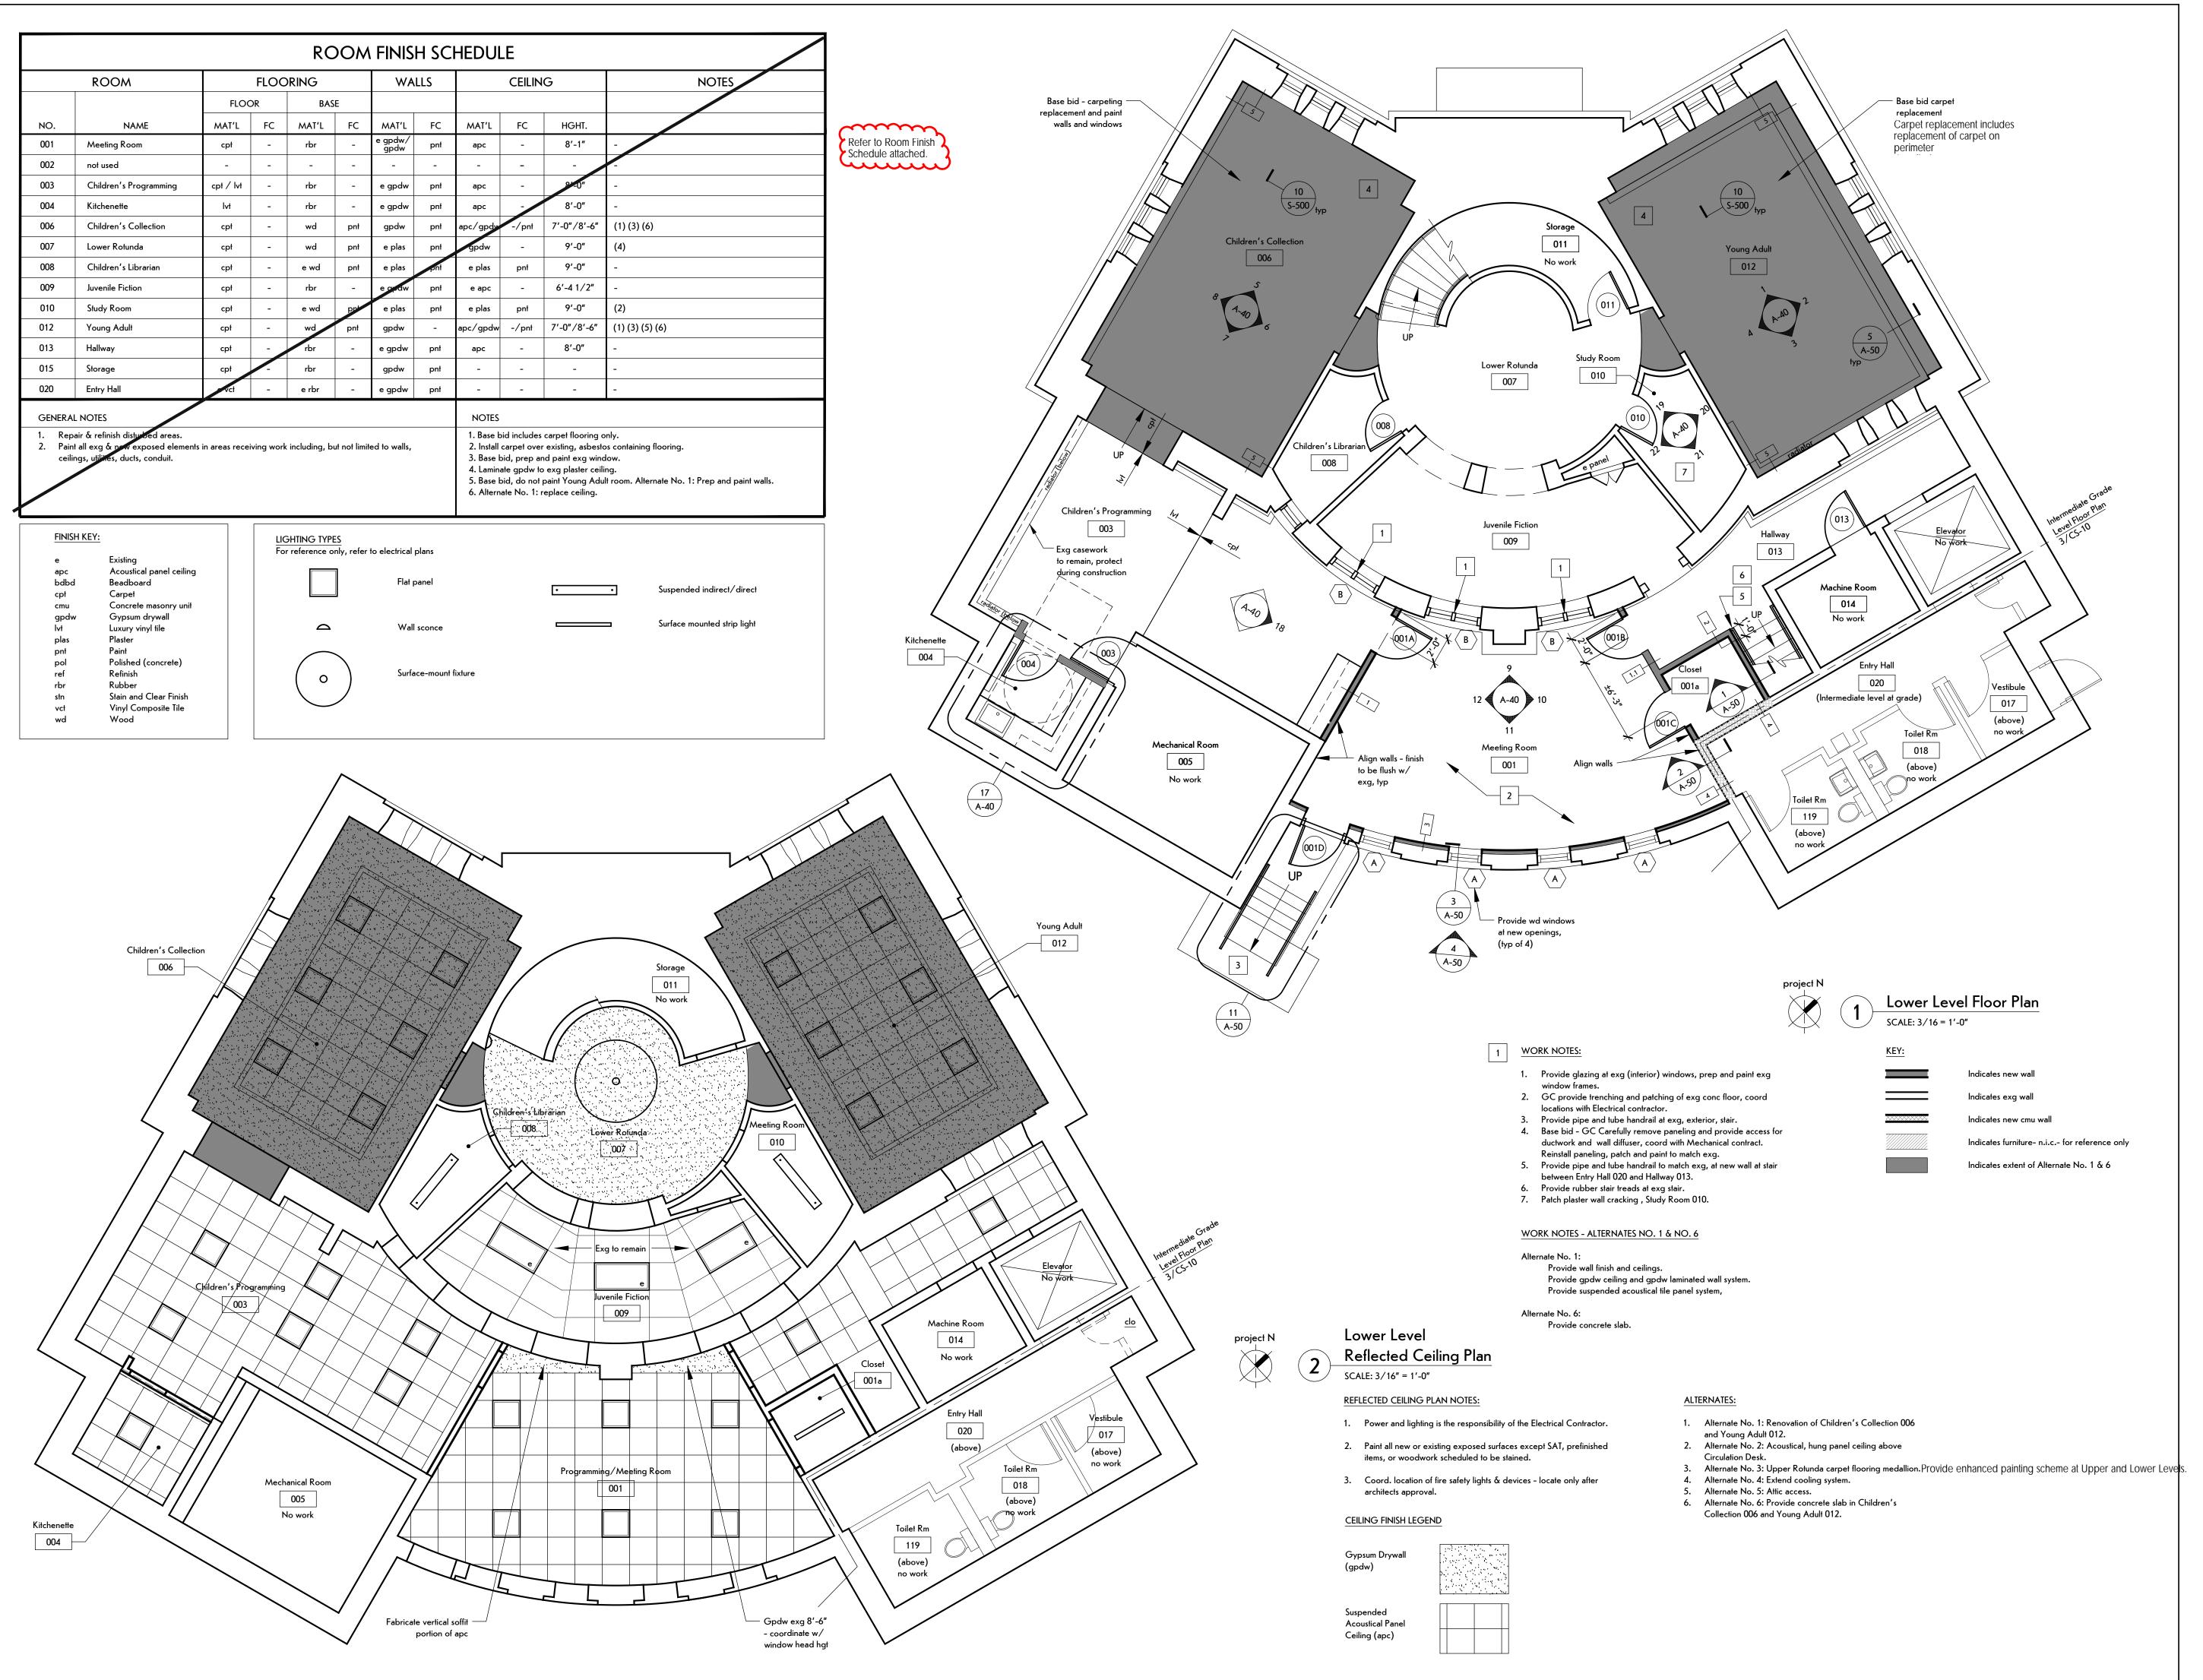

32 Winthrop Street, Rochester, NY 14607 (585) 262-2035 | www.beroarchitecture.com



STRUCTURAL ENGINEER:



1653 East Main Street Rochester, NY 14609

MEP/FP ENGINEER:



315 Rockingham Street Rochester, NY 14620

DRAWINGS, SPECIFICATIONS AND OTHER FORM, PREPARED BY BERO ARCHITECTURE PLLC ARE INSTRUMENTS OF SERVICE FOR USE SOLELY WITH RESPECT TO THE PROJECT FOR WHICH THEY WERE CREATED. THE ARCHITECT RETAINS ALL COMMON LAW, STATUTORY AND OTHER RESERVED RIGHTS, INCLUDING COPYRIGHT.

FOR ARCHITECTURAL DRAWINGS AND ELECTRONIC MEDIA, IT IS A VIOLATION OF TITLE VII, PART 69.5(B) OF THE NEW YORK STATE EDUCATION LAW FOR ANY PERSON, UNLESS ACTING UNDER THE DIRECTION OF A LICENSED ARCHITECT TO ALTER THIS DRAWING. IF ALTERED, SUCH ARCHITECT SHALL AFFIX THEIR SEAL, SIGNATURE, THE DATE, THE NOTATION "ALTERED BY", AND THE SPECIFIC DESCRIPTION OF THE ALTERATION.

WHERE DRAWINGS, ON PAPER OR ELECTRONIC MEDIA, SHOW EXISTING, NEW, AND/OR PROPOSED WORK AND CONDITIONS, IT IS UNDERSTOOD THAT IT IS SO SHOWN AS A MATTER OF INFORMATION AND THAT THE OWNER AND ARCHITECT, WHILE BELIEVING SUCH INFORMATION TO BE SUBSTANTIALLY CORRECT, ASSUME NO RESPONSIBILITY THEREFORE. THE USER SHALL MAKE THEMSELVES FAMILIAR WITH ALL CONDITIONS AFECTING THE NATI IPE AND MANIFER CONDITIONS AFFECTING THE NATURE AND MANNER
OF THEIR WORK INCLUDING VERIFICATION OF ALL

DIMENSIONS LOCATING EXISTING, PROPOSED, AND/OR NEW WORK AND CONDITIONS.

| REVISIONS: | | | | | | | | |
|------------|------|-------------|--|--|--|--|--|--|
| # | Date | Description | | | | | | |
| | | | | | | | | |
| | | | | | | | | |
| | | | | | | | | |
| | | | | | | | | |

CLIENT / OWNER:



Town of Warsaw 83 Center Street Warsaw, NY 14569

PROJECT INFORMATION:

Expansion and Renovation

Warsaw Public Library 130 North Main Street, Warsaw, New Yorl

PROJECT NUMBER: ISSUE DATE: April 25, 2025

LMY / TTN

DRAWN BY: SHEET TITLE:

Lower Level Floor Plan & Reflected Ceiling Plan

SHEET NUMBER:

| | | | | | RC | MOC | FINIS | H SCH | IEDUL | E - BASI | E BID | |
|------|------------------------|---------------|----|-------|-------|-----------------|-------|----------|---------|-------------|-----------------|--|
| ROOM | | FLOORING | | | | WA | LLS | | CEILIN | G | NOTES | GENERAL NOTES |
| | | FLOC |)R | BAS | SE | | | | | | | 1. Repair & refinish disturbed |
| NO. | NAME | MAT'L | FC | MAT'L | FC | MAT'L | FC | MAT'L | FC | HGHT. | | areas. 2. Paint all exg & new exposed |
| 001 | Meeting Room | cpt-1 | - | rbr | - | e gpdw/ gpdw | pnt-2 | apc | - | 8'-1" | - | elements in areas receiving work including, but not limited to |
| 002 | not used | - | - | - | - | - | - | - | - | - | - | walls, ceilings, utilities, ducts, |
| 003 | Children's Programming | cpt-1 / lvt-1 | - | rbr | - | e gpdw | pnt-2 | apc | - | 8'-0" | - | conduit. |
| 004 | Kitchenette | lvt-1 | - | rbr | - | e gpdw | pnt-2 | apc | - | 8'-0" | - | NOTES |
| 006 | Children's Collection | cpt-1 | - | wd | pnt-3 | gpdw | pnt-2 | apc/gpdw | -/pnt-3 | 7'-0"/8'-6" | (1) (3) (6) | Base bid includes carpet |
| 007 | Lower Rotunda | cpt-1 | - | wd | pnt-3 | e plas | pnt-1 | gpdw | pnt-3 | 9'-0" | (4) (8) | flooring only. 2. Install carpet over existing, |
| 800 | Children's Librarian | cpt-1 | - | e wd | pnt-3 | e plas | pnt-2 | e plas | pnt-3 | 9'-0" | - | asbestos containing flooring. 3. Base bid, prep and paint |
| 009 | Juvenile Fiction | cpt-1 | - | rbr | - | e gpdw | pnt-2 | e apc | - | 6'-4 1/2" | - | exg window. |
| 010 | Study Room | cpt-1 | - | e wd | pnt-3 | e plas | pnt-2 | e plas | pnt-3 | 9'-0" | (2) | 4. Laminate gpdw to exg plaster ceiling. |
| 012 | Young Adult | cpt-1 | - | wd | pnt-3 | e wd | - | apc/gpdw | -/pnt-3 | 7'-0"/8'-6" | (1) (3) (5) (6) | 5. Base bid, do not paint Young Adult room. Alternate |
| 013 | Hallway | cpt-1 | - | rbr | - | e gpdw | pnt-2 | арс | - | 8'-0" | - | No. 1: Prep and paint walls. 6. Alternate No. 1: replace |
| 015 | Storage | cpt-1 | - | rbr | - | gpdw | pnt-2 | - | - | - | - | ceiling. 7. Paint wainscot pnt-3. |
| 020 | Entry Hall | e vct | - | e rbr | - | e gpdw | pnt-2 | - | - | - | - | 7.1 ann waniscoi pin-3. |

| | | | | | ROC | OM FII | VISH | SCHEE | OULE - | - ALTERI | NATE 3 | |
|-----|------------------------|---------------|------|-------|-------|-----------------|-------------|----------|---------|-------------|-----------------|--|
| | ROOM | | FLOC | RING | | WA | LLS | | CEILIN | G | NOTES | GENERAL NOTES |
| | | FLOC | OR | BAS | SE . | | | | | | | 1. Repair & refinish disturbed |
| NO. | NAME | MAT'L | FC | MAT'L | FC | MAT'L | FC | MAT'L | FC | HGHT. | | areas. 2. Paint all exq & new exposed |
| 001 | Meeting Room | cpt-1 | - | rbr | - | e gpdw/ gpdw | pnt-2 | apc | - | 8'-1" | - | elements in areas receiving work including, but not limited to |
| 002 | not used | - | - | - | - | - | - | - | - | - | - | walls, ceilings, utilities, ducts, |
| 003 | Children's Programming | cpt-1 / lvt-1 | - | rbr | - | e gpdw | pnt-2 | apc | - | 8'-0" | - | conduit. |
| 004 | Kitchenette | lvt-1 | - | rbr | - | e gpdw | pnt-2 | apc | - | 8'-0" | - | NOTES |
| 006 | Children's Collection | cpt-1 | - | wd | pnt-7 | gpdw | pnt-2 | apc/gpdw | -/pnt-7 | 7'-0"/8'-6" | (1) (3) (6) | 1. Base bid includes carpet |
| 007 | Lower Rotunda | cpt-1 | - | wd | pnt-8 | e plas | pnt-1 | gpdw | pnt-2 | 9'-0" | (4) (8) | flooring only. 2. Install carpet over existing, |
| 800 | Children's Librarian | cpt-1 | - | e wd | pnt-7 | e plas | pnt-2 | e plas | pnt-7 | 9'-0" | - | asbestos containing flooring. 3. Base bid, prep and paint |
| 009 | Juvenile Fiction | cpt-1 | - | rbr | - | e gpdw | pnt-2 | e apc | - | 6'-4 1/2" | - | exg window. |
| 010 | Study Room | cpt-1 | - | e wd | pnt-7 | e plas | pnt-2 | e plas | pnt-7 | 9'-0" | (2) | 4. Laminate gpdw to exg plaster ceiling. |
| 012 | Young Adult | cpt-1 | - | wd | pnt-7 | e wd | - | apc/gpdw | -/pnt-7 | 7'-0"/8'-6" | (1) (3) (5) (6) | 5. Base bid, do not paint Young Adult room. Alternate |
| 013 | Hallway | cpt-1 | - | rbr | - | e gpdw | pnt-2 | apc | - | 8'-0" | - | No. 1: Prep and paint walls. 6. Alternate No. 1: replace |
| 015 | Storage | cpt-1 | - | rbr | - | gpdw | pnt-2 | - | - | - | - | ceiling. 7. Paint wainscot pnt-8. |
| 020 | Entry Hall | e vct | - | e rbr | _ | e gpdw | pnt-2 | - | - | - | - | 7. r ami wamscoi pni-o. |



32 Winthrop Street, Rochester, NY 14607 (585) 262-2035 | www.beroarchitecture.com

STAMP:

© 2025 Bero Architecture PLLC

CLIENT / OWNER:

Town of Warsaw 83 Center Street Warsaw, NY 14569

PROJECT INFORMATION:

Expansion and Renovation Warsaw Public Library 130 North Main Street, Warsaw, NY

 PROJECT #:
 22121

 ISSUE DATE:
 June 13, 2025

 DRAWN BY:
 TTN


 SCALE:
 N/A

SHEET TITLE:

Lower Level Room Finish Schedule

SHEET NUMBER:

A-10Addendum #2

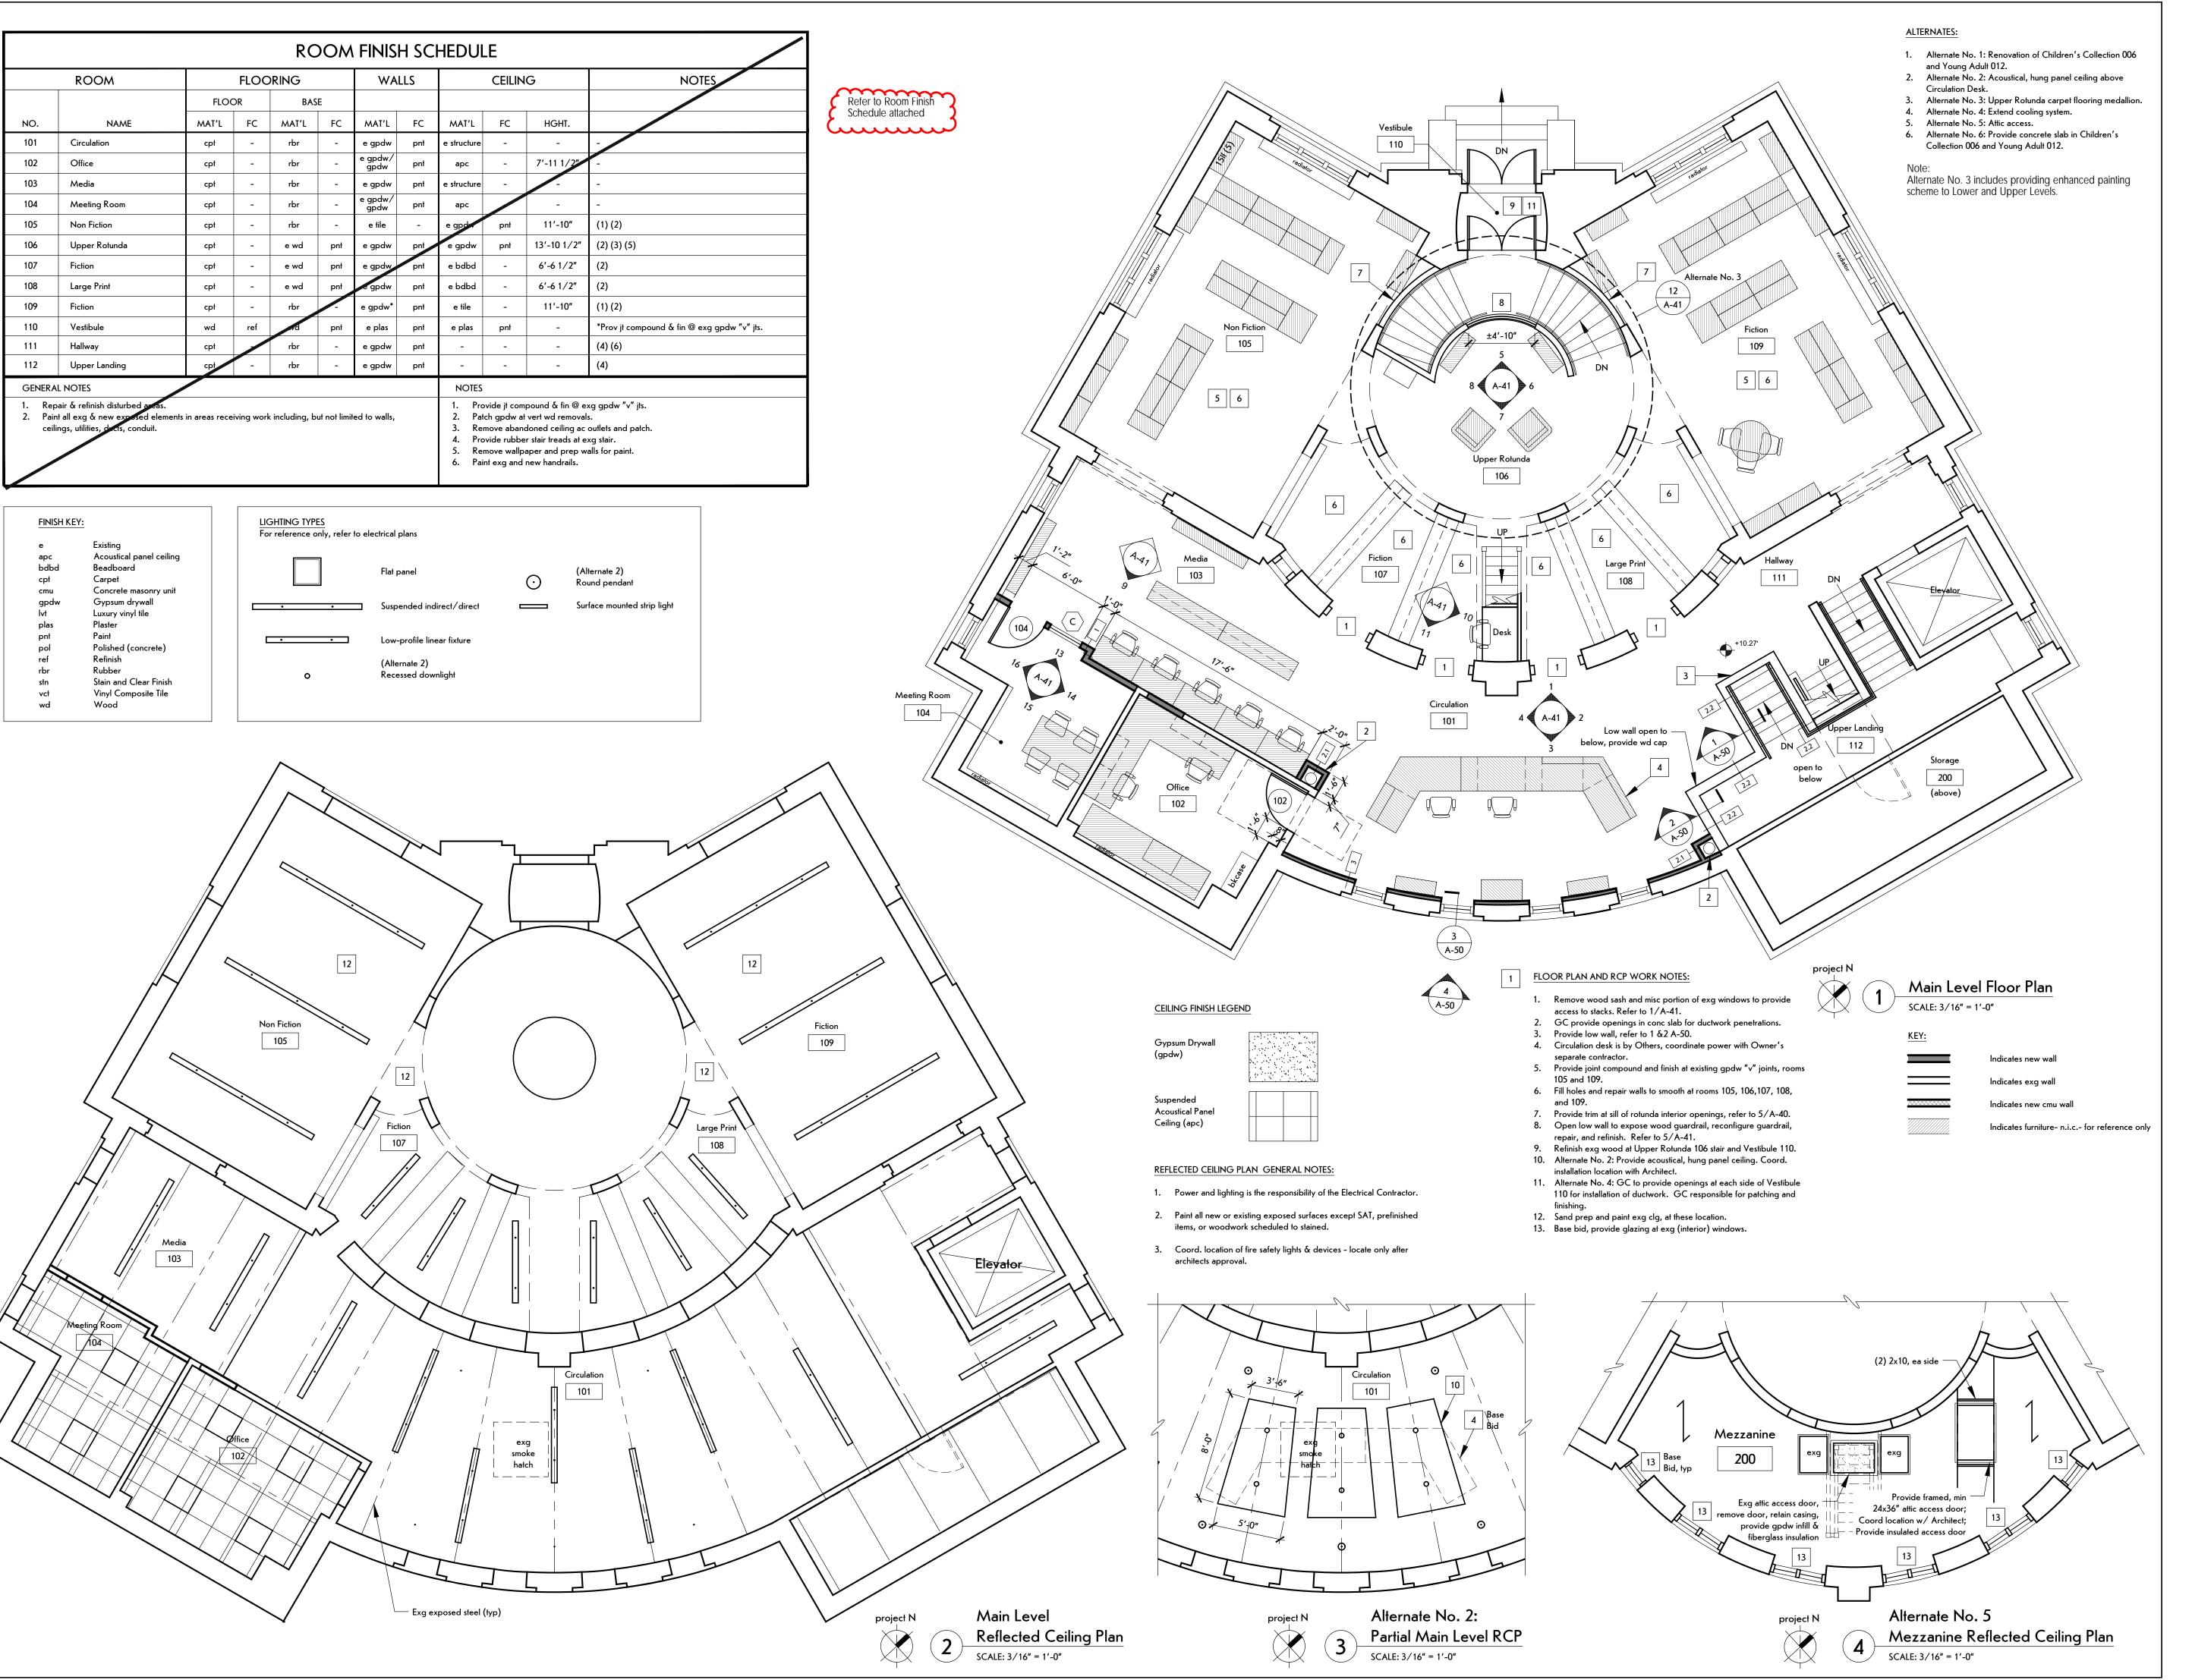







1653 East Main Street Rochester, NY 14609

MEP/FP ENGINEER:



315 Rockingham Street Rochester, NY 14620

WARNING:

DRAWINGS, SPECIFICATIONS AND OTHER
DOCUMENTS, INCLUDING THOSE IN ELECTRONIC
FORM, PREPARED BY BERO ARCHITECTURE PLLC ARE
INSTRUMENTS OF SERVICE FOR USE SOLELY WITH
RESPECT TO THE PROJECT FOR WHICH THEY WERE

RESPECI TO THE I ROJECTION.

CREATED. THE ARCHITECT RETAINS ALL COMMON LAW, STATUTORY AND OTHER RESERVED RIGHTS, INCLUDING COPYRIGHT.

FOR ARCHITECTURAL DRAWINGS AND ELECTRONIC MEDIA, IT IS A VIOLATION OF THE VII, PART 69.5(B) OF THE NEW YORK STATE EDUCATION LAW FOR ANY PERSON, UNLESS ACTING UNDER THE DIRECTION OF A LICENSED ARCHITECT TO ALTER THIS DRAWING. IF ALTERED, SUCH ARCHITECT SHALL AFFIX THEIR SEAL, SIGNATURE, THE DATE, THE NOTATION "ALTERED BY",

SIGNATURE, THE DATE, THE NOTATION "ALTERED BY", AND THE SPECIFIC DESCRIPTION OF THE ALTERATION.

WHERE DRAWINGS, ON PAPER OR ELECTRONIC MEDIA, SHOW EXISTING, NEW, AND/OR PROPOSED WORK AND CONDITIONS, IT IS UNDERSTOOD THAT IT IS SO SHOWN AS A MATTER OF INFORMATION AND THAT THE OWNER AND ARCHITECT, WHILE BELIEVING SUCH INFORMATION TO BE SUBSTANTIALLY CORRECT, ASSUME NO RESPONSIBILITY THEREFORE. THE USER SHALL MAKE THEMSELYES FAMILIAR WITH ALL

ASSUME NO RESPONSIBILITY THEREFORE. THE USER SHALL MAKE THEMSELVES FAMILIAR WITH ALL CONDITIONS AFFECTING THE NATURE AND MANNER OF THEIR WORK INCLUDING VERIFICATION OF ALL DIMENSIONS LOCATING EXISTING, PROPOSED, AND/OR NEW WORK AND CONDITIONS.

REVISIONS:

| # | Date | Description | | | | | | |
|-----------------|------|-------------|--|--|--|--|--|--|
| | | | | | | | | |
| | | | | | | | | |
| | | | | | | | | |
| | | | | | | | | |
| CLIENT / OWNER: | | | | | | | | |
| | | | | | | | | |



Town of Warsaw 83 Center Street

83 Center Street Warsaw, NY 14569

PROJECT INFORMATION:

Expansion and Renovation

Expansion and Renovation
Warsaw Public Library
130 North Main Street, Warsaw, New York

130 North Main Street, Warsaw, New York
PROJECT NUMBER: 22121

ISSUE DATE: April 25, 2025

LMY / TTN

DRAWN BY: SHEET TITLE:

Main Level Floor Plan &

Reflected Ceiling Plan

ROOM FINISH SCHEDULE - BASE BID

| | ROOM | | FLOC | RING | | WA | LLS | | CEILIN | G | NOTES | GENERAL NOTES |
|-----|---------------|-------|------|-------|-------|-------------------|-------|-------------|--------|-------------|---|--|
| | | FLO | OR | BAS | SE. | | | | | | | 1. Repair & refinish disturbed areas. |
| NO. | NAME | MAT'L | FC | MAT'L | FC | MAT'L | FC | MAT'L | FC | нднт. | | 2. Paint all exg & new exposed elements in areas receiving work including, but no |
| 101 | Circulation | cpt-1 | - | rbr | - | e gpdw/ e gpdw | pnt-1 | e structure | - | - | (8) | limited to walls, ceilings, utilities, ducts, conduit. |
| 102 | Office | cpt-1 | - | rbr | - | e gpdw/ gpdw | pnt-1 | apc | - | 7'-11 1/2" | - | |
| 103 | Media | cpt-1 | - | rbr | - | e gpdw | pnt-1 | e structure | - | - | - | NOTES |
| 104 | Meeting Room | cpt-1 | - | rbr | - | e gpdw/ gpdw | pnt-1 | apc | - | - | - | 1. Provide jt compound & fin @ exg |
| 105 | Non Fiction | cpt-1 | - | rbr | - | e tile | - | e gpdw* | pnt-3 | 11'-10" | (1) (2) | gpdw "v" jts. 2. Patch gpdw at vert wd removals. |
| 106 | Upper Rotunda | cpt-1 | - | e wd | pnt-3 | e gpdw | pnt-1 | e gpdw | pnt-3 | 13'-10 1/2" | (2) (3) (5) (7) | 3. Remove abandoned ceiling ac outlets and patch. |
| 107 | Fiction | cpt-1 | - | e wd | pnt-3 | e gpdw | pnt-1 | e bdbd | - | 6'-6 1/2" | (2) | Provide rubber stair treads at exg stai Remove wallpaper and prep walls for |
| 108 | Large Print | cpt-1 | - | e wd | pnt-3 | e gpdw | pnt-1 | e bdbd | - | 6'-6 1/2" | (2) | paint. |
| 109 | Fiction | cpt-1 | - | rbr | - | e gpdw* | pnt-1 | e tile | - | 11'-10" | (1) (2) | 6. Paint exg and new handrails.7. Remove and replace exg cpt from |
| 110 | Vestibule | wd | ref | wd | pnt-3 | e plas | pnt-1 | e plas | pnt-3 | - | *Prov jt compound & fin @ exg gpdw "v" jts. | lowest riser at Upper Rotunda 106 to include top nosing and Mezzanine 200 |
| 111 | Hallway | cpt-1 | - | rbr | - | e gpdw | pnt-1 | - | - | - | (4) (6) | floor level. Mezzanine 200 carpeting to remain in place. |
| 112 | Upper Landing | cpt-1 | - | rbr | - | e gpdw | pnt-1 | - | - | - | (4) | 8. Paint exg wd trim at masonry opening |
| 200 | Mezzanine | cpt-1 | _ | _ | _ | - | - | - | - | - | (7) | pnt-3. |

| DOOM | EINIICH | CCHEDI | | ITEDNIATE | 2 |
|---------|---------|--------|----------|-----------|----|
| K(J(J)M | FINI2H | SCHEDU | 11 F - A | LTERNATE | .5 |

| | ROOM | | FLOC | PRING | | WA | LLS | | CEILIN | IG | NOTES | GENERAL NOTES |
|-----|---------------|-------|------|-------|-------|-------------------|-------|-------------|--------|-------------|---|--|
| | | FLO | OR | BAS | SE | | | | | | | 1. Repair & refinish disturbed areas. |
| NO. | NAME | MAT'L | FC | MAT'L | FC | MAT'L | FC | MAT'L | FC | нднт. | | 2. Paint all exg & new exposed elements in areas receiving work including, but not |
| 101 | Circulation | cpt-1 | - | rbr | - | e gpdw/ e gpdw | pnt-5 | e structure | - | - | (8) | limited to walls, ceilings, utilities, ducts, |
| 102 | Office | cpt-1 | _ | rbr | - | e gpdw/ gpdw | pnt-5 | apc | - | 7'-11 1/2" | - | |
| 103 | Media | cpt-1 | - | rbr | - | e gpdw | pnt-5 | e structure | - | - | - | NOTES |
| 104 | Meeting Room | cpt-1 | - | rbr | - | e gpdw/ gpdw | pnt-5 | apc | - | - | - | 1. Provide jt compound & fin @ exg gpdw "v" jts. 2. Patch gpdw at vert wd removals. |
| 105 | Non Fiction | cpt-1 | - | rbr | - | e tile | - | e gpdw* | pnt-2 | 11'-10" | (1) (2) | |
| 106 | Upper Rotunda | cpt-1 | - | e wd | pnt-8 | e gpdw | pnt-1 | e gpdw | pnt-2 | 13'-10 1/2" | (2) (3) (5) (7) | 3. Remove abandoned ceiling ac outlets and patch. |
| 107 | Fiction | cpt-1 | - | e wd | pnt-8 | e gpdw | pnt-4 | e bdbd | - | 6'-6 1/2" | (2) | 4. Provide rubber stair treads at exg stair. 5. Remove wallpaper and prep walls for |
| 108 | Large Print | cpt-1 | - | e wd | pnt-8 | e gpdw | pnt-4 | e bdbd | - | 6'-6 1/2" | (2) | paint. |
| 109 | Fiction | cpt-1 | - | rbr | - | e gpdw* | pnt-4 | e file | - | 11'-10" | (1) (2) | 6. Paint exg and new handrails pnt-8.7. Remove and replace exg cpt from |
| 110 | Vestibule | wd | ref | wd | pnt-8 | e plas | pnt-3 | e plas | pnt-1 | - | *Prov jt compound & fin @ exg gpdw "v" jts. | lowest riser at Upper Rotunda 106 to include top nosing and Mezzanine 200 floor level. Mezzanine 200 carpeting to remain in place. 8. Paint exg wd trim at masonry openings |
| 111 | Hallway | cpt-1 | - | rbr | - | e gpdw | pnt-5 | - | - | - | (4) (6) | |
| 112 | Upper Landing | cpt-1 | - | rbr | - | e gpdw | pnt-5 | - | - | - | (4) | |
| 200 | Mezzanine | cpt-1 | _ | - | - | - | - | - | | - | (7) | pnt-6. |

32 Winthrop Street, Rochester, NY 14607

(585) 262-2035 | www.beroarchitecture.com

STAMP:

© 2025 Bero Architecture PLLC

CLIENT / OWNER:

Town of Warsaw 83 Center Street Warsaw, NY 14569

PROJECT INFORMATION:

Expansion and Renovation Warsaw Public Library 130 North Main Street, Warsaw, NY

PROJECT #: 22121 ISSUE DATE: June 13, 2025 DRAWN BY: TTN SCALE: N/A

SHEET TITLE:


Main Level Room Finish Schedule

SHEET NUMBER:

Addendum #2

OTES

- Provide jt compound & fin @ exg odw "v" jts.
- Patch gpdw at vert wd removals.
- Remove abandoned ceiling ac outlets nd patch.
- Provide rubber stair treads at exg stair.
- Remove wallpaper and prep walls for
- Paint exq and new handrails pnt-8.
- Remove and replace exg cpt from vest riser at Upper Rotunda 106 to lude top nosing and Mezzanine 200 or level. Mezzanine 200 carpeting to nain in place.
- Paint exg wd trim at masonry openings

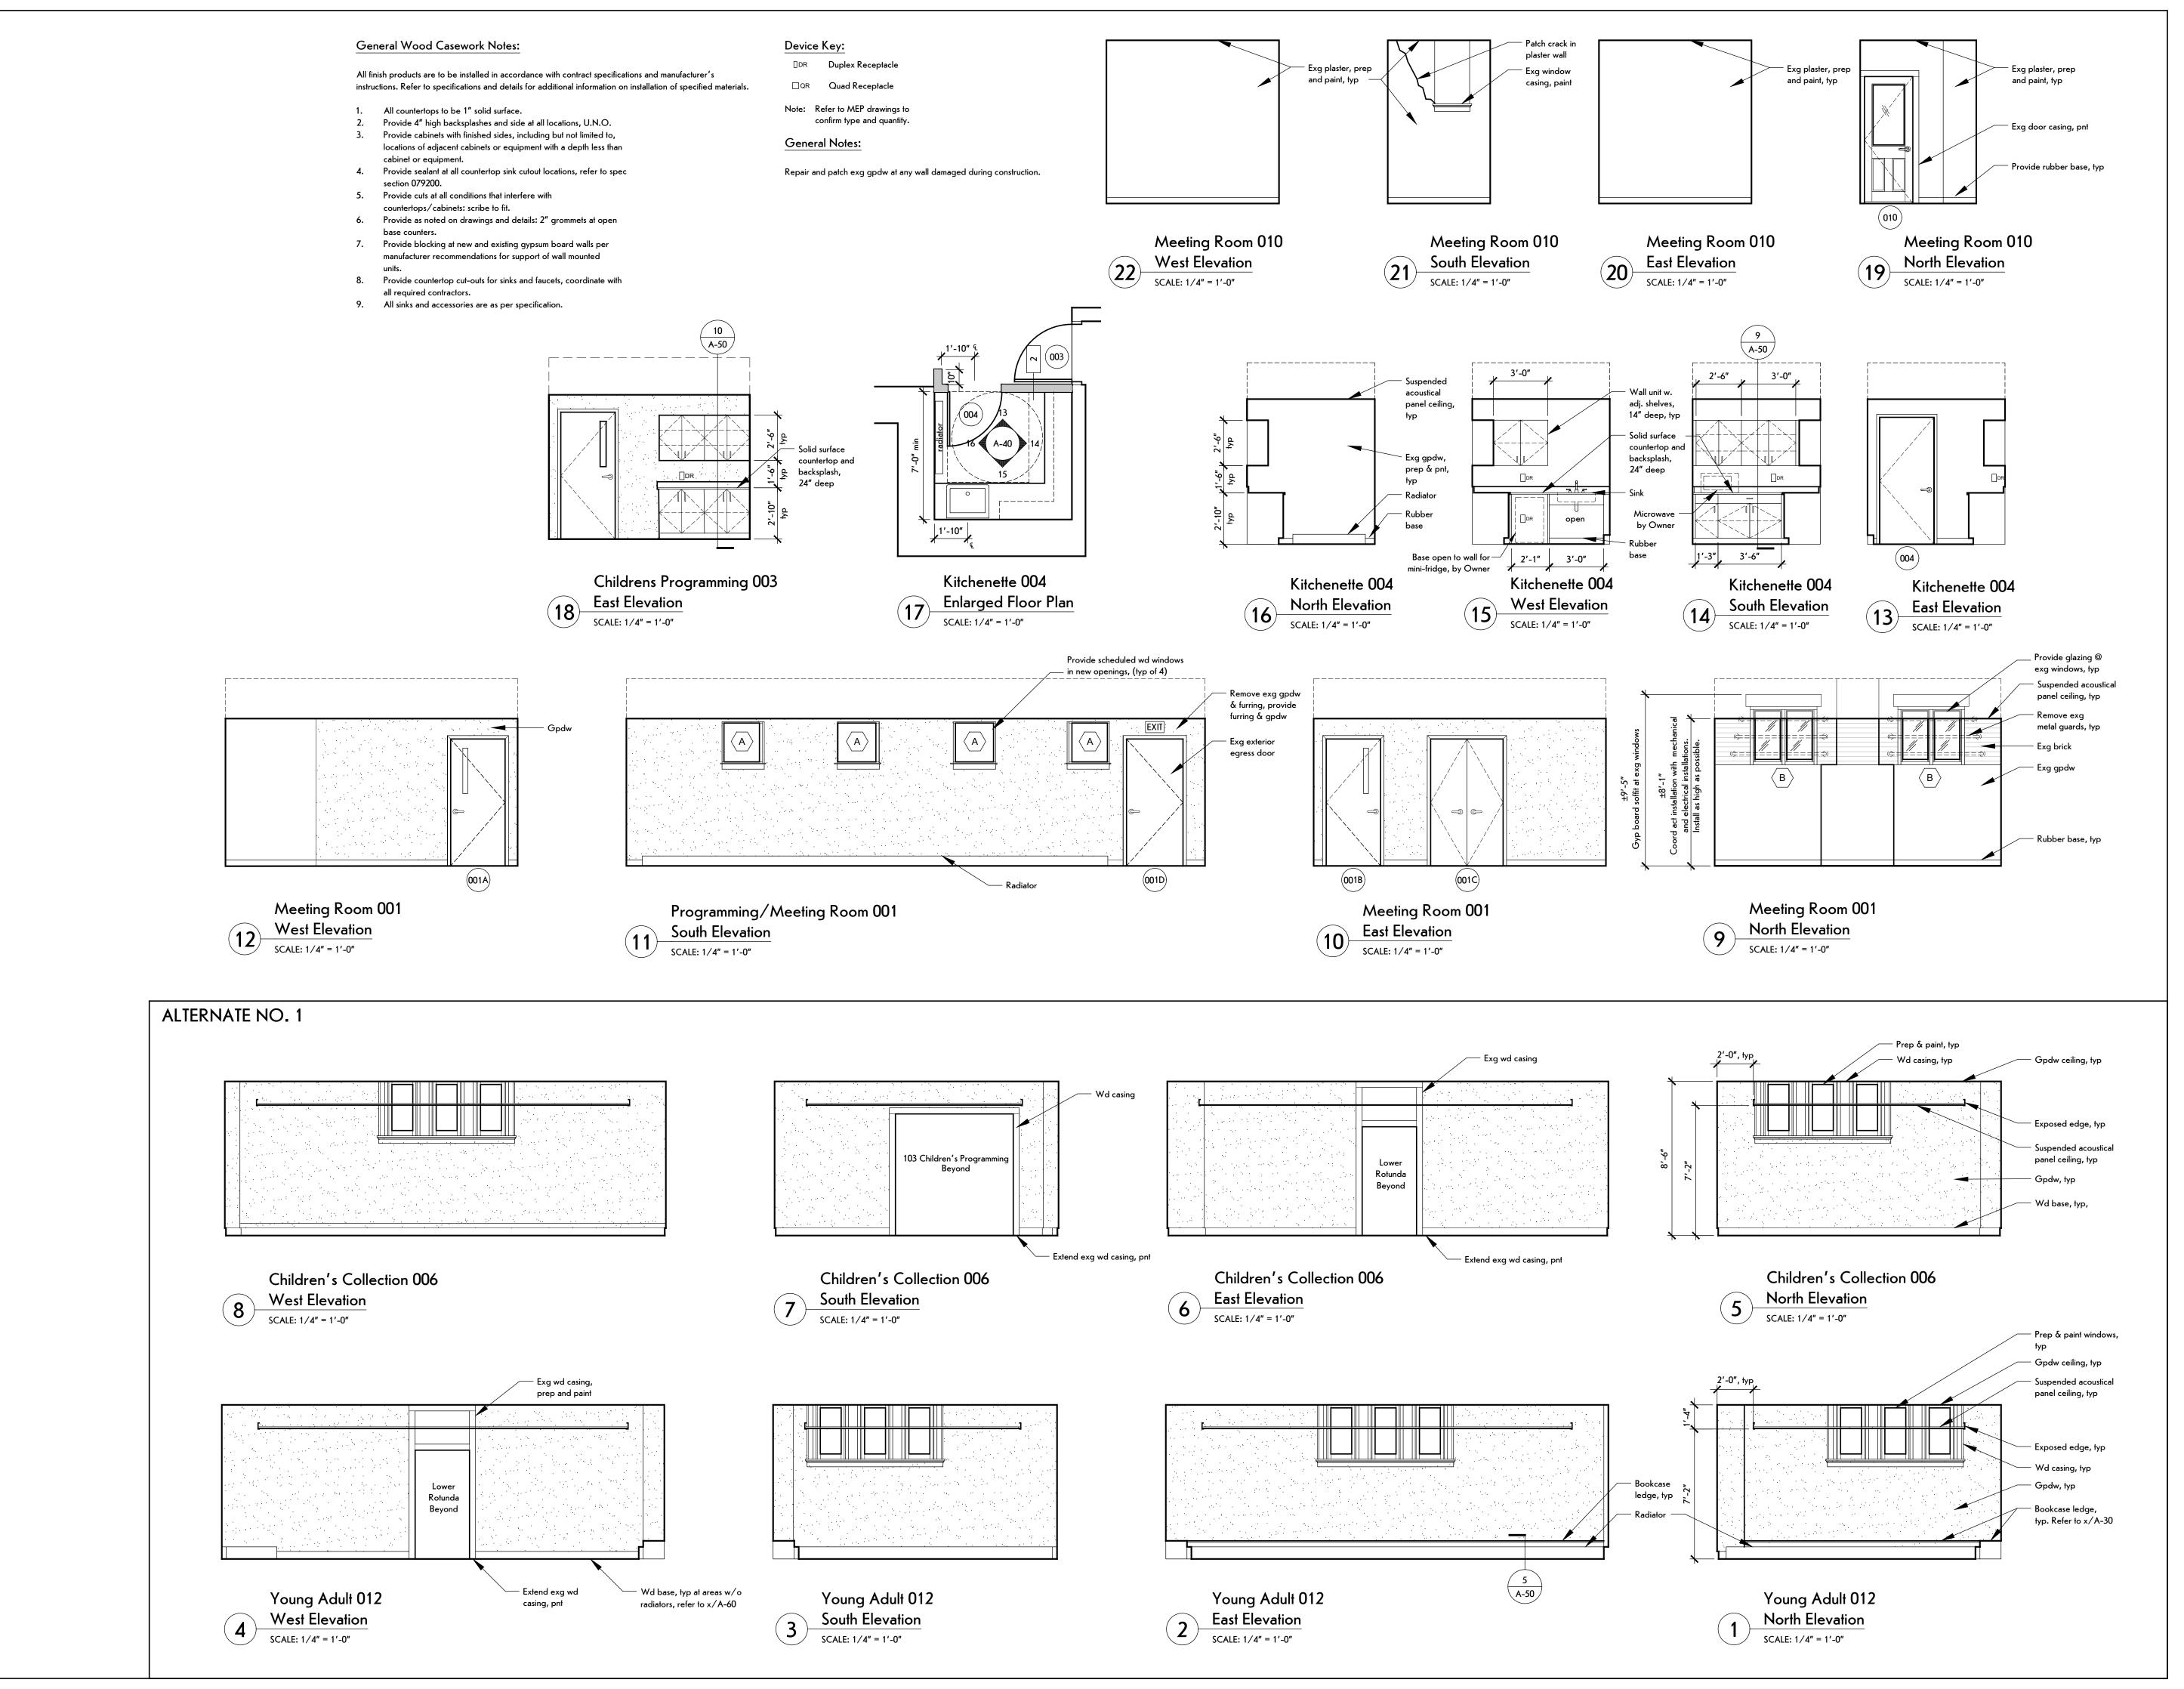







1653 East Main Street Rochester, NY 14609

MEP/FP ENGINEER:




315 Rockingham Street Rochester, NY 14620

WARNING:

DRAWINGS, SPECIFICATIONS AND OTHER
DOCUMENTS, INCLUDING THOSE IN ELECTRONIC
FORM, PREPARED BY BERO ARCHITECTURE PILC ARE
INSTRUMENTS OF SERVICE FOR USE SOLELY WITH
RESPECT TO THE PROJECT FOR WHICH THEY WERE
CREATED. THE ARCHITECT RETAINS ALL COMMON LAW,
STATUTORY AND OTHER RESERVED RIGHTS, INCLUDING
COPYRIGHT.

FOR ARCHITECTURAL DRAWINGS AND ELECTRONIC MEDIA, IT IS A VIOLATION OF TITLE VII, PART 69.5(B) OF THE NEW YORK STATE EDUCATION LAW FOR ANY PERSON, UNLESS ACTING UNDER THE DIRECTION OF A LICENSED ARCHITECT TO ALTER THIS DRAWING. IF ALTERED, SUCH ARCHITECT SHALL AFFIX THEIR SEAL, SIGNATURE, THE DATE, THE NOTATION "ALTERED BY", AND THE SPECIFIC DESCRIPTION OF THE ALTERATION.

WHERE DRAWINGS, ON PAPER OR ELECTRONIC MEDIA, SHOW EXISTING, NEW, AND/OR PROPOSED WORK AND CONDITIONS, IT IS UNDERSTOOD THAT IT IS SO SHOWN AS A MATTER OF INFORMATION AND THAT THE OWNER AND ARCHITECT, WHILE BELIEVING SUCH INFORMATION TO BE SUBSTANTIALLY CORRECT, ASSUME NO RESPONSIBILITY THEREFORE. THE USER SHALL MAKE THEMSELVES FAMILIAR WITH ALL CONDITIONS AFFECTING THE NATURE AND MANNER OF THEIR WORK INCLUDING VERIFICATION OF ALL DIMENSIONS LOCATING EXISTING, PROPOSED, AND/OR NEW WORK AND CONDITIONS.

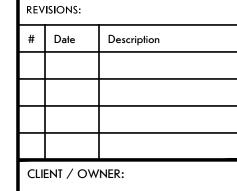



Town of Warsaw 83 Center Street Warsaw, NY 14569

PROJECT INFORMATION:

Expansion and Renovation

Warsaw Public Library

130 North Main Street, Warsaw, New Yor


PROJECT NUMBER: 2212

DRAWN BY: LMY / TIN


SHEET TITLE:

Lower Level

Interior Elevations

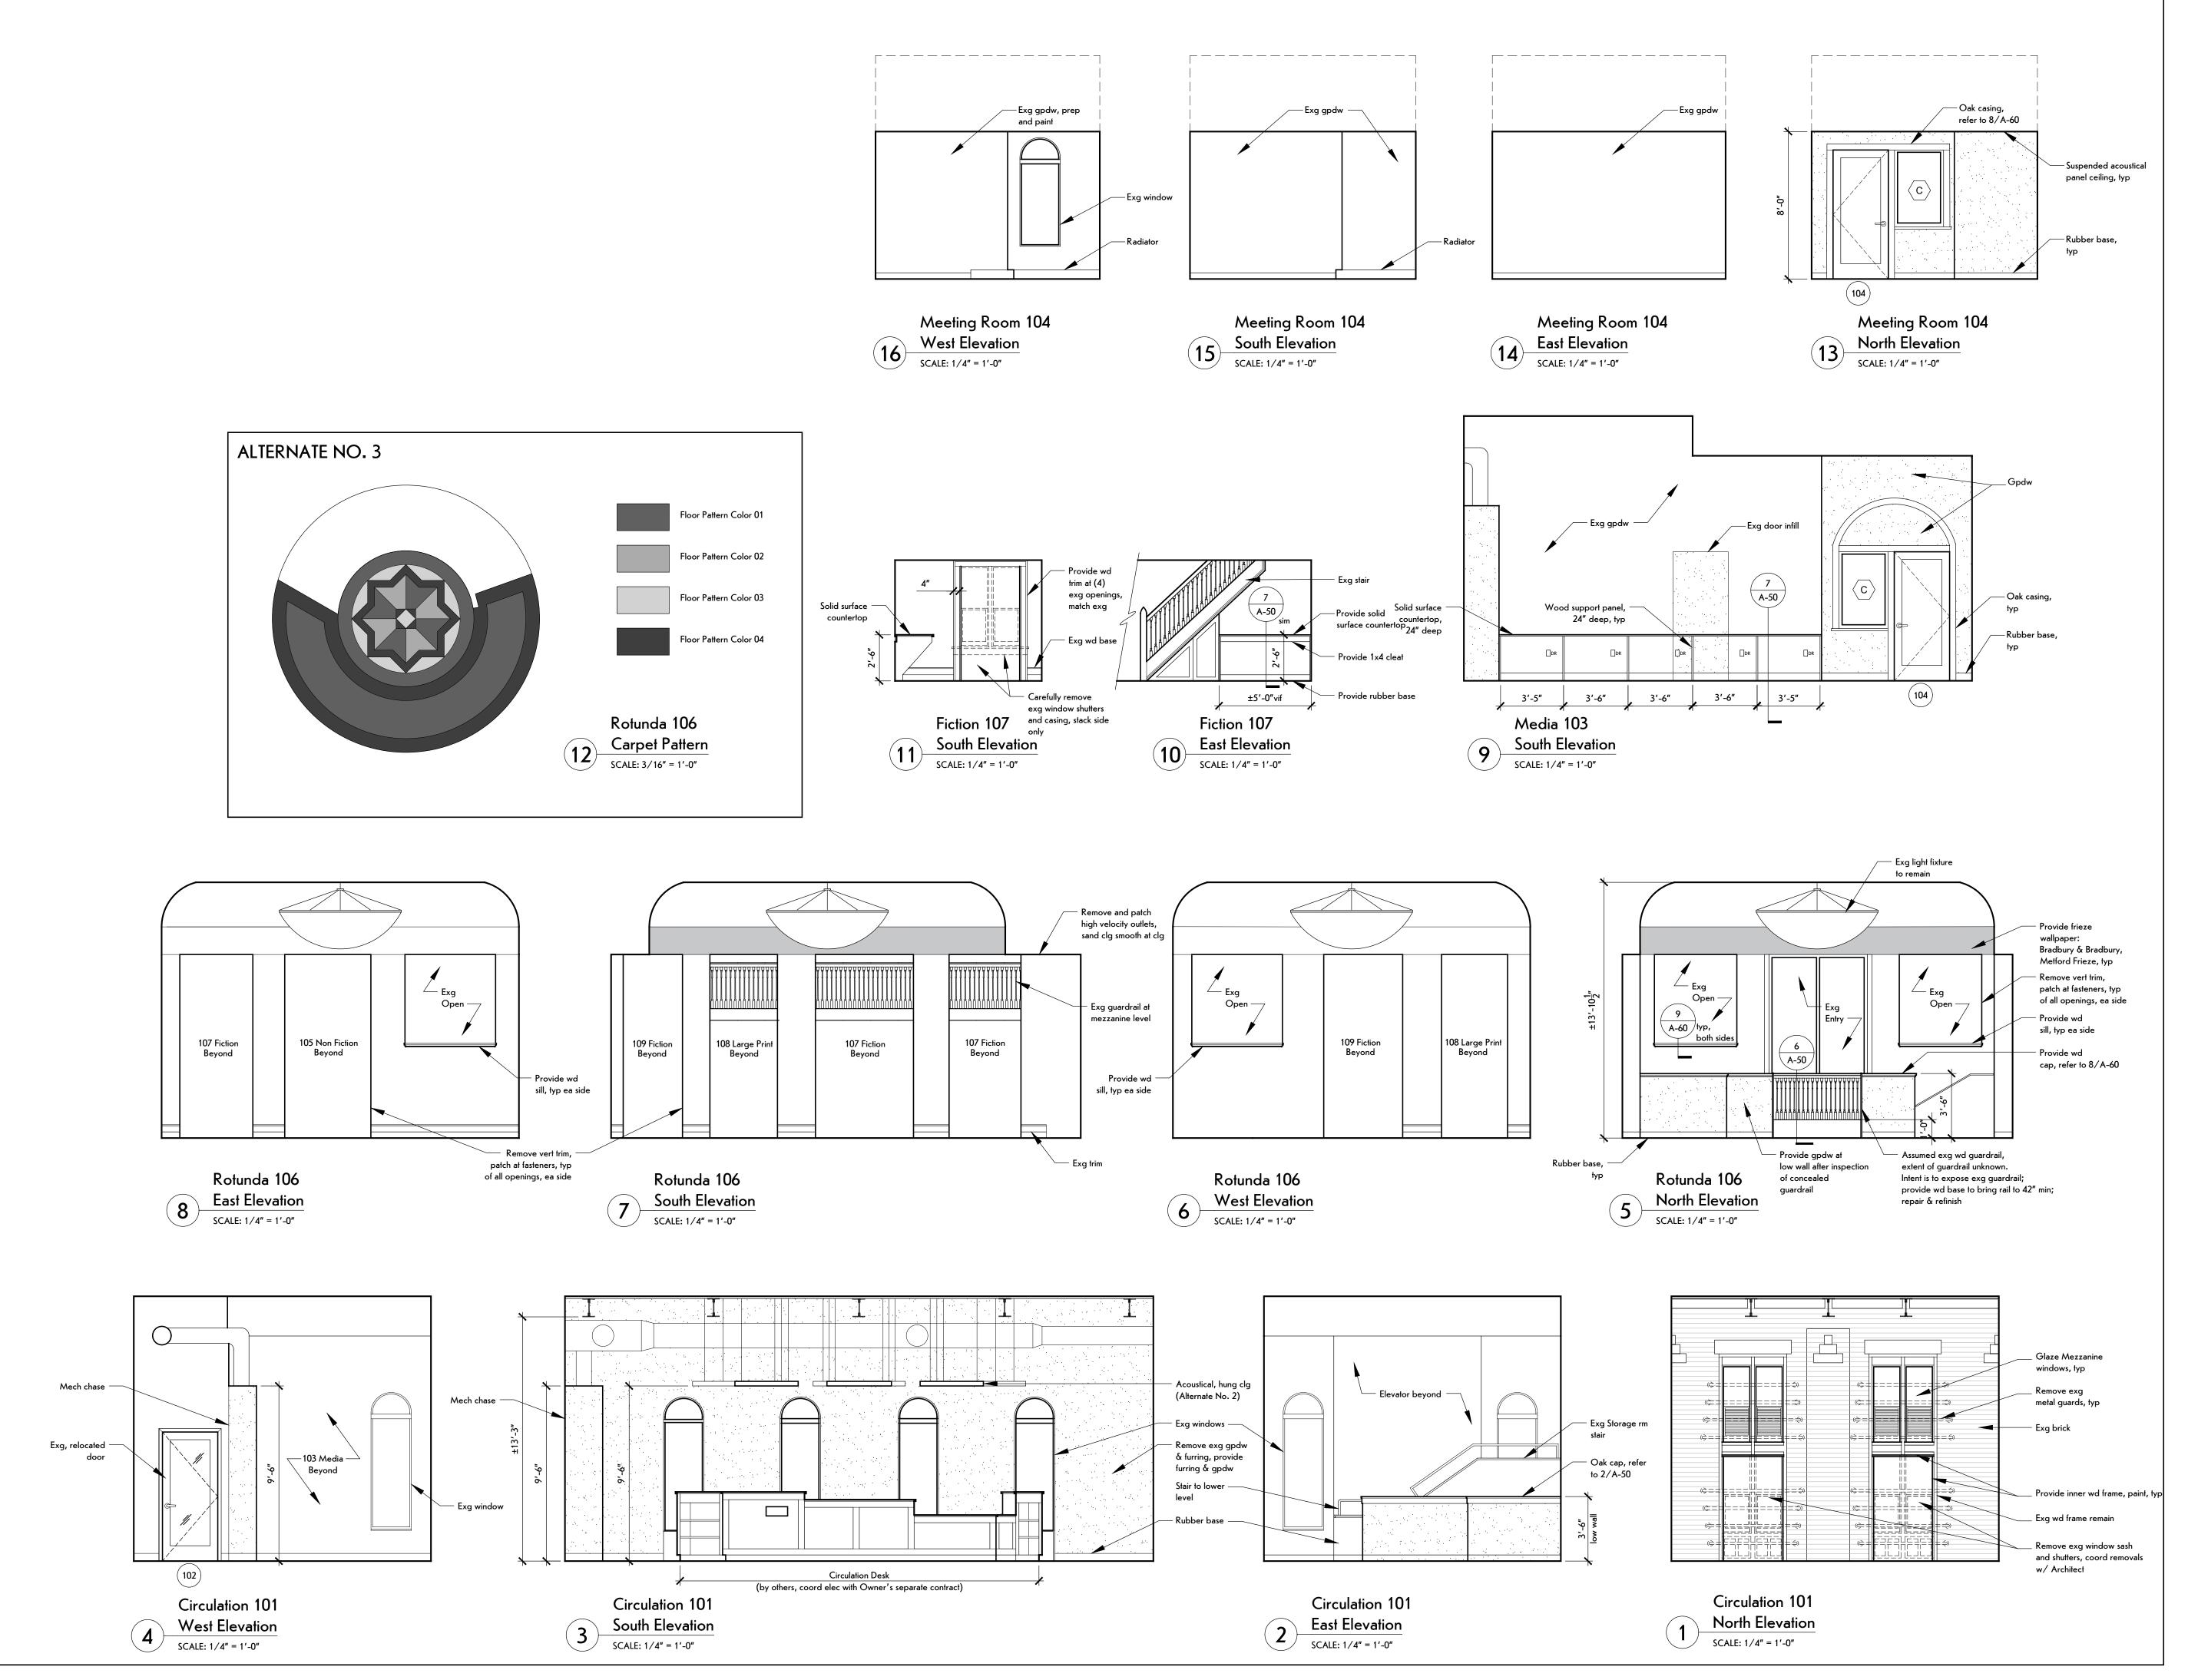



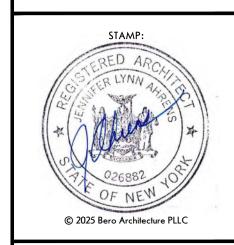



Rochester, NY 14609

1653 East Main Street

MEP/FP ENGINEER:



315 Rockingham Street Rochester, NY 14620

WAPNING

WARNING:

DRAWINGS, SPECIFICATIONS AND OTHER DOCUMENTS, INCLUDING THOSE IN ELECTRONIC FORM, PREPARED BY BERO ARCHITECTURE PLLC ARE INSTRUMENTS OF SERVICE FOR USE SOLELY WITH RESPECT TO THE PROJECT FOR WHICH THEY WERE CREATED. THE ARCHITECT RETAINS ALL COMMON LAW, STATUTORY AND OTHER RESERVED RIGHTS, INCLUDING

FOR ARCHITECTURAL DRAWINGS AND ELECTRONIC MEDIA, IT IS A VIOLATION OF TITLE VII, PART 69.5(B) OF THE NEW YORK STATE EDUCATION LAW FOR ANY PERSON, UNLESS ACTING UNDER THE DIRECTION OF A LICENSED ARCHITECT TO ALTER THIS DRAWING. IF ALTERED, SUCH ARCHITECT SHALL AFFIX THEIR SEAL, SIGNATURE, THE DATE, THE NOTATION "ALTERED BY", AND THE SPECIFIC DESCRIPTION OF THE ALTERATION.

WHERE DRAWINGS, ON PAPER OR ELECTRONIC MEDIA, SHOW EXISTING, NEW, AND/OR PROPOSED WORK AND CONDITIONS, IT IS UNDERSTOOD THAT IT IS SO SHOWN AS A MATTER OF INFORMATION AND THAT THE OWNER AND ARCHITECT, WHILE BELIEVING SUCH INFORMATION TO BE SUBSTANTIALLY CORRECT, ASSUME NO RESPONSIBILITY THEREFORE. THE USER SHALL MAKE THEMSELVES FAMILIAR WITH ALL CONDITIONS AFFECTING THE NATURE AND MANNER OF THEIR WORK INCLUDING VERIFICATION OF ALL DIMENSIONS LOCATING EXISTING, PROPOSED,

AND/OR NEW WORK AND CONDITIONS.

| REVISIONS: | | | | | | |
|------------|-----------|-------------|--|--|--|--|
| # | Date | Description | | | | |
| | | | | | | |
| | | | | | | |
| | | | | | | |
| | | | | | | |
| CIII | ENIT / OW | NED. | | | | |



Town of Warsaw 83 Center Street Warsaw, NY 14569

PROJECT INFORMATION:

Expansion and Renovation Warsaw Public Library 130 North Main Street, Warsaw, New York


PROJECT NUMBER: 22121

ISSUE DATE: April 25, 2025

DRAWN BY: LMY / TIN

Main Level
Interior Elevations

SHEET NUMBER:

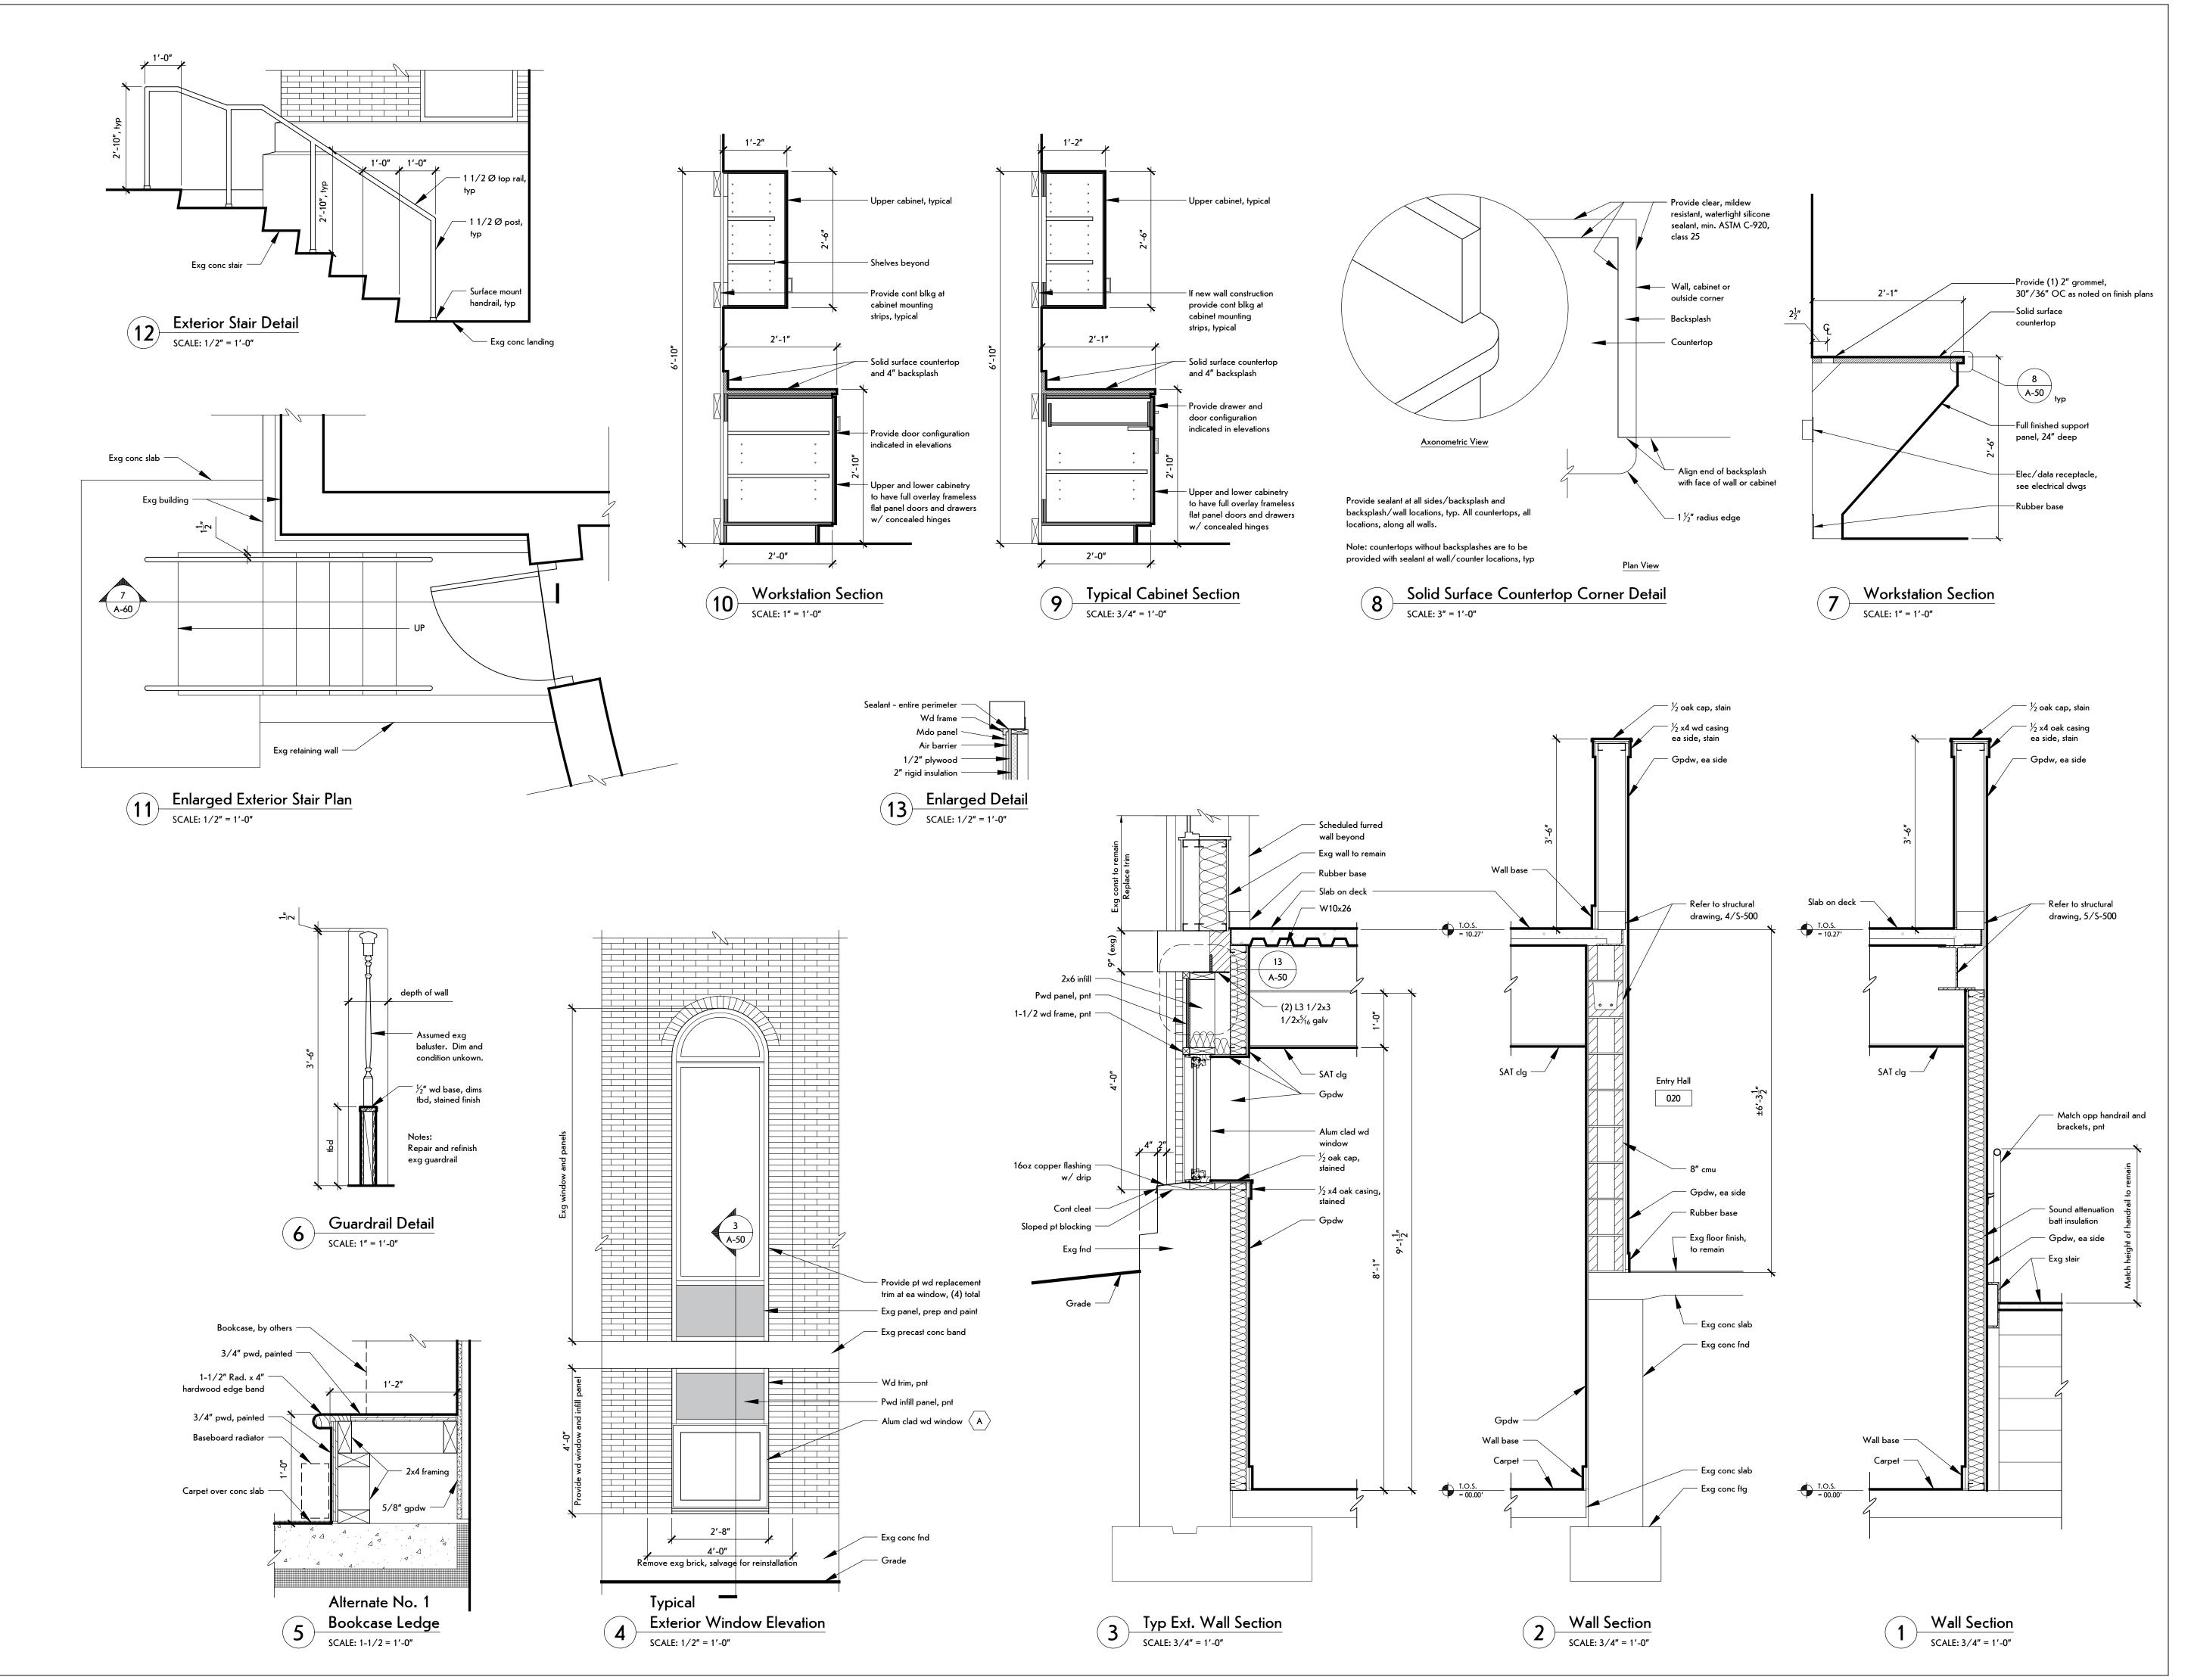







1653 East Main Street Rochester, NY 14609

MEP/FP ENGINEER:



315 Rockingham Street Rochester, NY 14620

WARNING:

DRAWINGS, SPECIFICATIONS AND OTHER
DOCUMENTS, INCLUDING THOSE IN ELECTRONIC
FORM, PREPARED BY BERO ARCHITECTURE PLLC ARE
INSTRUMENTS OF SERVICE FOR USE SOLELY WITH
RESPECT TO THE PROJECT FOR WHICH THEY WERE
CREATED. THE ARCHITECT RETAINS ALL COMMON LAW,
STATUTORY AND OTHER RESERVED RIGHTS, INCLUDING
COPYRIGHT.

FOR ARCHITECTURAL DRAWINGS AND ELECTRONIC MEDIA, IT IS A VIOLATION OF TITLE VII, PART 69.5(B) OF THE NEW YORK STATE EDUCATION LAW FOR ANY PERSON, UNLESS ACTING UNDER THE DIRECTION OF A LICENSED ARCHITECT TO ALTER THIS DRAWING. IF ALTERED, SUCH ARCHITECT SHALL AFFIX THEIR SEAL, SIGNATURE, THE DATE, THE NOTATION "ALTERED BY", AND THE SPECIFIC DESCRIPTION OF THE ALTERATION.

WHERE DRAWINGS, ON PAPER OR ELECTRONIC MEDIA, SHOW EXISTING, NEW, AND/OR PROPOSED WORK AND CONDITIONS, IT IS UNDERSTOOD THAT IT IS SO SHOWN AS A MATTER OF INFORMATION AND THAT THE OWNER AND ARCHITECT, WHILE BELIEVING SUCH INFORMATION TO BE SUBSTANTIALLY CORRECT, ASSUME NO RESPONSIBILITY THEREFORE. THE USER SHALL MAKE THEMSELVES FAMILIAR WITH ALL CONDITIONS AFFECTING THE NATURE AND MANNER OF THEIR WORK INCLUDING VERIFICATION OF ALL DIMENSIONS LOCATING EXISTING, PROPOSED, AND/OR NEW WORK AND CONDITIONS.

| REVISIONS: | | | | | | | |
|-----------------|------|-------------|--|--|--|--|--|
| # | Date | Description | | | | | |
| | | | | | | | |
| | | | | | | | |
| | | | | | | | |
| | | | | | | | |
| CLIENT / OWNER: | | | | | | | |



Town of Warsaw 83 Center Street Warsaw, NY 14569

PROJECT INFORMATION:

Expansion and Renovation

Warsaw Public Library

130 North Main Street, Warsaw, New York

PROJECT NUMBER: 22121


ISSUE DATE: April 25, 2025

LMY / TTN

DRAWN BY: SHEET TITLE:

Enlarged Plans

& Details

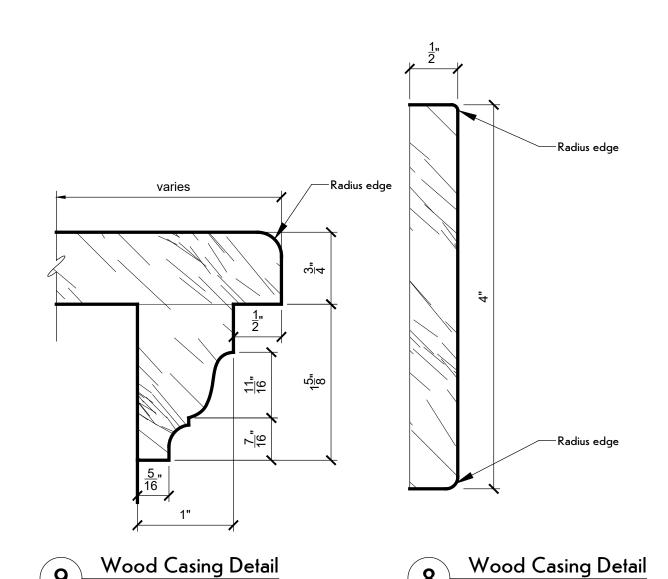

| | | | | | | | | DOOR | 2CHED | ULE | | | | | |
|------|-------|-------|--------|------|------|-------------------------------|--------------|--------|-------|--------------------|--------|-----------------|--------|-------|------------------------|
| DOOR | S | | | | | | | | FRAME | :S | | | | | |
| DOOR | | SIZE | | MAT. | TYPE | FINISH | GLASS | RATING | MAT. | TYPE | FINISH | FRAME | WALL | HARD | REMARKS/NOTES |
| NO. | W | Н | T | | | | | | | | | ANCHORAGE | THK | WARE | |
| 001A | 3'-0" | 7'-0" | 1-3/4′ | hm | 1 | pnt | GL-1 | | hm | | pnt | 4/A-60 | 5 3/8" | SET A | |
| 001B | 3'-0" | 7'-0" | 1-3/4' | hm | 1 | pnt | GL-1 | 3/4 hr | hm | | pnt | 4/A-60 | 4 7/8" | SET A | |
| 001C | 3'-0" | 7'-0" | 1-3/4' | hm | 2 | pnt | | | hm | | pnt | 4/A-60 | 5 3/8" | SET B | |
| 001D | 3'-0" | 7'-0" | 1-3/4' | hm | | Existing to | remain — | | | Existing to remain | | | | | |
| 003 | 3'-2" | 7'-0" | 1-3/4' | hm | 2 | pnt | | 3/4 hr | hm | | pnt | 4/A-60 | 9" | SET B | |
| 004 | 3'-0" | 7'-0" | 1-3/4' | hm | 2 | pnt | - | | hm | | pnt | 4/A-60 | 4 7/8" | SET C | |
| 800 | 2'-8" | 7'-0" | 1-3/4' | wd | | Existing to | remain — | | | Existing to remain | | | | | |
| 010 | 2'-8" | 7'-0" | 1-3/4' | wd | 3 | pnt | GL-1 | | wd | | pnt | 5/A-60 | 5" | SET C | Undercut 1" |
| 011 | 3'-0" | 7'-0" | 1-3/4' | wd | | Existing to | remain — | | | | Exis | sting to remain | - | | |
| 013 | 3'-0" | 7'-0" | 1-3/4' | hm | | Existing to | remain — | | | | Exis | sting to remain | | | |
| 102 | 3'-0" | 7'-0" | 1-3/4' | wd | | — Relocated | I Existing — | | wd | | pnt | 5/A-60 | 4 7/8" | SET C | Reinstall salvaged doo |
| 104 | 3'-0" | 7'-0" | 1-3/4' | wd | 4 | stn | GL-1 | | wd | | pnt | 6/A-60 | 4 7/8" | SET C | |

| | WINDOW SCHEDULE | | | | | | | | | | | |
|------|-----------------|----------|-------|--------|------------|--------|-----------------------------|----------|--|--|--|--|
| MARK | MAT | SIZE | | | OPERATION | GLASS/ | FRAME | REMARKS | | | | |
| MAKK | MVAI | W | Н | SILL | OI EKATION | PANEL | ANCHORAGE | KEIWAKKS | | | | |
| Α | wd/alum | 2'-8" | 2'-4" | ±5′-7" | fixed | | 3/A-50 | | | | | |
| В | wd | Existing | | fixed | GL-1 | | Glaze exq, historic windows | | | | | |

GL-1

6/A-60

FULL SCALE
Basis of design, SAW 3380

FULL SCALE

Solve of design, SAW 3380


FULL SCALE


FULL SC


• Paint door and frames, ea side


• Protect exg doors, scheduled to remain, during construction


wd 2'-8" 4'-2" 2'-10"

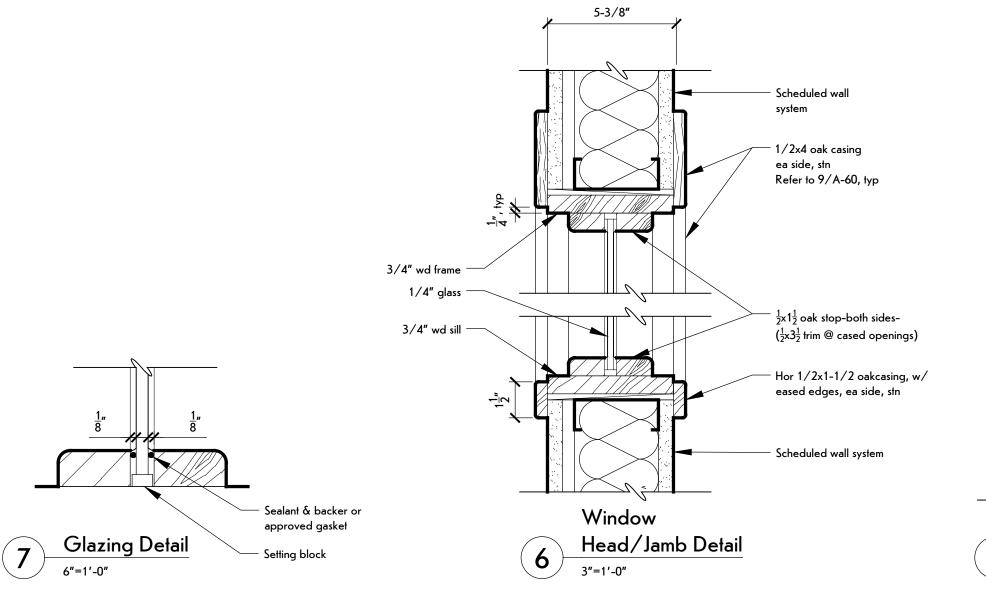

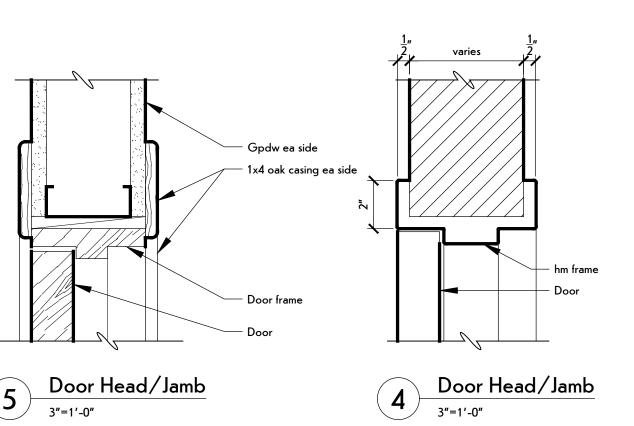

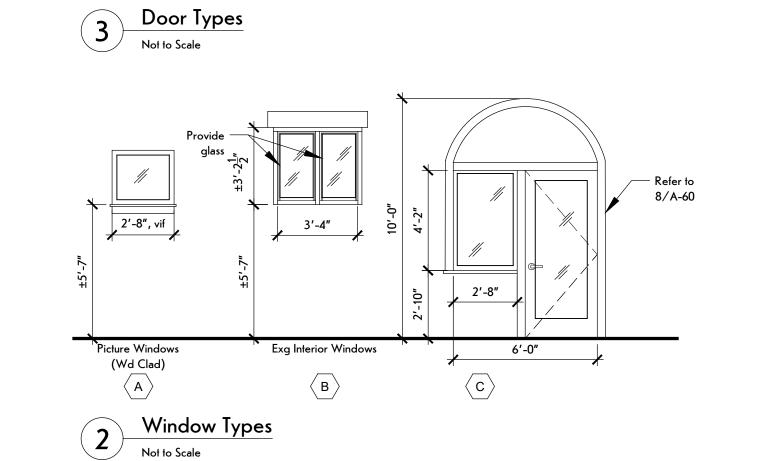

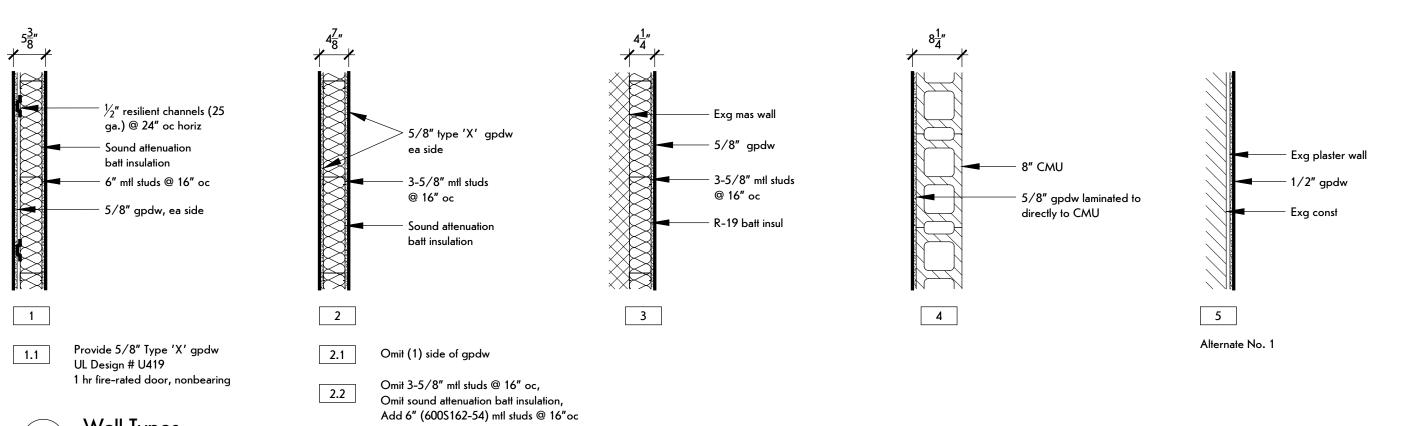

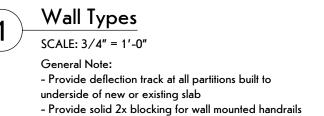





STRUCTURAL ENGINEER:



1653 East Main Street Rochester, NY 14609

MEP/FP ENGINEER:



315 Rockingham Street Rochester, NY 14620

WARNING:

DRAWINGS, SPECIFICATIONS AND OTHER
DOCUMENTS, INCLUDING THOSE IN ELECTRONIC
FORM, PREPARED BY BERO ARCHITECTURE PILL ARE
INSTRUMENTS OF SERVICE FOR USE SOLELY WITH
RESPECT TO THE PROJECT FOR WHICH THEY WERE
CREATED. THE ARCHITECT RETAINS ALL COMMON LAW,
STATUTORY AND OTHER RESERVED RIGHTS, INCLUDING
COPYRIGHT.

FOR ARCHITECTURAL DRAWINGS AND ELECTRONIC MEDIA, IT IS A VIOLATION OF TITLE VII, PART 69.5(B) OF THE NEW YORK STATE EDUCATION LAW FOR ANY PERSON, UNLESS ACTING UNDER THE DIRECTION OF A LICENSED ARCHITECT TO ALTER THIS DRAWING. IF ALTERED, SUCH ARCHITECT SHALL AFFIX THEIR SEAL, SIGNATURE, THE DATE, THE NOTATION "ALTERED BY", AND THE SPECIFIC DESCRIPTION OF THE ALTERATION.

WHERE DRAWINGS, ON PAPER OR ELECTRONIC MEDIA, SHOW EXISTING, NEW, AND/OR PROPOSED WORK AND CONDITIONS, IT IS UNDERSTOOD THAT IT IS SO SHOWN AS A MATTER OF INFORMATION AND THAT THE OWNER AND ARCHITECT, WHILE BELIEVING SUCH INFORMATION TO BE SUBSTANTIALLY CORRECT, ASSUME NO RESPONSIBILITY THEREFORE. THE USER SHALL MAKE THEMSELVES FAMILIAR WITH ALL CONDITIONS AFFECTING THE NATURE AND MANNER OF THEIR WORK INCLUDING VERIFICATION OF ALL DIMENSIONS LOCATING EXISTING, PROPOSED, AND/OR NEW WORK AND CONDITIONS.

| REV | ISIONS: | |
|-----|---------|-------------|
| # | Date | Description |
| | | |
| | | |
| | | |
| | | |

CLIENT / OWNER:



Town of Warsaw 83 Center Street Warsaw, NY 14569

PROJECT INFORMATION:

Expansion and Renovation Warsaw Public Library 130 North Main Street, Warsaw, New Yorl

PROJECT NUMBER: 22121


ISSUE DATE: April 25, 2025


LMY / TTN

DRAWN BY: SHEET TITLE:

Schedules & Details

SHEET NUMBER:

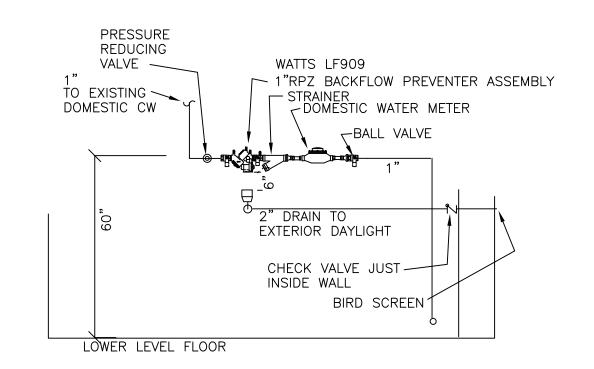

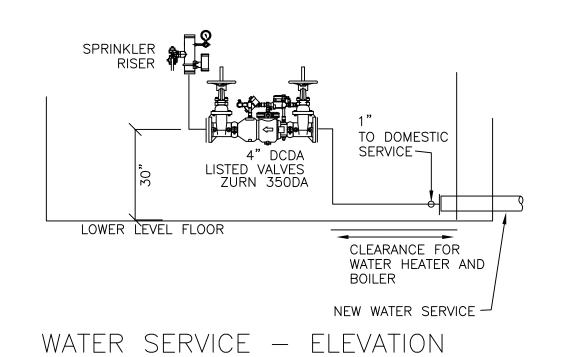

NOT TO SCALE COORDINATE WITH EXISTING CONDITIONS

REMOVALS - PLUMBING

- 1. COORDINATE REMOVALS WITH NEW WORK.
- 2. WHERE FIXTURES ARE SHOWN TO BE REMOVED COORDINATE TERMINATIONS OF EXISTING PIPING WITH NEW WORK. REMOVE BRANCH PIPING TO THE MAINS AND
- 3. PATCH SURFACES TO MATCH EXISTING.

COORDINATE WORK WITH OTHER TRADES.

FIELD MEASURE ALL WORK.

COMPLY WITH THE BUILD AMERICA BUY AMERICA ACT. REFER TO THE SPECIFICATIONS.

NOTES - PLUMBING

- 1. COORDINATE FIXTURES WITH THE ARCHITECTURAL PLANS. ACCESSIBLE FIXTURES TO COMPLY WITH ICC A117.1 STANDARDS. ACCESSIBLE SINKS - INSULATE OR PROTECT PIPING UNDER LAV PER A117.1.
- 2. PROVIDE ALL PIPING INCLUDING CONNECTIONS TO EQUIPMENT AND FIXTURES. INSTALL PIPING CONCEALED WHERE EVER POSSIBLE.
- 3. PROVIDE AND INSTALL MATERIALS IN ACCORDANCE WITH THE PLUMBING CODE.
- 4. INSULATE ALL NEW DOMESTIC COLD WATER AND HOT WATER PIPING.
- 5. PROVIDE COMPLETE SYSTEM IN ACCORDANCE WITH STATE AND LOCAL CODES. PAY ALL ASSOCIATED FEES AND OBTAIN ALL REQUIRED INSPECTIONS.
- 6. PROVIDE FIRE-STOPPING AT PIPE PENETRATION OF THE BOILER ROOM WALLS.
- 7. PROVIDE PLUMBING FOR FIXTURES. PROVIDE STOP VALVES FOR WATER CONNECTIONS.

PROVIDE 4" WATER SERVICE CONNECTION TO THE NEW 4" WATER SERVICE 5 FEET OUTSIDE OF BUILDING LINE (PROVIDE PIPE FROM 5 FEET OUTSIDE THE BUILDING TO INSIDE THE BUILDING). PROVIDE EXCAVATION AS REQUIRED, PIPE BEDDING, CORE DRILLED WALL PENETRATION, PENETRATION SEAL, BACKFILL. PIPE MATERIALS TO BE DIP. OFFSET PIPE JUST OUTSIDE THE EXTERIOR WALL FOR THE REQUIRED HEIGHT.

DISCONNECT THE EXISTING WATER SERVICE AND PROVIDE CONNECTION TO THE NEW WATER SERVICE. REMOVE THE EXISTING WATER SERVICE PIPE THROUGH THE EXTERIOR WALL AND PATCH AND SEAL WALL.

SYMBOLS - PLUMBING

MAIN LEVEL FLOOR PLAN 1/8" = 1'-0"

Non Fiction

103

Meefing Room

109

106

BALL VALVE


COLD WATER

HOT WATER SANITARY DRAINAGE (WASTE OR SOIL)


VENT

DECK PLATE CLEAN OUT (FLOOR)

CTE CONNECT TO EXISTING

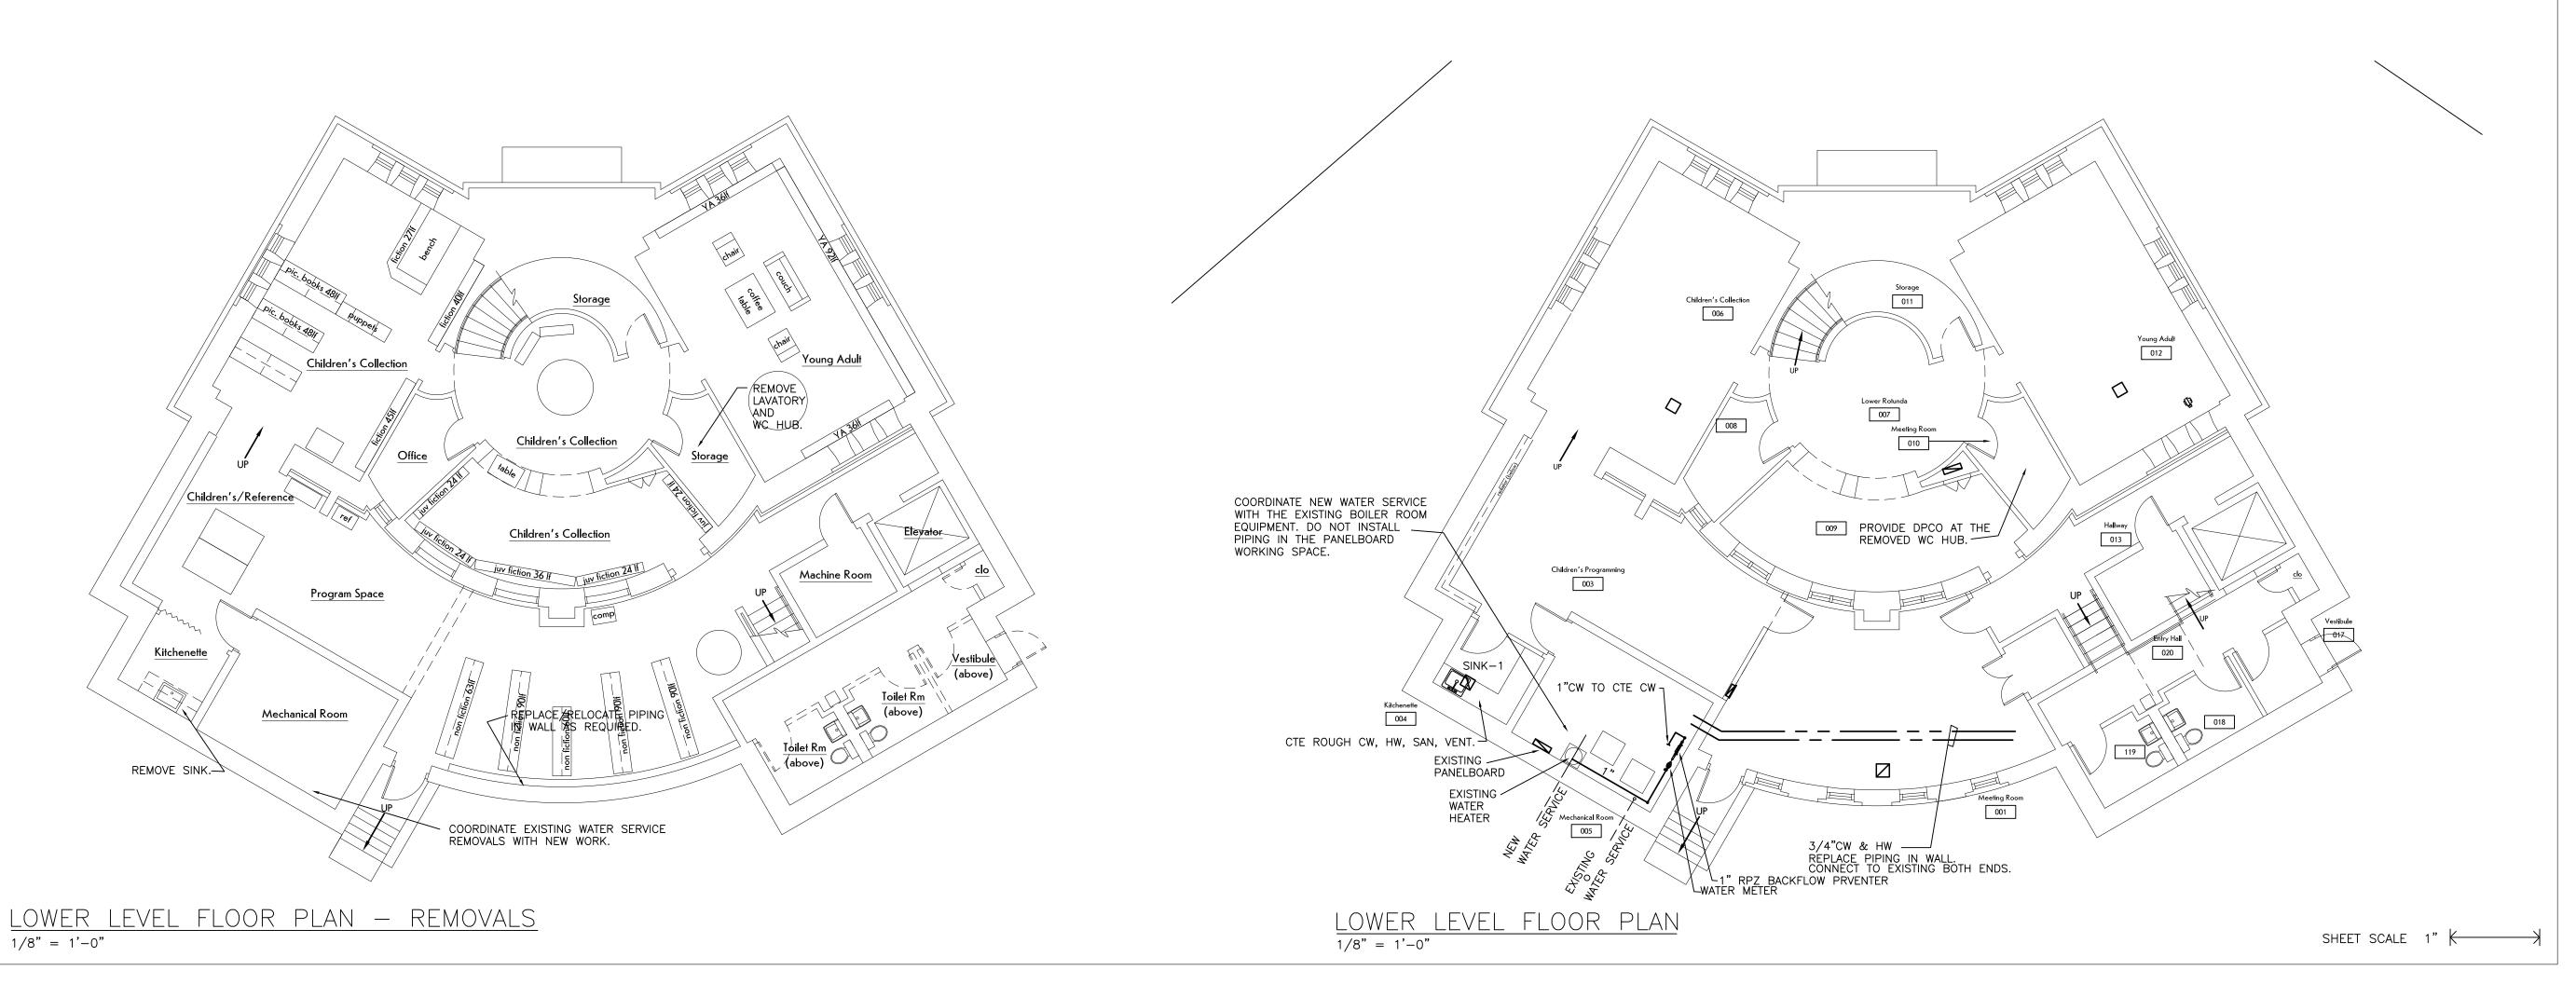



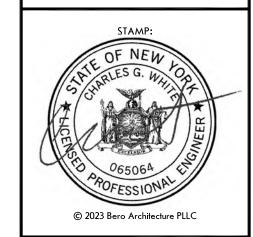

STRUCTURAL ENGINEER:



1653 East Main Street Rochester, NY 14609

MEP/FP ENGINEER:



315 Rockingham Street Rochester, NY 14620

DRAWINGS, SPECIFICATIONS AND OTHER DOCUMENTS, INCLUDING THOSE IN ELECTRONIC FORM, PREPARED BY BERO ARCHITECTURE PLLC ARE INSTRUMENTS OF SERVICE FOR USE SOLELY WITH RESPECT TO THE PROJECT FOR WHICH THEY WERE CREATED, THE ARCHITECT RETAINS ALL COMMON LAV COPYRIGHT.

FOR ARCHITECTURAL DRAWINGS AND ELECTRONIC MEDIA, IT IS A VIOLATION OF TITLE VII, PART 69.5(B) OF THE NEW YORK STATE EDUCATION LAW FOR ANY PERSON, UNLESS ACTING UNDER THE DIRECTION OF A LICENSED ARCHITECT TO ALTER THIS DRAWING. IF ALTERED, SUCH ARCHITECT SHALL AFFIX THEIR SEAL, SIGNATURE, THE DATE, THE NOTATION "ALTERED BY".

AND THE SPECIFIC DESCRIPTION OF THE ALTERATION. WHERE DRAWINGS, ON PAPER OR ELECTRONIC MEDIA, SHOW EXISTING, NEW, AND/OR PROPOSED WORK AND CONDITIONS, IT IS UNDERSTOOD THAT IT IS SO SHOWN AS A MATTER OF INFORMATION AND THAT THE OWNER AND ARCHITECT, WHILE BELIEVING SUCH INFORMATION TO BE SUBSTANTIALLY CORRECT INFORMATION TO BE SUBSTANTIALLY CORRECT,
ASSUME NO RESPONSIBILITY THEREFORE. THE USER
SHALL MAKE THEMSELVES FAMILIAR WITH ALL
CONDITIONS AFFECTING THE NATURE AND MANNER
OF THEIR WORK INCLUDING VERIFICATION OF ALL DIMENSIONS LOCATING EXISTING, PROPOSED, AND/OR NEW WORK AND CONDITIONS.

| I KL V | 1310143. | |
|--------|----------|-------------|
| # | Date | Description |
| | | |
| | | |
| | | |
| | | |
| CH | NFR: | |




Town of Warsaw 83 Center Street Warsaw, NY 14569

PROJECT INFORMATION:

Design Develpment Warsaw Public Library 130 North Main Street, Warsaw, New York

| | PROJECT NUMBER: | 22120 |
|---|-----------------|-----------|
| ١ | ISSUE DATE: | 4/25/2025 |
| | DRAWN BY: | CWE |

PLUMBING

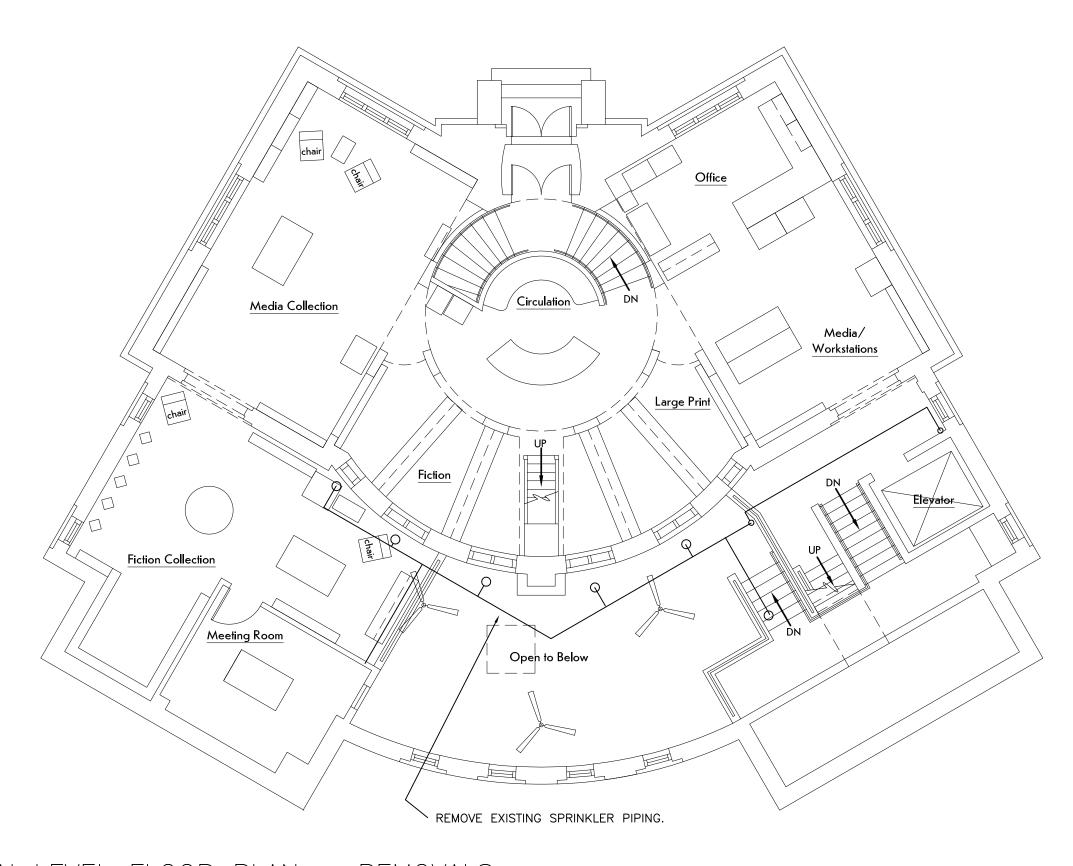

MAIN LEVEL FLOOR PLAN — REMOVALS

1/8" = 1'-0"

REMOVALS

REMOVE THE EXISTING SPRINKLER SYSTEM.

CLUDES:

CONNECTION TO THE EXISTING WATER SERVICE RISER AND ALARM VALVE

SPRINKLERS AND PIPING (EXISTING SYSTEM WAS INTENDED TO PROTECT THE OPENINGS BETWEEN THE EXISTING BUILDING AND THE 1988 ADDITION.)

TEST CONNECTION

FLOW TEST INFORMATION

STATIC PRESSURE 132 PSIG

REFER TO THE SITE PLANS.

RESIDUAL PRESSURE 115 PSIG

TO THE 4" MAIN IN E. COURT ST.

2380 GPM*

REPORT DATED 8-14-15, SUPPLIED BY VILLAGE OF

NOTE THAT THE NEW WATER SERVICE WILL BE CONNECTED

N. MAIN ST. E/S* N/O* GENESEE ST., 10" MAIN*

FIRE PROTECTION SPRINKLER

THE NEW SPRINKLER SYSTEM IS FOR THE ADDITION (ADDED FLOOR AREA) INCLUDING THE FLOOR AND EXITS.

THE EXISTING FLOOR AREA UNDER THE ADDITION WILL ALSO BE SPRINKLERED.

BID DRAWINGS ARE INTENDED TO SHOW THE GENERAL SCOPE OF WORK AND ANY SPECIFIC AESTHETIC REQUIREMENTS. THE CONTRACTOR SHALL PROVIDE A COMPLETE WORKING SYSTEM. THE CONTRACTOR SHALL BASE PIPE SIZES ON THE CONTRACTOR HYDRAULIC CALCULATIONS. THE CONTRACTOR SHALL BASE SPRINKLER LAYOUT ON THE ARCHITECTURAL AND STRUCTURAL BUILDING PLANS AND DETAILS. PROVIDE COMPLETE SYSTEMS PER NFPA 13 AND AS REQUIRED BY THE BUILDING CODE OF NEW YORK STATE.

SIZE THE PIPING AND SPRINKLERS AS REQUIRED BY THE AVAILABLE WATER PRESSURE AND FLOW.

LIGHT HAZARD (ANY BOOK SHELVES </= 8FT, > 30" APART)


CONTRACTOR SHALL PREPARE SHOP DRAWINGS. DRAWINGS TO MEET NFPA 13 DEFINITION OF WORKING DRAWINGS FOR SUBMISSION TO THE AHJ.


THE CONTRACTOR SHALL PROVIDE ALL INFORMATION FOR THE PERMIT. CERTIFICATION (PE STAMP OR OTHERWISE) OF THE SHOP DRAWINGS AS REQUIRED BY THE AHJ SHALL BE THE RESPONSIBILITY OF THE CONTRACTOR.

- 1. PROVIDE COMPLETE HYDRAULICLY DESIGNED SYSTEM INCLUDING ALL ACCESSORIES REQUIRED BY NFPA 13.
- 2. COORDINATE WITH OTHER TRADES. PROVIDE PIPING AND SPRINKLERS TO AVOID BUILDING COMPONENTS. PROVIDE ADDITIONAL SPRINKLERS TO COVER AROUND OBSTRUCTIONS. REFER TO ALL THE BUILDING DRAWINGS.
- 3. PIPING SIZE TO BE 1" MINIMUM OR SAME AS PIPE DOWN—STREAM UNLESS OTHERWISE NOTED. PROVIDE 1" CONNECTIONS TO SPRINKLER HEADS (UNLESS OTHERWISE NOTED) INCLUDING SPRINKLER HEADS UNDER OBSTRUCTIONS.
- 4. ALL COMPONENTS SHALL BE LISTED.
- 5. PROVIDE FIRE—STOPPING AT PIPE PENETRATION OF FLOORS, MASONRY WALLS, DRYWALL CEILINGS, AND RATED WALLS AND PARTITIONS.
- 6. PROVIDE FLOW SWITCHES. PROVIDE TAMPER SWITCHES ON VALVES. PROVIDE AUDIO-VISUAL EXTERIOR ALARM.
- 7. PROVIDE DCDA BACKFLOW PREVENTER ASSEMBLY. COORDINATE THE WATER SERVICE.
- 8. PROVIDE MEANS FOR FORWARD TEST OF THE BACKFLOW PREVENTER SIZED FOR THE DESIGN FLOW. PROVIDE VALVE AND HOSE CONNECTION FOR THIS.
- 9. PROVIDE FIRE DEPARTMENT CONNECTION AS REQUIRED BY THE LOCAL FIRE DEPARTMENT. PROVIDE SIGN DESIGNATING THE AREA SERVED.

ALTERNATES

F2 PROVIDE SPRINKLERS IN CEILING CLOUDS (ALTERNATE CEILING OVER THE NEW CIRCULATION DESK).

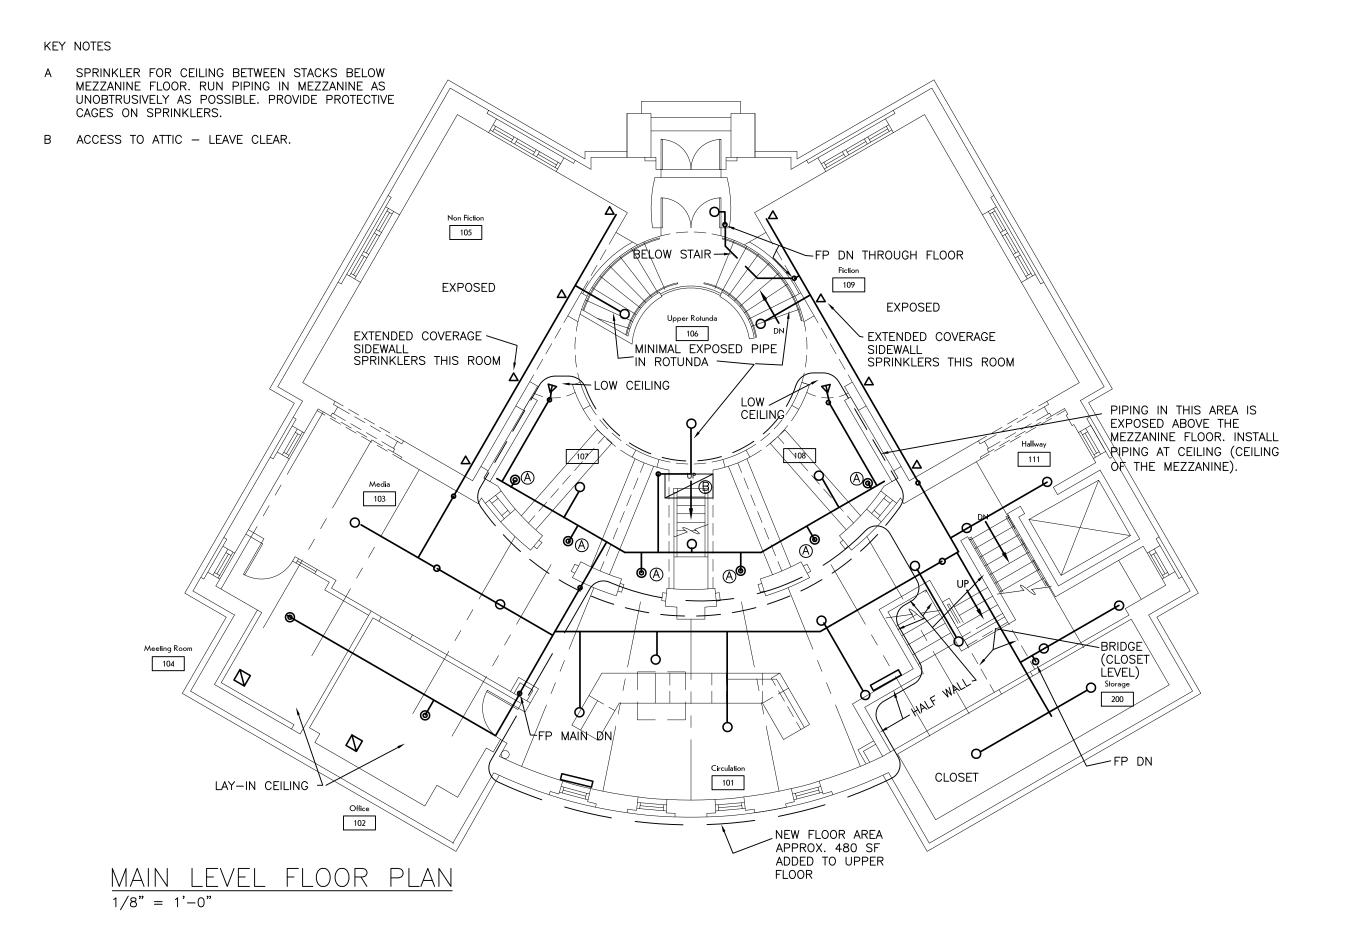

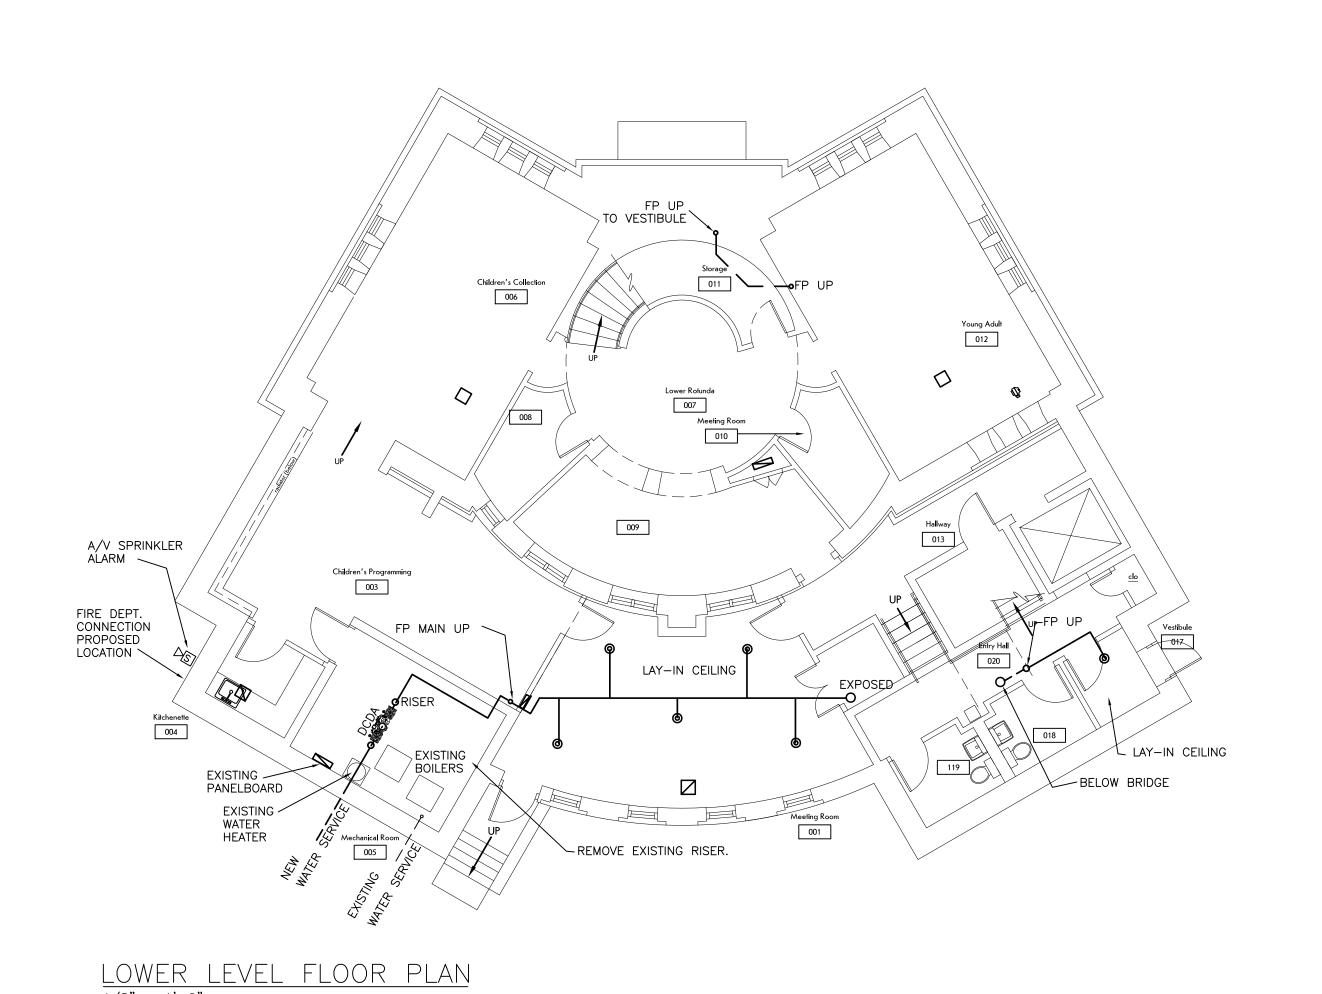






32 Winthrop Street, Rochester, NY 14607 (585) 262-2035 | www.beroarchitecture.com

STRUCTURAL ENGINEER:



Rochester, NY 14609

1653 East Main Street

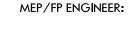



315 Rockingham Street Rochester, NY 14620

WARNING:

DRAWINGS, SPECIFICATIONS AND OTHER
DOCUMENTS, INCLUDING THOSE IN ELECTRONIC
FORM, PREPARED BY BERO ARCHITECTURE PLLC ARE
INSTRUMENTS OF SERVICE FOR USE SOLELY WITH
RESPECT TO THE PROJECT FOR WHICH THEY WERE
CREATED. THE ARCHITECT RETAINS ALL COMMON LAW,
STATUTORY AND OTHER RESERVED RIGHTS, INCLUDING

COPYRIGHT.

FOR ARCHITECTURAL DRAWINGS AND ELECTRONIC MEDIA, IT IS A VIOLATION OF TITLE VII, PART 69.5(B) OF THE NEW YORK STATE EDUCATION LAW FOR ANY PERSON, UNLESS ACTING UNDER THE DIRECTION OF A LICENSED ARCHITECT TO ALTER THIS DRAWING. IF ALTERED, SUCH ARCHITECT SHALL AFFIX THEIR SEAL, SIGNATURE, THE DATE, THE NOTATION "ALTERED BY",

AND THE SPECIFIC DESCRIPTION OF THE ALTERATION.

WHERE DRAWINGS, ON PAPER OR ELECTRONIC MEDIA, SHOW EXISTING, NEW, AND/OR PROPOSED WORK AND CONDITIONS, IT IS UNDERSTOOD THAT IT IS SO SHOWN AS A MATTER OF INFORMATION AND THAT THE OWNER AND ARCHITECT, WHILE BELIEVING SUCH INFORMATION TO BE SUBSTANTIALLY CORRECT, ASSUME NO RESPONSIBILITY THEREFORE. THE USER SHALL MAKE THEMSELVES FAMILIAR WITH ALL CONDITIONS AFFECTING THE NATURE AND MANNER OF THEIR WORK INCLUDING VERIFICATION OF ALL DIMENSIONS LOCATING EXISTING, PROPOSED, AND/OR NEW WORK AND CONDITIONS.

| REVISIONS: | | | | | | | | |
|------------|------|-------------|--|--|--|--|--|--|
| # | Date | Description | | | | | | |
| | | | | | | | | |
| | | | | | | | | |
| | | | | | | | | |
| | | | | | | | | |



Town of Warsaw 83 Center Street Warsaw, NY 14569

PROJECT INFORMATION:

CLIENT / OWNER:

Design Develpment Warsaw Public Library 130 North Main Street, Warsaw, New York


| PROJECT NUMBER: | 22120 |
|-----------------|-----------|
| ISSUE DATE: | 4/25/2025 |
| DRAWN BY: | CWE |

SHEET TITLE:
FIRE PROTECTION

SPRINKLER

SHEET NUMBER:

F-10

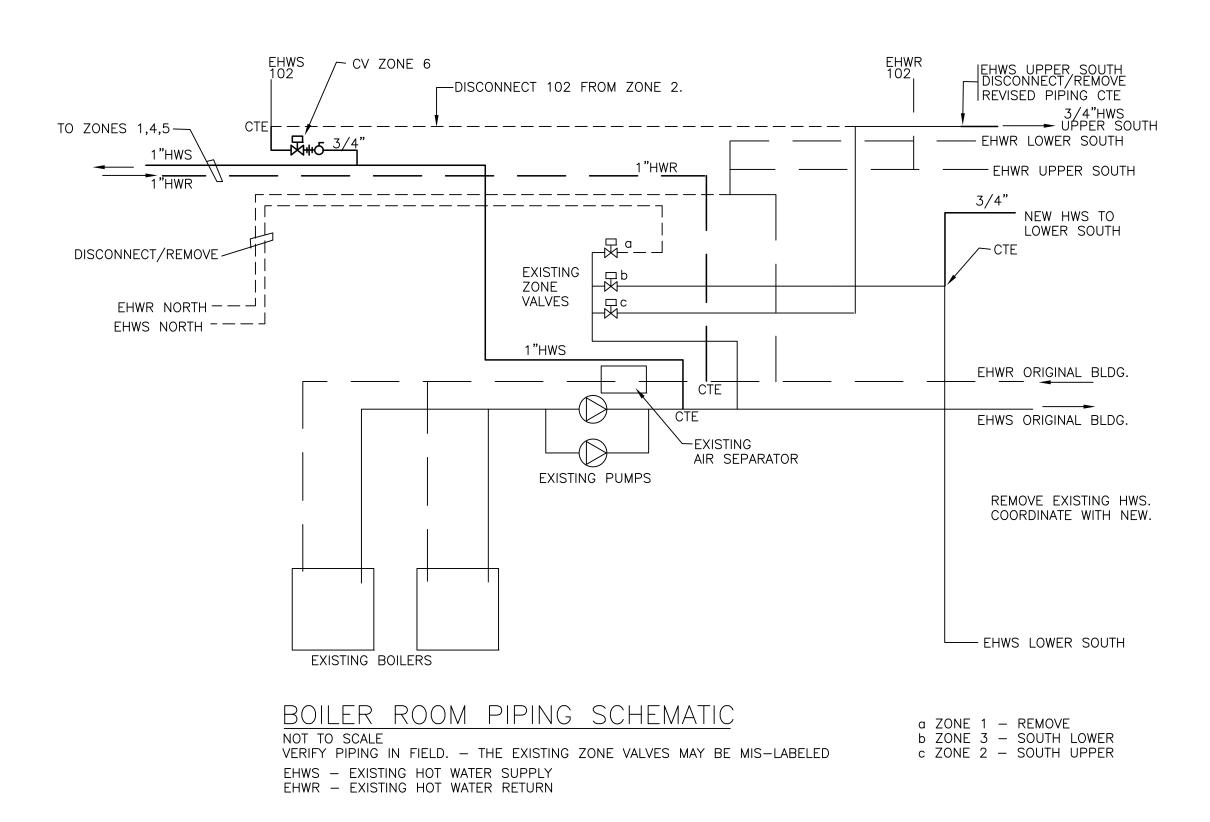

NOTES - HVAC

- INSULATE NEW SUPPLY AIR DUCT. EXCEPTION EXPOSED ROUND DUCT IN CONDITIONED SPACE. INSULATE NEW HEATING WATER PIPING. EXCEPTION EXPOSED PIPING IN FINISHED SPACES AND PIPING IN FINTUBE ENCLOSURES.
- BALANCE AIR SYSTEMS. BALANCE HVAC WATER SYSTEM. SUBMIT COPIES OF START UP AND BALANCE REPORTS TO THE OWNER.
- 3. PROVIDE OPERATION AND MAINTENANCE INFORMATION TO THE OWNER. PROVIDE AS-BUILT DOCUMENTATION TO THE OWNER.
- 4. PROVIDE AND INSTALL EQUIPMENT AND DUCT IN ACCORDANCE WITH NEW YORK STATE ENERGY CODE AND MECHANICAL CODE.
- 5. PROVIDE LISTED FIRE STOP SYSTEM AT PENETRATIONS OF RATED PARTITIONS AND CEILING ASSEMBLIES.
- 6. INSTALL ALL EQUIPMENT IN ACCORDANCE WITH THE MANUFACTURER'S INSTRUCTIONS.
- 7. PROVIDE OPERATING AND MAINTENANCE LABELS IN ACCORDANCE WITH THE ENERGY

DUCTWORK

DUCTWORK SHALL BE GALVANIZED STEEL CONSTRUCTED IN ACCORDANCE WITH SMACNA 2" PRESSURE CLASS AND C SEAL CLASS. IN ADDITION ALL SEAMS AND JOINTS SHALL BE SEALED IN ACCORDANCE WITH THE ENERGY CODE.

ROUND DUCT SHALL BE SPIRAL.

PROVIDE RADIUS DUCT ELBOWS. IF USED, PROVIDE TURNING VANES IN ALL MITERED ELBOWS (EXCEPTION — ELBOWS AT RETURN AND TRANSFER GRILLES). PROVIDE A VOLUME DAMPER IN EACH BRANCH TO DIFFUSERS (EXCEPT WHERE DAMPERS ARE SHOWN AT THE DIFFUSERS. ALL DUCT BRANCHES SHALL BE 45 DEG. TAP TYPE. BRANCHES TO DIFFUSERS AND GRILLES SHALL BE THE SIZE OF THE DIFFUSER NECK UNLESS OTHERWISE NOTED.

FLEX DUCT CONNECTIONS FOR CONNECTIONS TO DIFFUSERS IN SUSPENDED CEILINGS SHALL BE LINED & INSULATED AND MAXIMUM 6 FEET.

WHERE ACOUSTICAL INSULATION DUCT LINING IS USED, DIMENSIONS SHOWN ARE INSIDE NET CLEAR.

EXPOSED DUCT - PROVIDE GAVANEALED DUCT (DUCT TO BE PAINTED).

FIELD MEASURE DUCTWORK. COORDINATE DUCTWORK WITH OTHER TRADES PRIOR TO INSTALLATION. PROVIDE OFFSETS AND TRANSITIONS.

ALTERNATES

- M1 006 & 012 RENOVATION WORK:
 REMOVE EXISTING TRANSFER DUCTS, FANS, GRILLES AND DIFFUSERS.
 REPLACE BASEBOARD HEATERS. REVISE HEATER PIPING.
 006 ONLY PROVIDE TRANSFER FAN FOR 008.
 REMOVE EXISTING THERMOSTATS AND REINSTALL ON THE NEW WALL SURFACE.
 (NOTE THAT THE WORK ASSOCIATED WITH 010 IS IN THE BASE BID.)
- M4 006 & 012 WORK ASSOCIATED WITH PROVIDING DUCTED AIR FROM RTU-N TO 006 & 012.

COORDINATE WORK WITH OTHER TRADES.

FIELD MEASURE ALL WORK.

COMPLY WITH THE BUILD AMERICA BUY AMERICA ACT. REFER TO THE SPECIFICATIONS.

<u>SYMBOLS</u>

- FD FIRE DAMPER
- AD DUCT ACCESS DOOR
- └── VOLUME DAMPER
- 3 BALL VAL
- III UNION
- ⊗ BALANCE VALVE
- ⊠ CONTROL VALVE
- CV CONTROL VALVE
- BV BALANCE VALVE
- T THERMOSTAT
- CRD CEILING RADIATION DAMPER

 CHECK VALVE
- CTE CONNECT TO EXISTING
- FT FINTUBE
- BB BASEBOARD HEATER


THE EXISTING CONDITIONS SHOWN ARE BASED ON AS—BUILT DRAWINGS AND FIELD OBSERVATIONS. ACTUAL CONDITIONS MAY VARY. ACCOUNT FOR POSSIBLE VARIATIONS. NOTE EXSITING CONDITIONS DURING REMOVALS AND INCLUDE THE CONDITIONS ON THE FIELD AS—BUILT DRAWINGS.

PRIOR TO REMOVALS


1. TEST EXISTING THERMOSTATS. INCLUDING ALL HEATING THERMOSTATS AND BOTH ROOFTOP THERMOSTATS. REPORT RESULTS TO THE ENGINEER.

REMOVALS

- 1. COORDINATE REMOVALS WITH NEW WORK.
- 2. REMOVE EXISTING CONTROL DEVICES NOTED. REMOVE WIRING.
- 3. DISCONNECT AND REMOVE PIPING IN THE EAST EXTERIOR WALL (RADIUS WALL) WHERE REQUIRED FOR INSTALLATION OF WINDOWS. THIS PIPING WILL BE REPLACED. LOCATION CONNECTIONS AT EACH END DURING REMOVALS AND COORDINATE CONENCTIONS WITH NEW WORK.

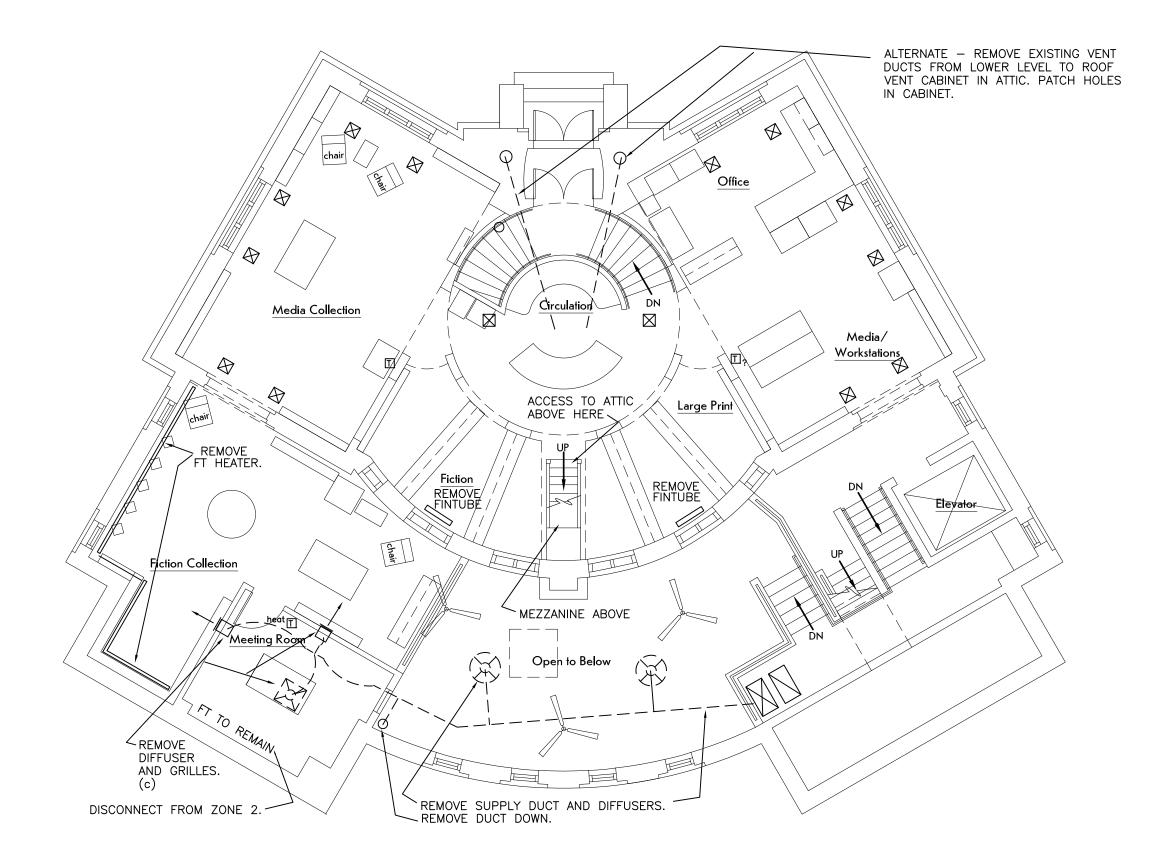


MAIN LEVEL FLOOR PLAN
1/8" = 1'-0"

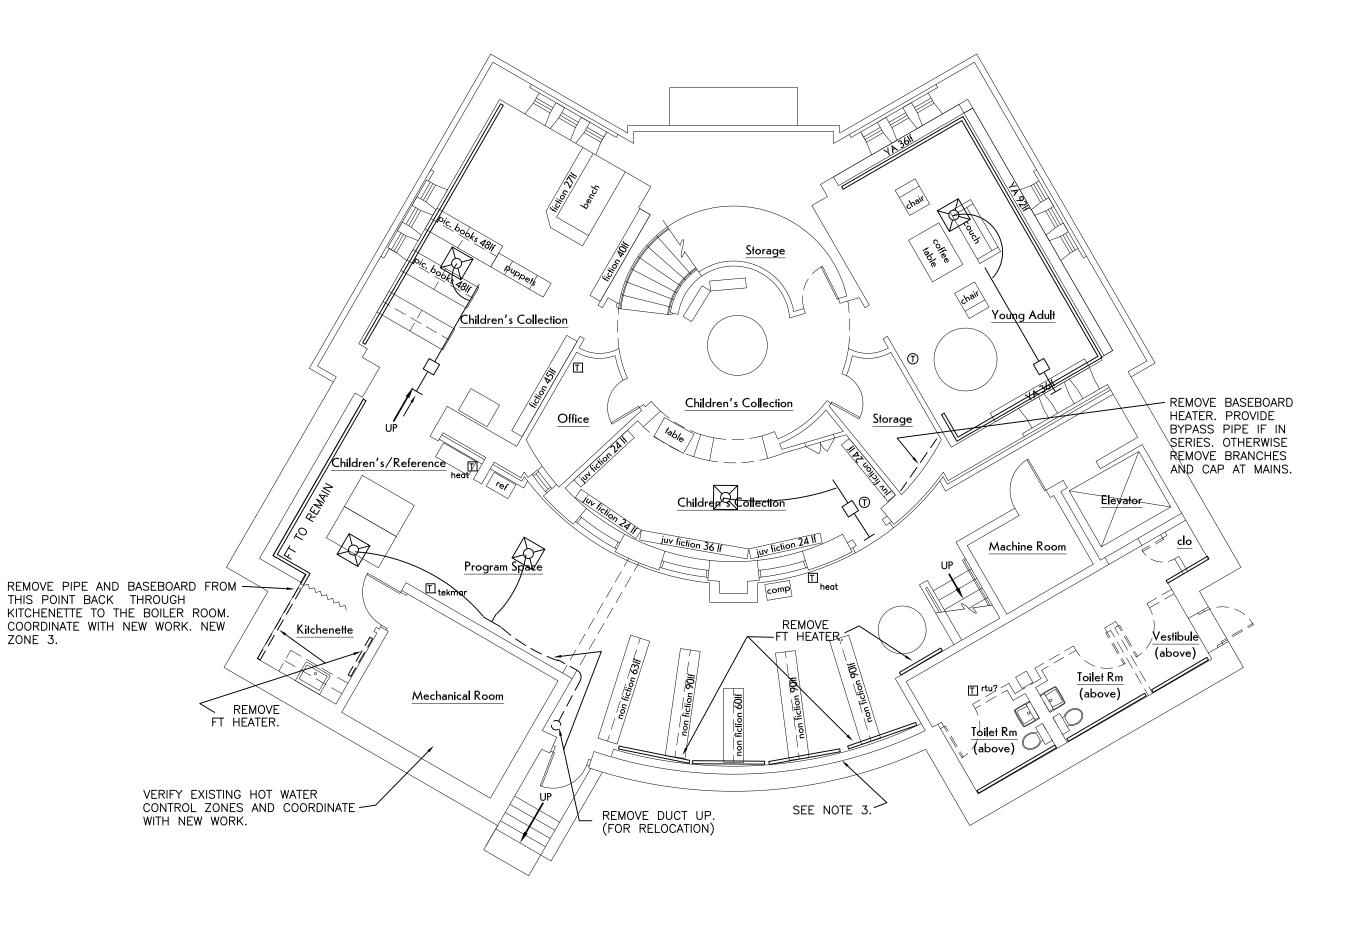

LOWER LEVEL FLOOR PLAN

1/8" = 1'-0"



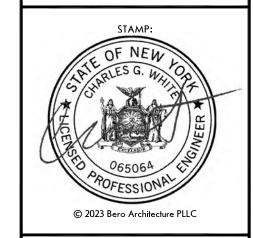

32 Winthrop Street, Rochester, NY 14607

(585) 262-2035 | www.beroarchitecture.com

STRUCTURAL ENGINEER:



1653 East Main Street Rochester, NY 14609

MEP/FP ENGINEER:



315 Rockingham Street Rochester, NY 14620

WARNING:

DRAWINGS, SPECIFICATIONS AND OTHER DOCUMENTS, INCLUDING THOSE IN ELECTRONIC FORM, PREPARED BY BERO ARCHITECTURE PLLC ARE INSTRUMENTS OF SERVICE FOR USE SOLELY WITH RESPECT TO THE PROJECT FOR WHICH THEY WERE CREATED, THE ARCHITECT RETAINS ALL COMMON LAW, STATUTORY AND OTHER RESERVED RIGHTS, INCLUDING

COPYRIGHT.

FOR ARCHITECTURAL DRAWINGS AND ELECTRONIC
MEDIA, IT IS A VIOLATION OF TITLE VII, PART 69.5(B) OF
THE NEW YORK STATE EDUCATION LAW FOR ANY
PERSON, UNLESS ACTING UNDER THE DIRECTION OF A
LICENSED ARCHITECT TO ALTER THIS DRAWING. IF
ALTERED, SUCH ARCHITECT SHALL AFFIX THEIR SEAL,
SIGNATURE, THE DATE, THE NOTATION "ALTERED BY",

AND THE SPECIFIC DESCRIPTION OF THE ALTERATION

WHERE DRAWINGS, ON PAPER OR ELECTRONIC

MEDIA, SHOW EXISTING, NEW, AND/OR PROPOSED

WORK AND CONDITIONS, IT IS UNDERSTOOD THAT IT IS

SO SHOWN AS A MATTER OF INFORMATION AND THAT

THE OWNER AND ARCHITECT, WHILE BELIEVING SUCH
INFORMATION TO BE SUBSTANTIALLY CORRECT,
ASSUME NO RESPONSIBILITY THEREFORE, THE USER

SHALL MAKE THEMSELVES FAMILIAR WITH ALL

CONDITIONS AFFECTING THE NATURE AND MANNER

OF THEIR WORK INCLUDING VERIFICATION OF ALL
DIMENSIONS LOCATING EXISTING, PROPOSED,
AND/OR NEW WORK AND CONDITIONS

REVISIONS:

Date Description



Town of Warsaw 83 Center Street Warsaw, NY 14569

PROJECT INFORMATION:


CLIENT / OWNER:

Design Develpment Warsaw Public Library 130 North Main Street, Warsaw, New York


PROJECT NUMBER: 22120
ISSUE DATE: 4/25/2025
DRAWN BY: CWE

REMOVALS

SHEET TITLE:

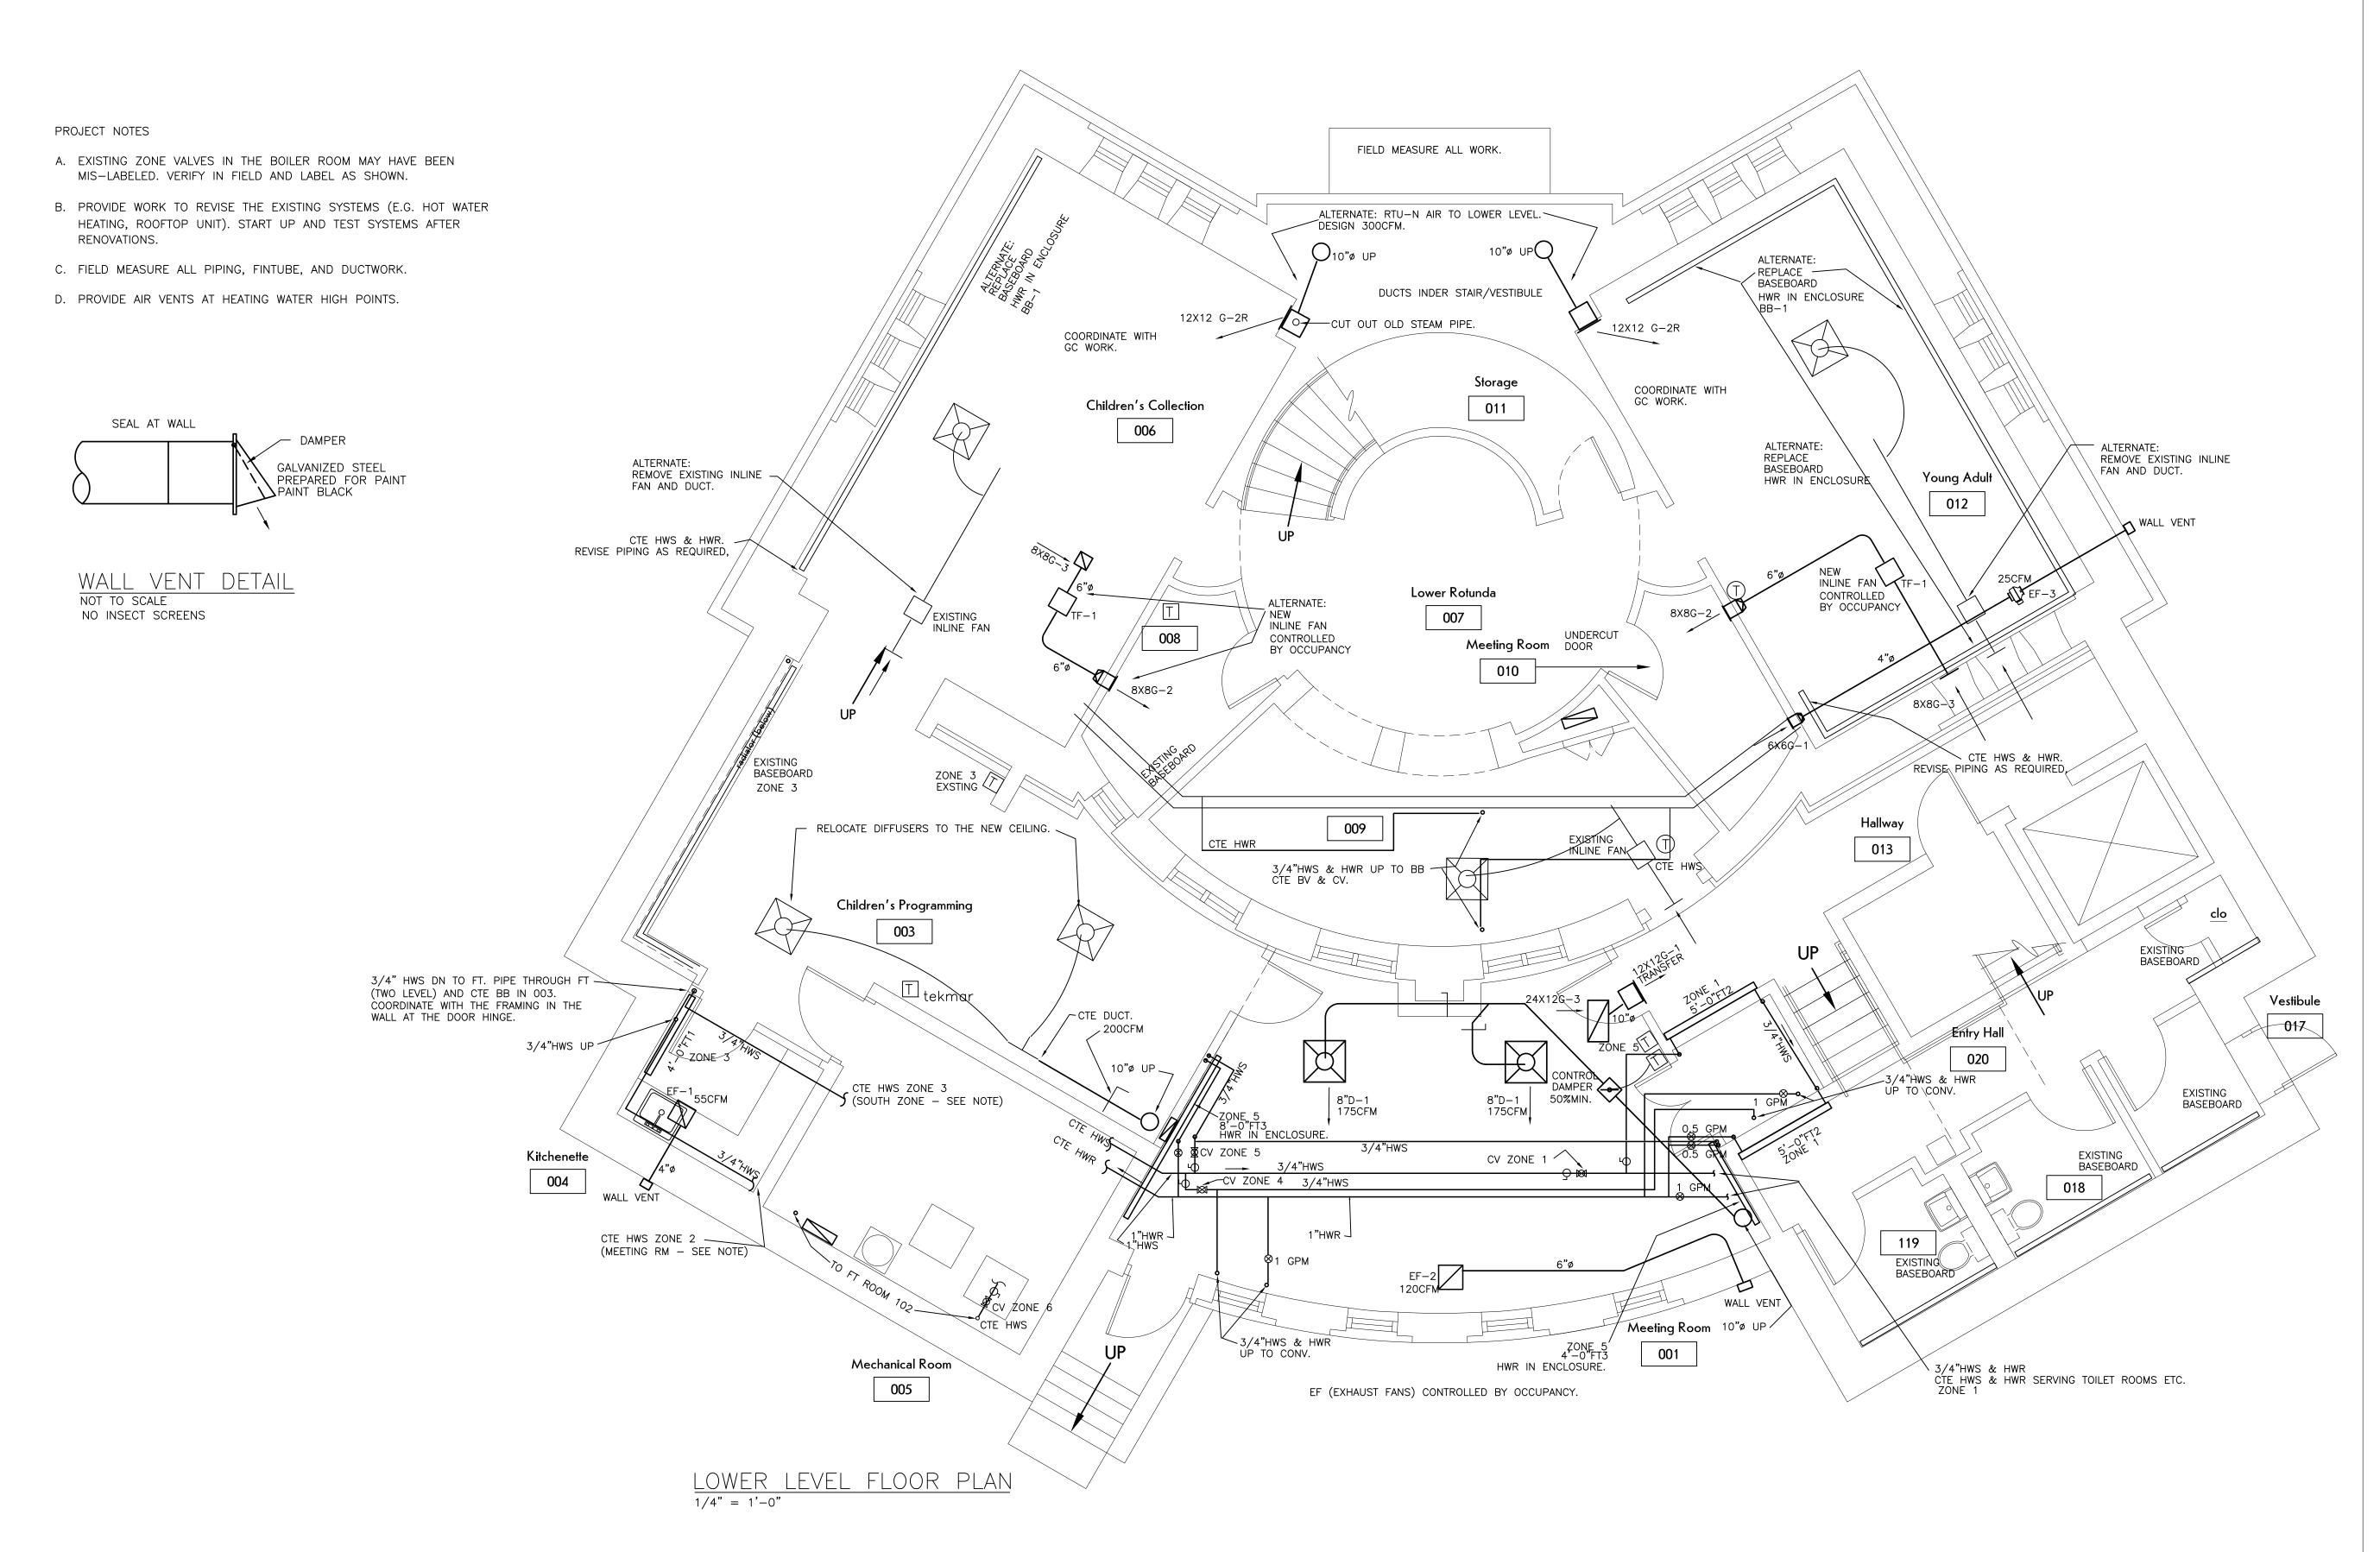



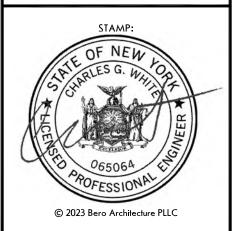

(585) 262-2035 | www.beroarchitecture.com

STRUCTURAL ENGINEER:



1653 East Main Street Rochester, NY 14609

MEP/FP ENGINEER:



315 Rockingham Street Rochester, NY 14620

DRAWINGS, SPECIFICATIONS AND OTHER DOCUMENTS, INCLUDING THOSE IN ELECTRONIC FORM, PREPARED BY BERO ARCHITECTURE PLLC ARE INSTRUMENTS OF SERVICE FOR USE SOLELY WITH RESPECT TO THE PROJECT FOR WHICH THEY WERE CREATED. THE ARCHITECT RETAINS ALL COMMON LAW STATUTORY AND OTHER RESERVED RIGHTS, INCLUDING COPYRIGHT.

FOR ARCHITECTURAL DRAWINGS AND ELECTRONIC MEDIA, IT IS A VIOLATION OF TITLE VII, PART 69.5(B) OF THE NEW YORK STATE EDUCATION LAW FOR ANY PERSON, UNLESS ACTING UNDER THE DIRECTION OF A LICENSED ARCHITECT TO ALTER THIS DRAWING. IF ALTERED, SUCH ARCHITECT SHALL AFFIX THEIR SEAL, SIGNATURE, THE DATE, THE NOTATION "ALTERED BY". AND THE SPECIFIC DESCRIPTION OF THE ALTERATION.

WHERE DRAWINGS, ON PAPER OR ELECTRONIC MEDIA, SHOW EXISTING, NEW, AND/OR PROPOSED WORK AND CONDITIONS, IT IS UNDERSTOOD THAT IT IS SO SHOWN AS A MATTER OF INFORMATION AND THAT THE OWNER AND ARCHITECT, WHILE BELIEVING SUCH INFORMATION TO BE SUBSTANTIALLY CORRECT, INFORMATION TO BE SUBSTANTIALLY CORRECT,
ASSUME NO RESPONSIBILITY THEREFORE. THE USER
SHALL MAKE THEMSELYES FAMILIAR WITH ALL
CONDITIONS AFFECTING THE NATURE AND MANNER
OF THEIR WORK INCLUDING VERIFICATION OF ALL
DIMENSIONS LOCATING EXISTING, PROPOSED,
AND/OR NEW WORK AND CONDITIONS.

| REVISIONS: | | |
|------------|------|-------------|
| # | Date | Description |
| | | |
| | | |
| | | |
| | | |



Town of Warsaw 83 Center Street Warsaw, NY 14569


PROJECT INFORMATION:

Design Develpment Warsaw Public Library 130 North Main Street, Warsaw, New York

PROJECT NUMBER: 22120 ISSUE DATE: 4/25/2025 DRAWN BY:

SHEET TITLE:

LOWER LEVEL

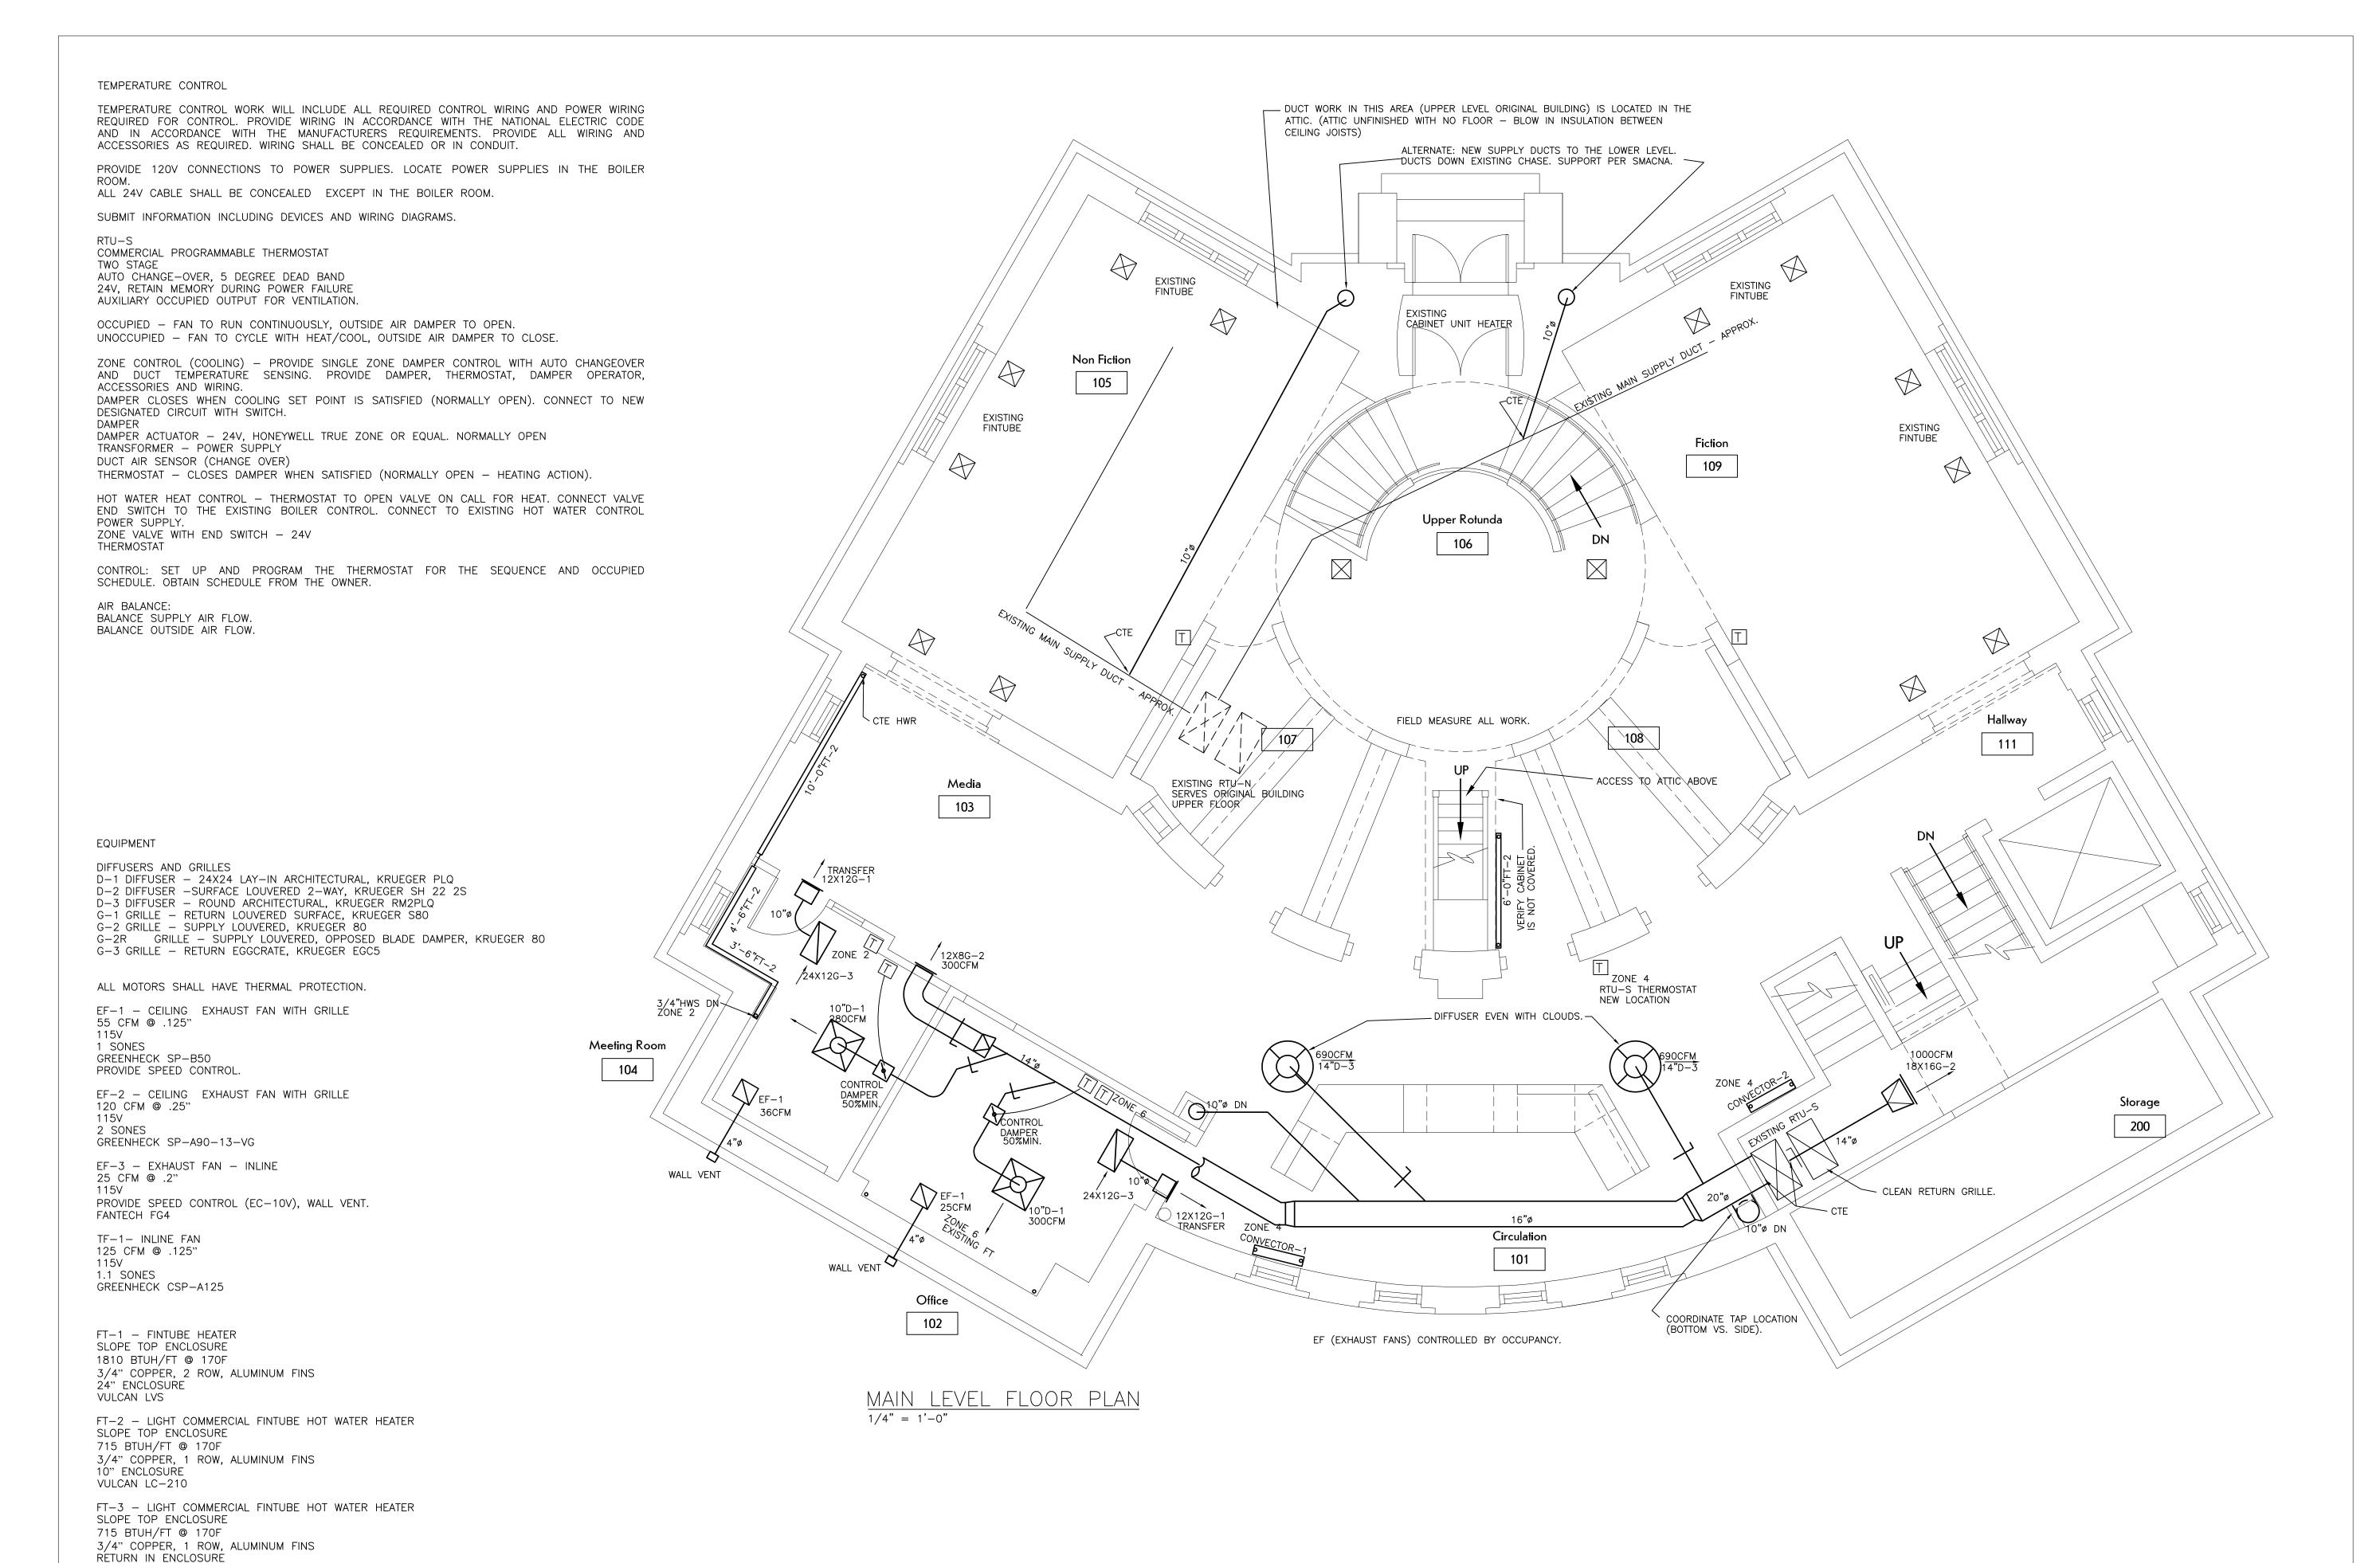

10" ENCLOSURE VULCAN LC-210

VULCAN 800

VULCAN SF-A

710 BTUH/FT @ 170F, 1GPM

3/4" COPPER, 1 ROW, ALUMINUM FINS

BB-1 - BASEBOARD FINTUBE HOT WATER HEATER

DEPTH X LENGTH X HEIGHT, 170 AWT, 65 EAT CONVECTOR-1 8X64X18H, 12,985 BTUH CONVECTOR-2 8X64X18H, 12,985 BTUH

CONVECTOR - HOT WATER FLOOR MOUNTED SLOPE TOP



STRUCTURAL ENGINEER:



1653 East Main Street Rochester, NY 14609

MEP/FP ENGINEER:



315 Rockingham Street Rochester, NY 14620

DRAWINGS, SPECIFICATIONS AND OTHER DOCUMENTS, INCLUDING THOSE IN ELECTRONIC FORM, PREPARED BY BERO ARCHITECTURE PLLC ARE INSTRUMENTS OF SERVICE FOR USE SOLELY WITH RESPECT TO THE PROJECT FOR WHICH THEY WERE CREATED, THE ARCHITECT RETAINS ALL COMMON LA' STATUTORY AND OTHER RESERVED RIGHTS, INCLUDING COPYRIGHT.

FOR ARCHITECTURAL DRAWINGS AND ELECTRONIC MEDIA, IT IS A VIOLATION OF TITLE VII, PART 69.5(B) OF THE NEW YORK STATE EDUCATION LAW FOR ANY PERSON, UNLESS ACTING UNDER THE DIRECTION OF A LICENSED ARCHITECT TO ALTER THIS DRAWING. IF ALTERED, SUCH ARCHITECT SHALL AFFIX THEIR SEAL, SIGNATURE, THE DATE, THE NOTATION "ALTERED BY".

AND THE SPECIFIC DESCRIPTION OF THE ALTERATION. WHERE DRAWINGS, ON PAPER OR ELECTRONIC MEDIA, SHOW EXISTING, NEW, AND/OR PROPOSED SO SHOWN AS A MATTER OF INFORMATION AND THAT INFORMATION TO BE SUBSTANTIALLY CORRECT. SHALL MAKE THEMSELVES FAMILIAR WITH ALL OF THEIR WORK INCLUDING VERIFICATION OF ALL AND/OR NEW WORK AND CONDITIONS.

| REVISIONS: | | |
|------------|------|-------------|
| # | Date | Description |
| | | |
| | | |
| | | |
| | | |



Town of Warsaw 83 Center Street Warsaw, NY 14569

PROJECT INFORMATION:

Design Develpment Warsaw Public Library 130 North Main Street, Warsaw, New York

PROJECT NUMBER: 22120 ISSUE DATE: 4/25/2025 DRAWN BY:

SHEET TITLE:

MAIN LEVEL

SYMBOLS - ELECTRICAL

- DUPLEX RECEPTACLE
- QUAD RECEPTACLE
- RECEPTACLE COUNTER (GFI IF NEAR SINK)
- RECEPTACLE TOILET ROOM (44", GFI)
- RECEPTACLE TAMPER RESISTANT
- RECEPTACLE SPECIAL
- TELEPHONE/DATA/CATV OUTLET
- HOME RUN CIRCUIT
- RECEPTACLE GROUND FAULT INTERRUPTING
- DISCONNECT (SAFETY SWITCH)
- \bowtie CONTROLLER
- SWITCH
- SWITCH 3 WAY (4 WAY)
- OCCUPANCY SENSOR (WALL SWITCH)
- VACANCY SENSOR (WALL SWITCH)
- SWITCH DIMMER
- OCCUPANCY SENSOR (CEILING)
- DAYLIGHT SENSOR (CEILING)
- OCCUPANCY SENSOR RELAY
- EXHAUST FAN
- NIGHT LIGHT
- EXIT SIGN
- EMERGENCY LIGHT PHOTOELECTRIC CONTROL
- EXISTING DEVICE

FIRE ALARM

- SMOKE DETECTOR
- HEAT DETECTOR
- FIRE ALARM PULL STATION
- F⊲ FIRE ALARM AUDIO/VISUAL
- E FIRE ALARM VISUAL (STROBE)
- FIRE ALARM CONTROL PANEL FIRE ALARM ANNUNCIATOR
- FIRE ALARM SPRINKLER FLOW SWITCH
- TS FIRE ALARM - VALVE TAMPER SWITCH
- CARBON MONOXIDE ALARM/DETECTOR
- DD DUCT SMOKE DETECTOR DEVICE ABOVE CEILING
- EXISTING DEVICE
- CARBON MONOXIDE VISUAL (STROBE)

NOTES - ELECTRICAL

- 1. CIRCUITS UNLESS OTHERWISE NOTED, PROVIDE 2 #12 AWG WITH #12 GROUND TO A 20A, 1P (POLE) CIRCUIT BREAKER.
- 2. PROVIDE COMPLETE CIRCUITS AS SHOWN OR AS NUMBERED.
- 3. COORDINATE RECEPTACLE AND SWITCH INSTALLATION HEIGHTS WITH CABINETS AND EQUIPMENT.
- 4. PROVIDE ELECTRIC DISCONNECTS AND SAFETY SWITCHES FOR EQUIPMENT (MECHANICAL,
- 5. INSTALL ALL CONDUIT CONCEALED (EXCEPTION MECHANICAL ROOMS). INSTALL ALL CABLE CONCEALED.
- 6. PROVIDE LISTED FIRE STOP SEALANT/SYSTEM AT CABLE AND CONDUIT PENETRATION OF RATED WALLS & PARTITIONS.
- 7. DO NOT COMBINE NEUTRALS.
- 8. MOUNT SWITCHES 44 INCHES ABOVE FLOOR, UNLESS OTHERWISE NOTED. MOUNT RECEPTACLES VERTICALLY AT 18 INCHES ABOVE FINISHED FLOOR, UNLESS OTHERWISE NOTED.
- 9. DATA OUTLET INSTALL OUTLET AT THE SAME HEIGHT AS ADJACENT RECEPTACLES. PROVIDE DEVICE WALL BOX WITH 1" CONDUIT TO ABOVE THE SUSPENDED CEILING (ABOVE OR BELOW).
- 10. COORDINATE TO CONCEAL WIRING. ANY EXPOSED WIRING SHALL BE INSTALLED NEATLY.
- 11. PROVIDE CONDUIT SIZES PER THE NATIONAL ELECTRIC CODE.

PROVIDE FISH WIRE AND BLANK WALL PLATE.

ALTERNATES

- E1 006 & 012 RENOVATION WORK:
- REPLACE LIGHT FIXTURES. REMOVE DEVICES IN WALLS. EXTEND BOXES FOR THE NEW WALL FINISH AND REPLACE THE DEVICE.
- REMOVE EXISTING LIGHT FIXTURES. PROVIDE NEW LIGHT FIXTURES IN THE NEW CEILING.
- DISCONNECT EXISTING TRANSFER FAN. PROVIDE CONNECTION TO THE NEW TRANSFER FAN SERVING 008.
- 012 ONLY REMOVE EXISTING RECEPTACLES ON THE BASE INCLUDING SURFACE RACEWAY AND WIRING. PROVIDE NEW RECEPTACLES IN THE NEW BASE. INSTALL WIRING
- CONCEALED. CONNECT TO THE EXISTING CIRCUITS. (NOTE THAT THE CONNECTIONS FOR THE FANS SERVING 010 IS IN THE BASE BID.) PROVIDE ABOVE CEILING SMOKE DETECTORS. RELOCATE DETECTORS TO THE NEW CEILING.
- E2 101 ALTERNATE LIGHT FIXTURES (CLOUD CEILING)

COORDINATE WORK WITH OTHER TRADES.


FIELD MEASURE ALL WORK.

COMPLY WITH THE BUILD AMERICA BUY AMERICA ACT. REFER TO THE SPECIFICATIONS.

THE EXISTING CONDITIONS SHOWN ARE BASED ON ORIGINAL DRAWINGS AND FIELD OBSERVATIONS. ACTUAL CONDITIONS MAY VARY. ACCOUNT FOR POSSIBLE VARIATIONS. NOTE EXSITING CONDITIONS DURING REMOVALS AND INCLUDE THE CONDITIONS ON THE FIELD AS-BUILT DRAWINGS.

REMOVALS


- "REMOVE" TO INCLUDE DISCONNECT AND REMOVE THE DEVICE AND EXISTING
- "DISCONNECT" TO INCLUDE DISCONNECT AND REMOVE EXISTING CIRCUIT. "CIRCUIT" INCLUDES BUT NOT LIMITED TO WIRE AND CONDUIT. "WIRING" INCLUDES BUT NOT LIMITED TO WIRE, CONDUIT, DEVICES, ACCESSORIES.
- "RELOCATE" TO INCLUDE EXTEND EXISTING CIRCUIT TO THE NEW LOCATION. 1. WALL REMOVAL - REMOVE WIRING IN AND ON EXISTING WALLS WHICH WILL BE DEMOLISHED. RELOCATE AND EXTEND ANY EXISTING CIRCUITS TO REMAIN.
- 2. AT REMOVALS, ON SURFACES TO REMAIN, REPAIR SURFACES TO MATCH THE ADJACENT SURFACE.

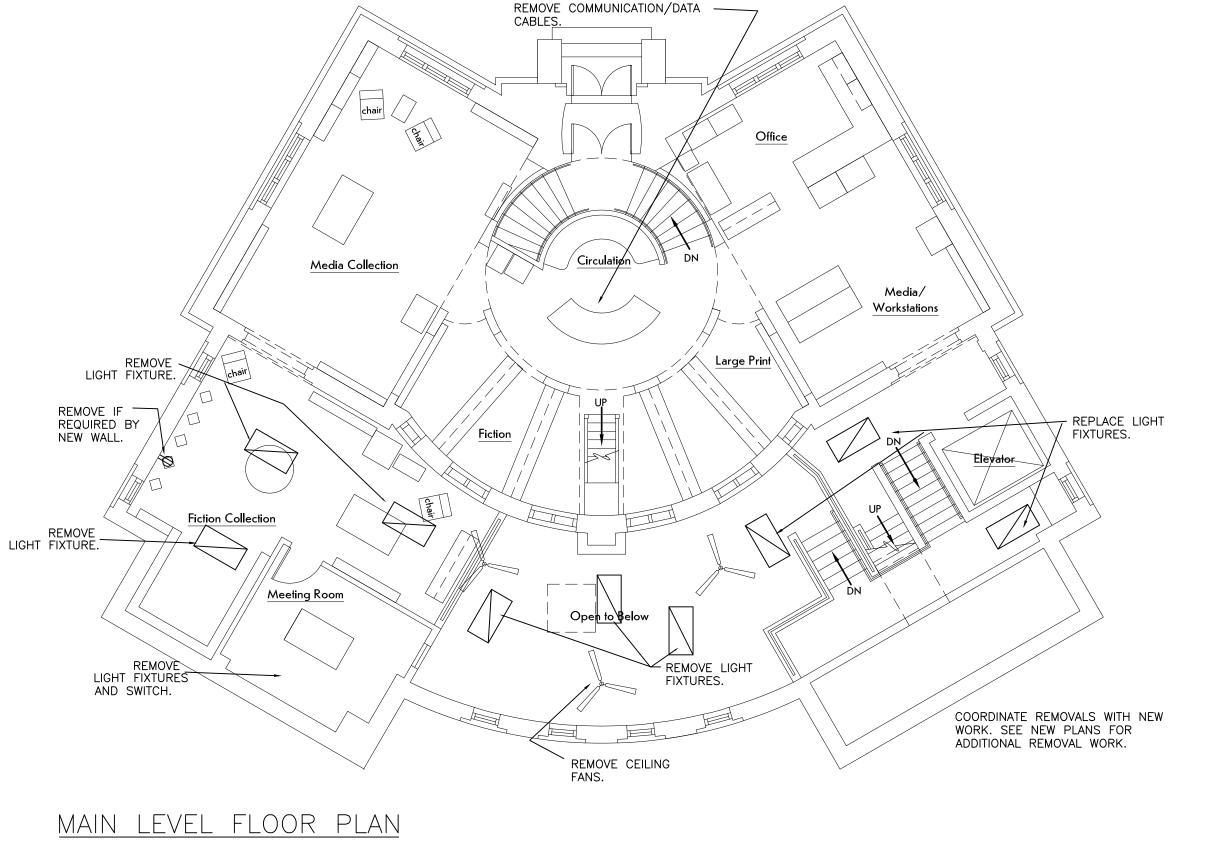

REMOVE DEVICES FROM EXISTING CIRCULATION DESKS. REMOVE WIRING.


MAIN LEVEL FLOOR PLAN

1/8" = 1'-0"

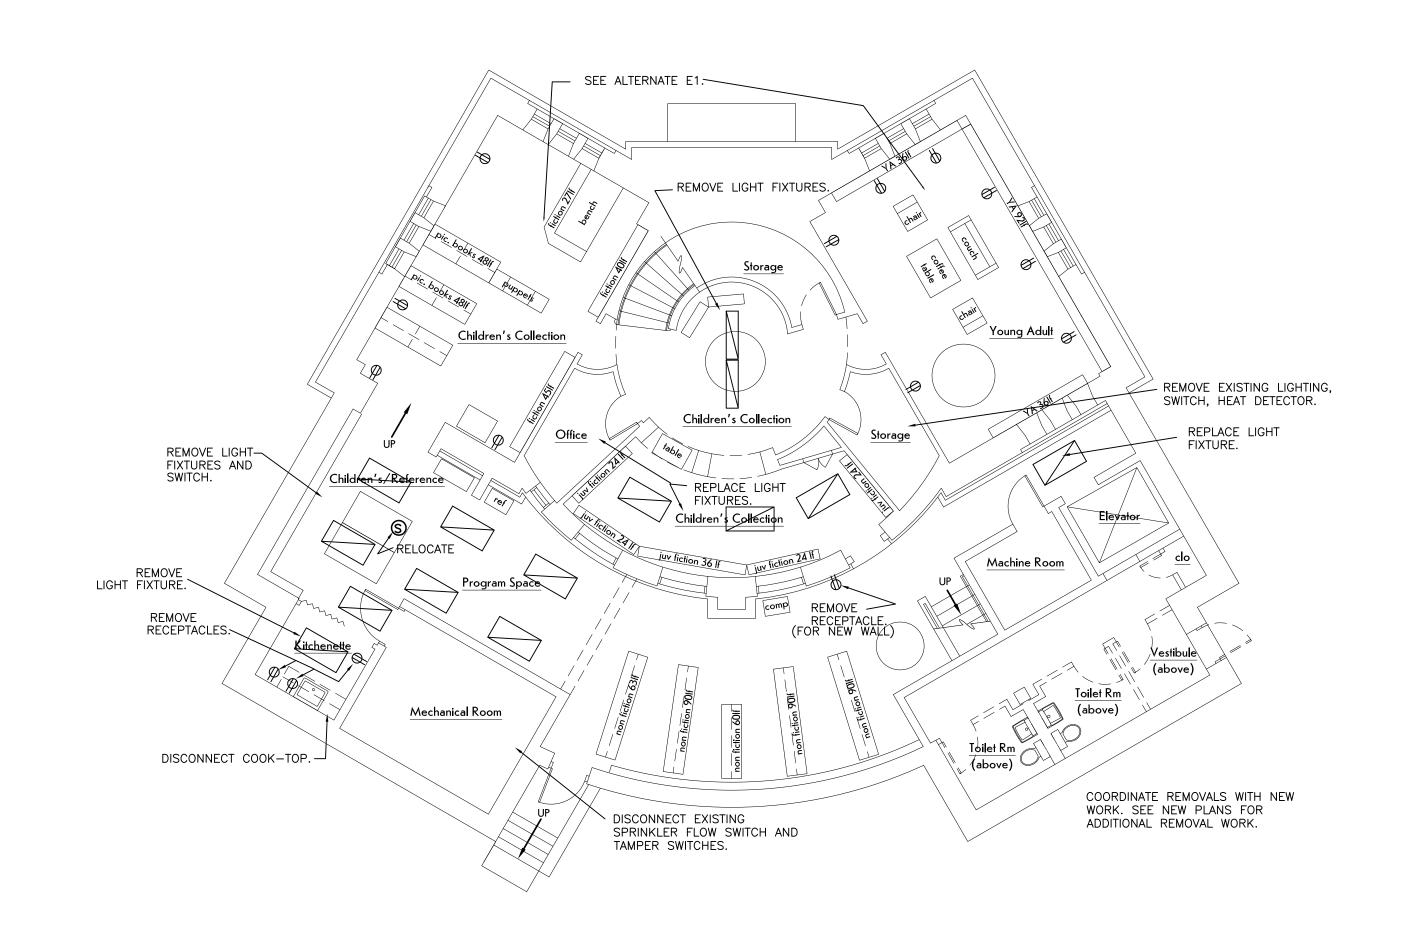

LOWER LEVEL FLOOR PLAN 1/8" = 1'-0"

32 Winthrop Street, Rochester, NY 14607

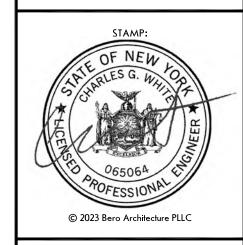


(585) 262-2035 | www.beroarchitecture.com

STRUCTURAL ENGINEER:



Rochester, NY 14609

1653 East Main Street

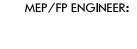



315 Rockingham Street Rochester, NY 14620

DRAWINGS, SPECIFICATIONS AND OTHER DOCUMENTS, INCLUDING THOSE IN ELECTRONIC FORM, PREPARED BY BERO ARCHITECTURE PLLC ARE INSTRUMENTS OF SERVICE FOR USE SOLELY WITH RESPECT TO THE PROJECT FOR WHICH THEY WERE CREATED, THE ARCHITECT RETAINS ALL COMMON LAY STATUTORY AND OTHER RESERVED RIGHTS, INCLUDING COPYRIGHT.

FOR ARCHITECTURAL DRAWINGS AND ELECTRONIC MEDIA, IT IS A VIOLATION OF TITLE VII, PART 69.5(B) OF THE NEW YORK STATE EDUCATION LAW FOR ANY PERSON, UNLESS ACTING UNDER THE DIRECTION OF A LICENSED ARCHITECT TO ALTER THIS DRAWING. IF ALTERED, SUCH ARCHITECT SHALL AFFIX THEIR SEAL,
SIGNATURE, THE DATE, THE NOTATION "ALTERED BY" AND THE SPECIFIC DESCRIPTION OF THE ALTERATION.

WHERE DRAWINGS, ON PAPER OR ELECTRONIC MFDIA. SHOW EXISTING, NEW, AND/OR PROPOSED WORK AND CONDITIONS, IT IS UNDERSTOOD THAT IT IS SO SHOWN AS A MATTER OF INFORMATION AND THAT INFORMATION TO BE SUBSTANTIALLY CORRECT ASSUME NO RESPONSIBILITY THEREFORE. THE USER
SHALL MAKE THEMSELVES FAMILIAR WITH ALL OF THEIR WORK INCLUDING VERIFICATION OF ALL AND/OR NEW WORK AND CONDITIONS.

REVISIONS: Date Description



Town of Warsaw 83 Center Street Warsaw, NY 14569

PROJECT INFORMATION:

Design Develpment Warsaw Public Library 130 North Main Street, Warsaw, New York


PROJECT NUMBER: 22120 ISSUE DATE: 4/25/2025 DRAWN BY:

REMOVALS

SHEET NUMBER:

SHEET SCALE 1" (

SHEET TITLE:

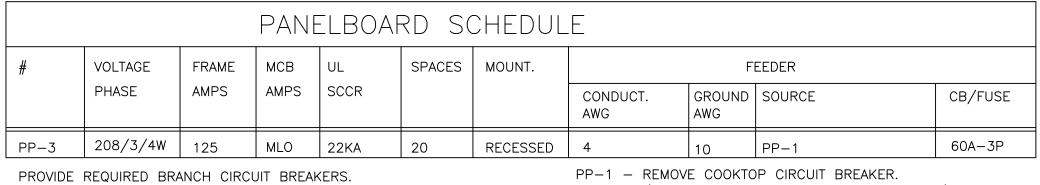

CONDUCTOR SIZES ARE FOR COPPER. PP-3: LOAD CENTER

RELOCATE/EXTEND AN ADJACENT CIRCUIT TO PP-3 (PROVIDE CIRCUT BREAKER). PROVIDE FEEDER CIRCUIT BREAKER IN PP-1.

FIRE ALARM SYSTEM

COORDINATE WITH EXISTING FIRE ALARM SYSTEM. CONTRACTOR TO DETERMINE IF THE EXISTING FIRE ALARM PANEL CAN BE EXPANDED. IF NOT, REPLACE THE PANEL. EXISTING PANEL - SIMPLEX 4007

PROVIDE DEVICES AS SHOWN. CONNECT TO THE BUILDING FIRE ALARM SYSTEM. PROVIDE WIRING AND ACCESSORIES REQUIRED.

REPLACE EXISTING ALARMS (AUDIBLE/VISUAL, VISUAL, AUDIBLE).

PROVIDE NAC EXTENDER POWER SUPPLY IF REQUIRED.

PROVIDE TESTING AND CERTIFICATION AS REQUIRED.

PROVIDE SHOP DRAWINGS THAT INCLUDE WIRING DIAGRAMS, MANUFACTURER'S MODEL NUMBERS AND LISTING INFORMATION, BATTERY CALCULATIONS, VOLTAGE DROP CALCULATIONS, AND CONDUCTOR TYPES

CONTRACTOR SHALL PROVIDE COMPLETE SYSTEM DOCUMENTATION AS REQUIRED BY THE AHJ. CERTIFICATION OF THE SHOP DRAWINGS SHALL BE THE RESPONSIBILITY OF THE CONTRACTOR

INSTALL DEVICES IN ACCORDANCE WITH ADA AND STATE ACCESSIBILITY CODES.

SPRINKLER ALARM

SPRINKLER ALARM - IN ADDITION TO THE FIRE ALARM SYSTEM PROVIDE A INDEPENDENT CIRCUIT FOR THE SPRINKLER FLOW ALARM. PROVIDE WIRING TO EACH FLOW SWITCH (INDEPENDENT OF THE FIRE ALARM MONITORING) AND TO THE EXTERIOR WALL MOUNTED AUDIO/VISUAL ALARM. AUDIO/VISUAL ALARM TO ACTIVE WHEN ANY BUILDING FLOW ALARM IS ACTIVATED. COORDINATE WITH THE SPRINKLER SYSTEM.

CARBON MONOXIDE DETECTION

PROVIDE CARBON MONOXIDE DETECTION AND NOTIFICATION IN ACCORDANCE WITH THE NY STATE FIRE CODE.

PROVIDE COMPLETE WORKING SYSTEM.

A. PROVIDE CONTROL PANEL WITH SILENCE FEATURE. B. PROVIDE ALL POWER CONNECTIONS AND BATTERY BACK-UP. . CO DETECTORS - UL 2075 WITH AUDIBLE NOTIFICATION.

D. PROVIDE VISUAL ALARM WITH AMBER LENS. MOUNT AT 84"AFF.

CONTRACTOR SHALL PROVIDE COMPLETE SYSTEM DOCUMENTATION AS REQUIRED BY THE TOWN. CERTIFICATION OF THE SHOP DRAWINGS SHALL BE THE RESPONSIBILITY OF THE

PROVIDE TESTING AND CERTIFICATION AS REQUIRED.

DEVICES MAY BE CONNECTED TO THE FIRE ALARM SYSTEM INSTEAD.


PROJECT NOTES

- A. PROVIDE RECEPTACLES IN CIRCULATION DESK. COORDINATE WITH THE DESK CONSTRUCTION. PROVIDE CONNECTION TO JUNCTION BOX BELOW FLOOR. PROVIDE DATA PATHWAY TO BELOW THE FLOOR.
- B. MEETING ROOMS PROVIDE RECEPTACLES IN ACCORDANCE WITH NFPA 70 210.71.
- C. RELOCATED AND EXTEND EXISTING CONDUIT AND WIRING NEAR FLOOR (DUE TO NEW WATER SERVICE).
- D. FOR CONNECTIONS TO EXISTING PANELBOARDS PROVIDE BRANCH CIRCUIT BREAKER. MATCH THE SCCR OF THE PANELBOARD.
- E. ALL WIRING UNERGROUND TO BE IN CONDUIT. UNDERGOUND CONDUIT TO BE NON-METALLIC.
- F. COORDINATE FLOOR CUTS FOR UNDERGROUND ELECTRIC.
- G. FLOOR OUTLET PROVIDE CIRCUIT WIRING IN CONDUIT UNDER SLAB TO WALL AND UP TO THE CEILING SPACE.
- H. ALL NEW RECEPTACLES SHALL BE TAMPER RESISTANT. EXCEPTION OFFICE & IN THE CIRCULATION DESK.

EQUIPMENT

FLOOR RECEPTCALE - RECESSED FLOOR OUTLET BOX FLUSH FLOOR WITH FLAP COVER BOX - INFLOOR NON-METALLIC PROVIDE DEPTH AS REQUIRED. COORDINATE WITH FLOOR FINISH. PROVIDE ACCESSORIES AND FLOOR TRIM. COVER AND TRIM MATERIAL — ALUMINUM STYLE LINE DECORATOR OPENING HUBBELL

TABLE TOP RECEPTACLES - HUBBELL 525 SERIES

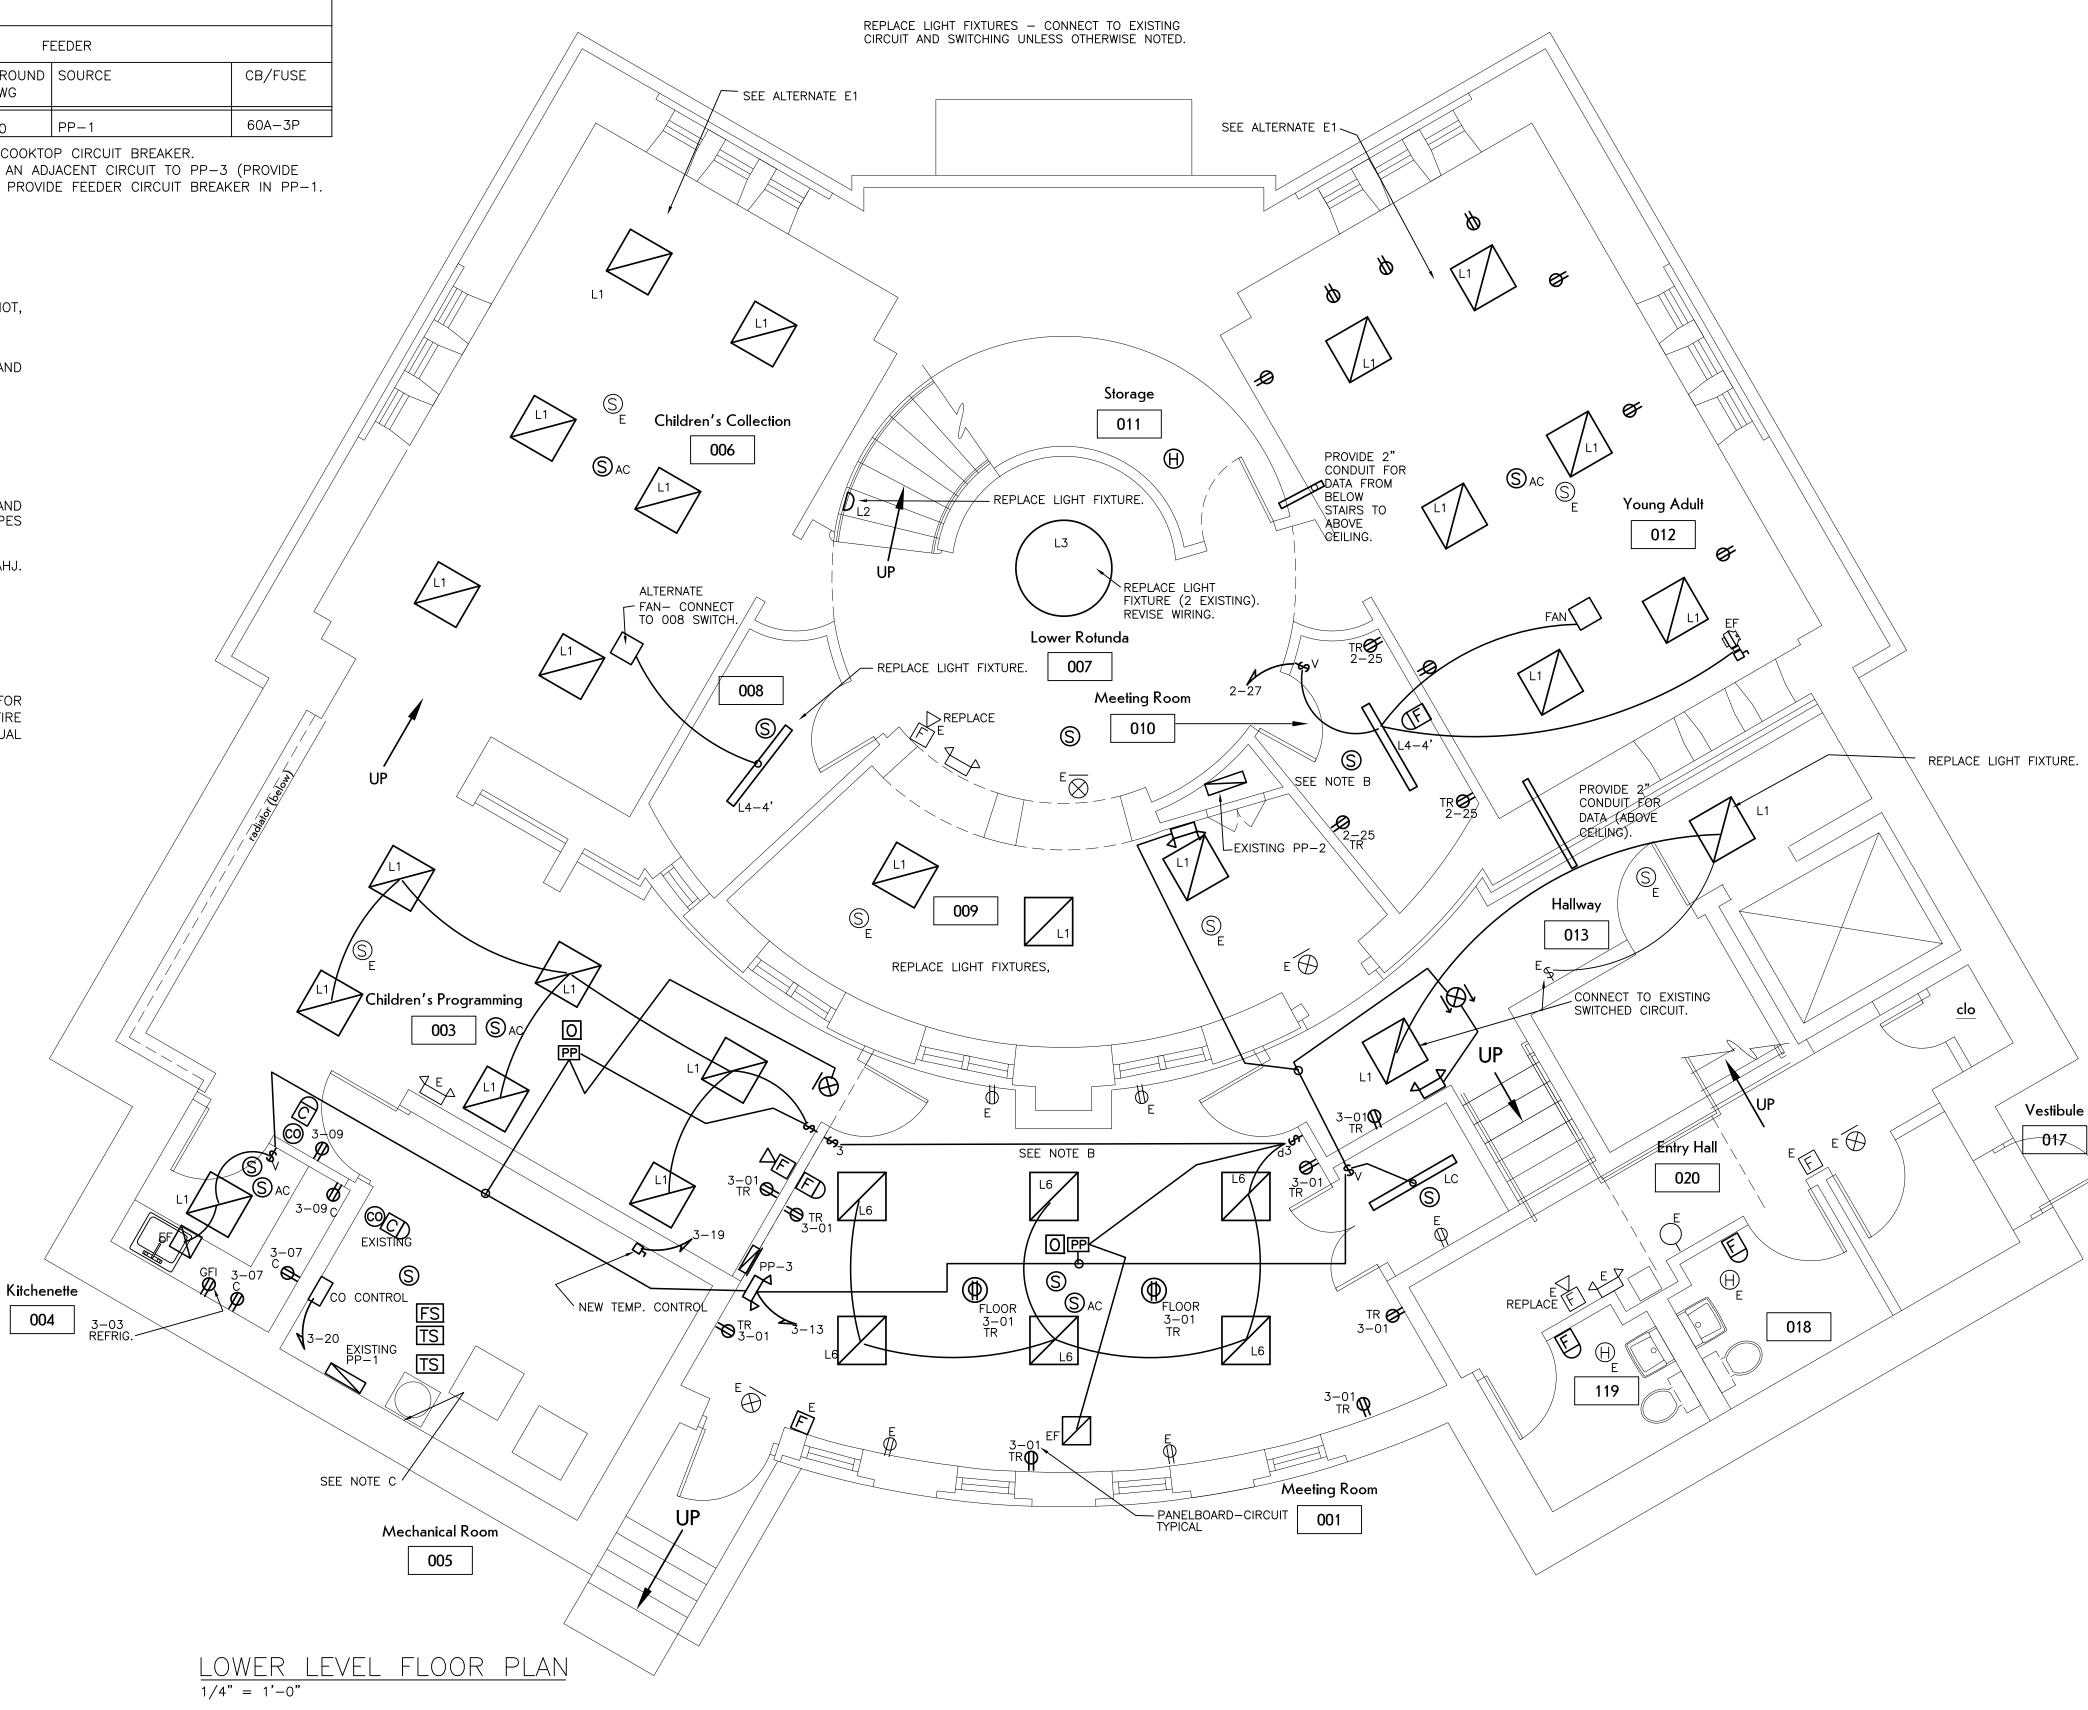





32 Winthrop Street, Rochester, NY 14607

STRUCTURAL ENGINEER:

© 2023 Bero Architecture PLLC



1653 East Main Street Rochester, NY 14609

MEP/FP ENGINEER:



315 Rockingham Street Rochester, NY 14620

DRAWINGS, SPECIFICATIONS AND OTHER

DOCUMENTS, INCLUDING THOSE IN ELECTRONIC FORM, PREPARED BY BERO ARCHITECTURE PLLC ARE INSTRUMENTS OF SERVICE FOR USE SOLELY WITH RESPECT TO THE PROJECT FOR WHICH THEY WERE CREATED, THE ARCHITECT RETAINS ALL COMMON LA' STATUTORY AND OTHER RESERVED RIGHTS, INCLUDING COPYRIGHT.

FOR ARCHITECTURAL DRAWINGS AND ELECTRONIC MEDIA, IT IS A VIOLATION OF TITLE VII, PART 69.5(B) OF THE NEW YORK STATE EDUCATION LAW FOR ANY PERSON, UNLESS ACTING UNDER THE DIRECTION OF A LICENSED ARCHITECT TO ALTER THIS DRAWING. IF ALTERED, SUCH ARCHITECT SHALL AFFIX THEIR SEAL,
SIGNATURE, THE DATE, THE NOTATION "ALTERED BY" AND THE SPECIFIC DESCRIPTION OF THE ALTERATION.

WHERE DRAWINGS, ON PAPER OR ELECTRONIC MEDIA, SHOW EXISTING, NEW, AND/OR PROPOSED WORK AND CONDITIONS, IT IS UNDERSTOOD THAT IT IS SO SHOWN AS A MATTER OF INFORMATION AND THAT INFORMATION TO BE SUBSTANTIALLY CORRECT SHALL MAKE THEMSELVES FAMILIAR WITH ALL OF THEIR WORK INCLUDING VERIFICATION OF ALL

AND/OR NEW WORK AND CONDITIONS.

| REVISIONS: | | |
|------------|------|-------------|
| # | Date | Description |
| | | |
| | | |
| | | |
| | | |



83 Center Street Warsaw, NY 14569


PROJECT INFORMATION:

Design Develpment Warsaw Public Library 130 North Main Street, Warsaw, New York

| PROJECT NUMBER: | 22120 |
|-----------------|-----------|
| ISSUE DATE: | 4/25/2025 |
| DRAWN BY: | CWE |

SHEET TITLE:

LOWER LEVEL

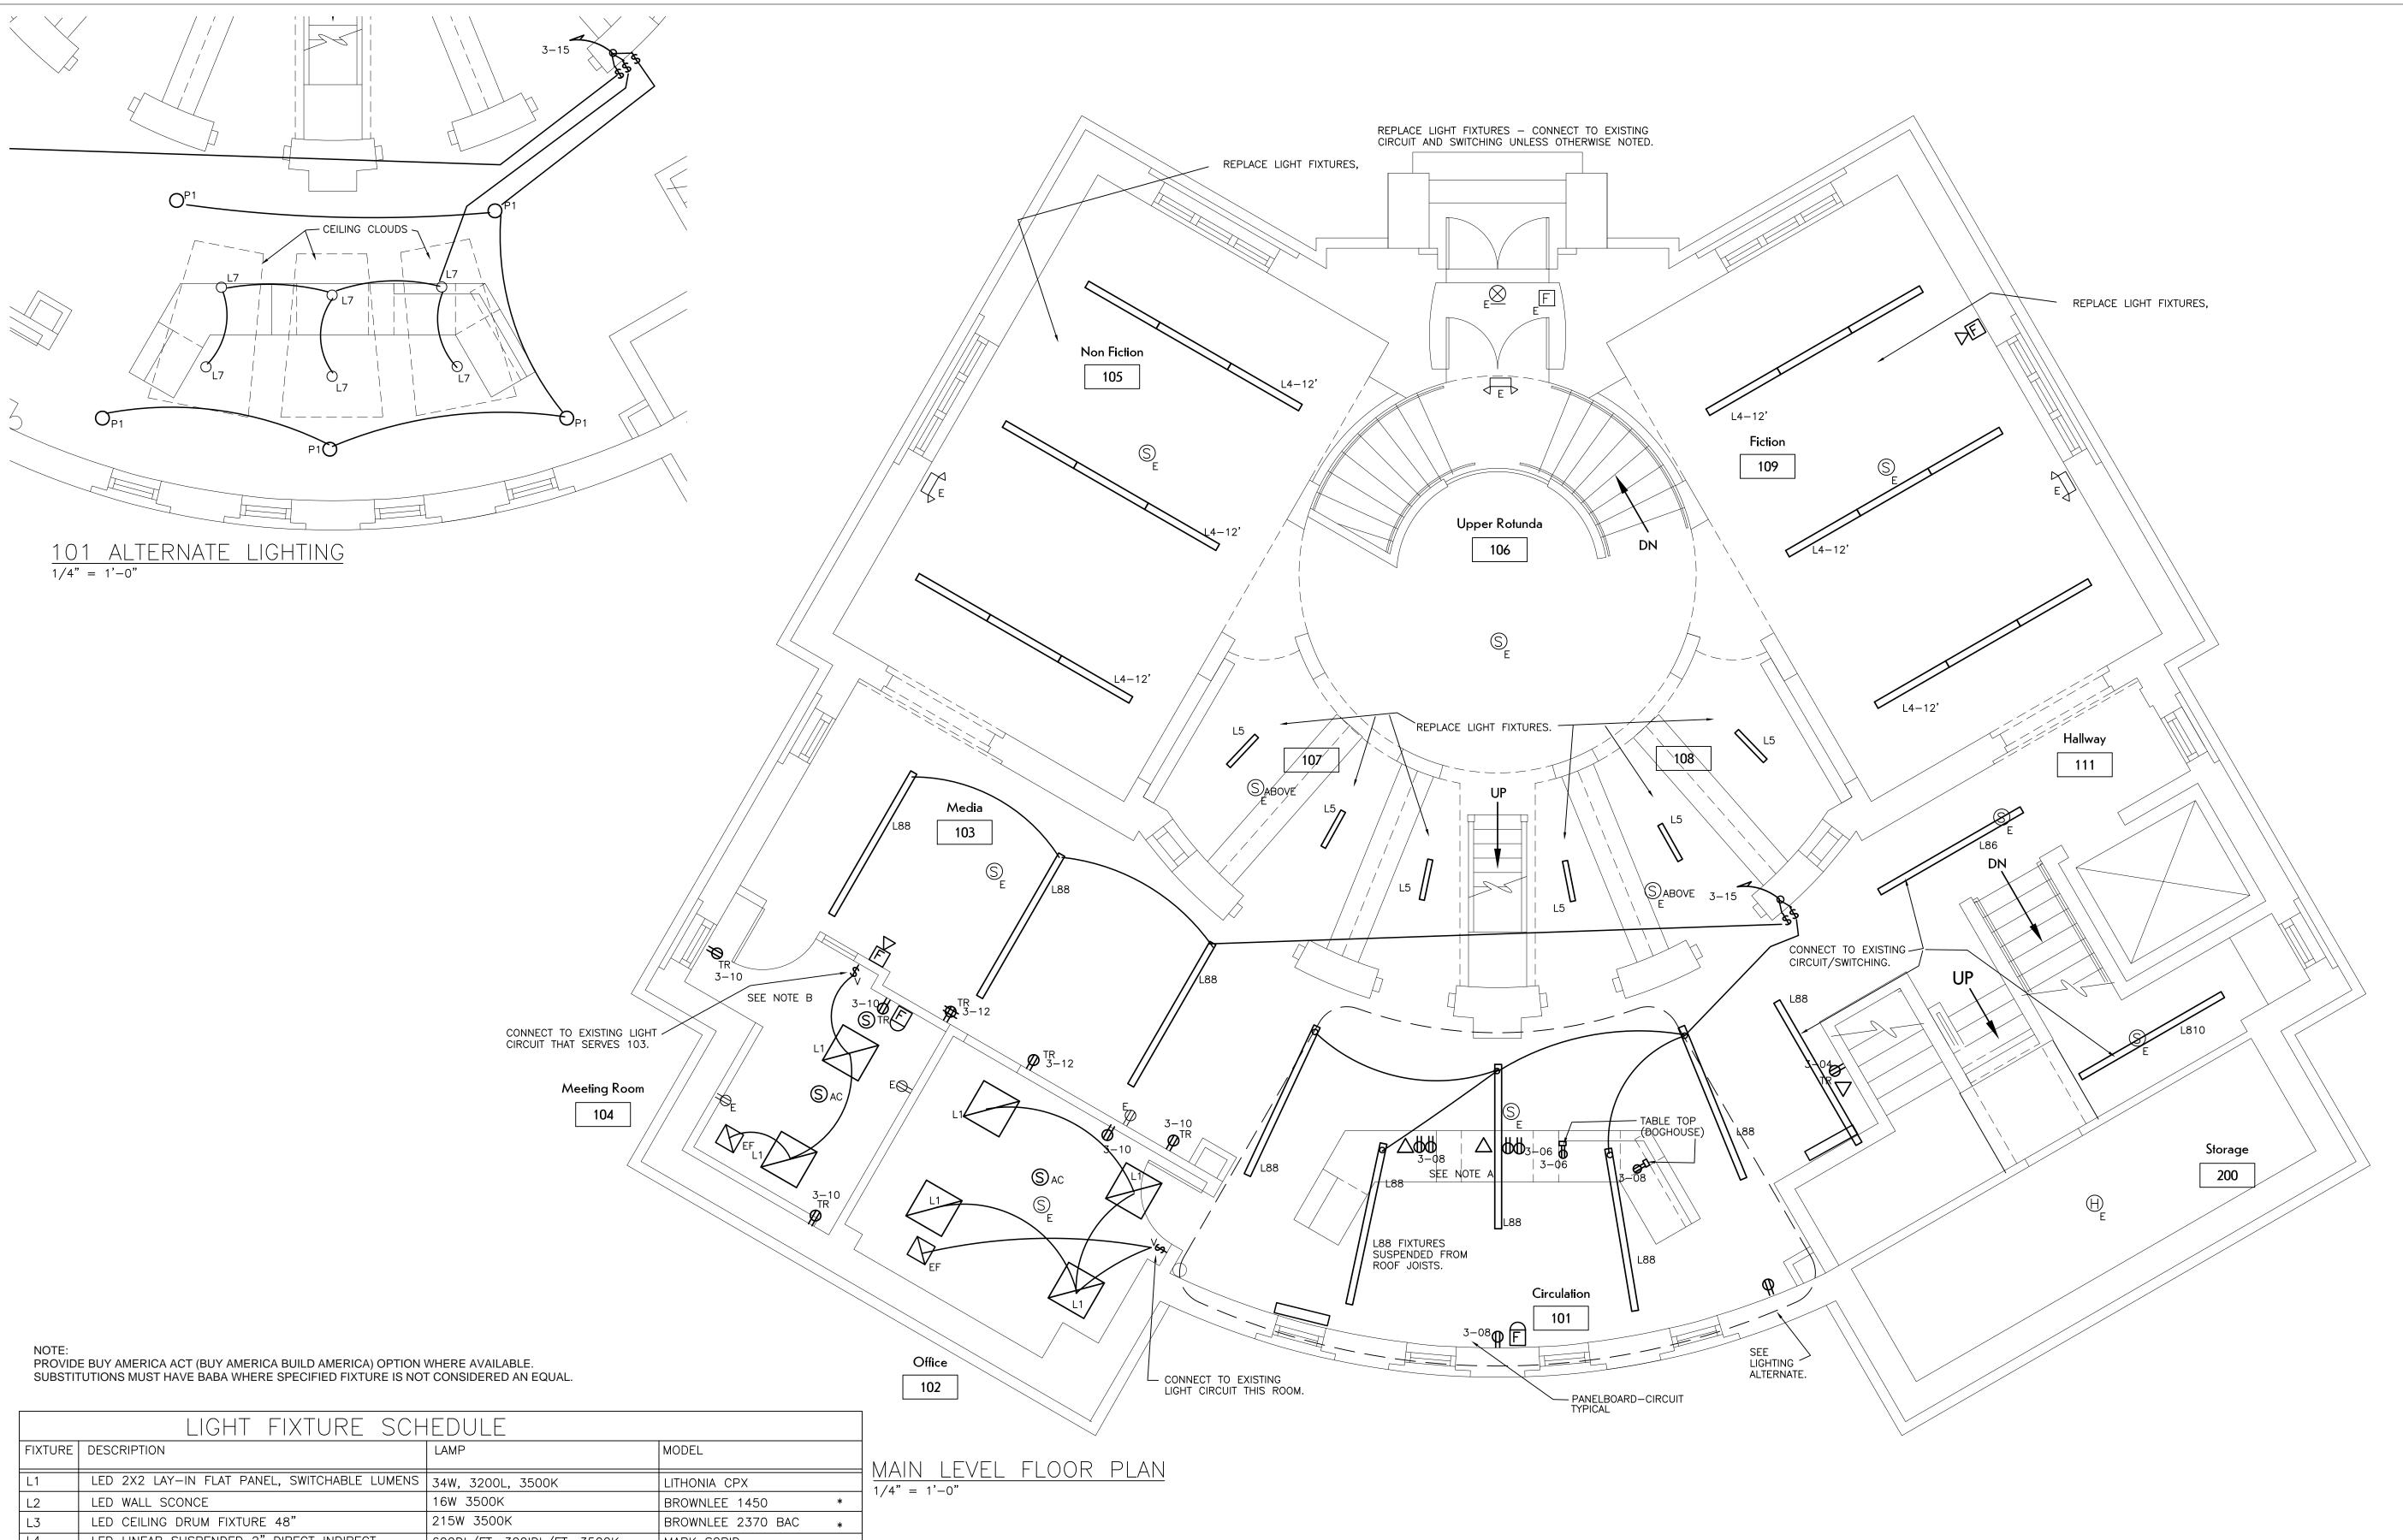


LED LINEAR SUSPENDED 2" DIRECT INDIRECT 600DL/FT, 300IDL/FT, 3500K MARK S2PID 22W, 2500L, 3500K LED LINEAR SURFACE 24" LOW PROFILE LITHONIA ZL1D LED 2X4 LAY-IN FLAT PANEL DIMMABLE 34W, 3200L, 3500K LITHONIA CPX LED 96" SUSPENDED LINEAR 50W, 6000L, 3500K LITHONIA LL LED 96" SUSPENDED LINEAR 66W, 8000L, 3500K LITHONIA LL LED 96" SUSPENDED LINEAR 79W, 10000L, 3500K LITHONIA LL LED 48" STRIP DROP LENS LITHONIA ZL1D LED PENDANT 3500K GOTHAM IVO 3500K LED DOWN LIGHT 4" GOTHAM IVO EXIT - LED, BATTERY LITHONIA LQM S WR ELN SD EXIT/EMERGENCY LIGHT - LED LITHONIA LHQM LED R SD EMERGENCY FIXTURE LITHONIA ELM2 LED SD

120V UNLESS OTHERWISE NOTED SPECIFIED FIXTURES REPRESENT MIN. EFFICIENCIES

COORDINATE WITH CEILING TYPE (LAY-IN CEILINGS, DRYWALL CEILINGS).



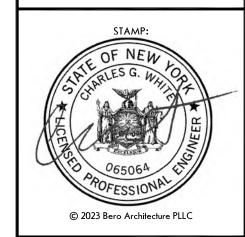

(585) 262-2035 | www.beroarchitecture.com

STRUCTURAL ENGINEER:



Rochester, NY 14609

1653 East Main Street

MEP/FP ENGINEER:



315 Rockingham Street Rochester, NY 14620

DRAWINGS, SPECIFICATIONS AND OTHER DOCUMENTS, INCLUDING THOSE IN ELECTRONIC FORM, PREPARED BY BERO ARCHITECTURE PLLC ARE INSTRUMENTS OF SERVICE FOR USE SOLELY WITH RESPECT TO THE PROJECT FOR WHICH THEY WERE CREATED. THE ARCHITECT RETAINS ALL COMMON LAW STATUTORY AND OTHER RESERVED RIGHTS, INCLUDING COPYRIGHT.

FOR ARCHITECTURAL DRAWINGS AND ELECTRONIC MEDIA, IT IS A VIOLATION OF TITLE VII, PART 69.5(B) OF THE NEW YORK STATE EDUCATION LAW FOR ANY PERSON, UNLESS ACTING UNDER THE DIRECTION OF A LICENSED ARCHITECT TO ALTER THIS DRAWING. IF ALTERED, SUCH ARCHITECT SHALL AFFIX THEIR SEAL, SIGNATURE, THE DATE, THE NOTATION "ALTERED BY". AND THE SPECIFIC DESCRIPTION OF THE ALTERATION.

WHERE DRAWINGS, ON PAPER OR ELECTRONIC MEDIA, SHOW EXISTING, NEW, AND/OR PROPOSED WORK AND CONDITIONS, IT IS UNDERSTOOD THAT IT IS SO SHOWN AS A MATTER OF INFORMATION AND THAT INFORMATION TO BE SUBSTANTIALLY CORRECT, SHALL MAKE THEMSELVES FAMILIAR WITH ALL CONDITIONS AFFECTING THE NATURE AND MANNER OF THEIR WORK INCLUDING VERIFICATION OF ALL AND/OR NEW WORK AND CONDITIONS.

Date Description



Town of Warsaw 83 Center Street Warsaw, NY 14569

PROJECT INFORMATION:

Design Develpment Warsaw Public Library 130 North Main Street, Warsaw, New York

PROJECT NUMBER: 22120 ISSUE DATE: 4/25/2025 DRAWN BY:

SHEET TITLE:

MAIN LEVEL

SHEET NUMBER:

SHEET SCALE 1" K